# IDEA PUBLIC SCHOOLS ENVELOPE IMPROVEMENTS DONNA PHASE 2 - RIO GRANDE VALLEY

#### IDEA Public Schools Board of Directors 2025

## IDEA Public Schools Senior Leadership 2025

Collin Sewell	Chair	Collin Sewell	Acting Chief Executive Officer
Ed Rivera	Vice-Chair / Treasurer	Dr. Jeff Cottrill	Superintendent
Ryan Vaughan	Secretary	Layne Fisher	Chief Operating Officer
Reba Cardenas McNair	Member	Philip Garza	Chief College and Diversity Officer
David Earl	Member	Martin Winchester	Chief Human Assets Officer
Erich Holmsten	Member	Dolores Gonzalez	Chief Program Officer
Michael Adams	Member	Leanne Hernandez	Chief Financial Officer
Gary Lindgren	Member	Cody Grindle	Chief Information Officer
Theresa Barrera-Shaw	Member	Jessica Hess	Chief Compliance and Administrative Officer
Nanette Cocero	Member	Jill Dominguez	Regional Superintendent

## DRAWING INDEX


#### IDEA DONNA

COVER	COVER SHEET	F2.01	BUILDING F - ROOF PLAN
		F5.01	<b>BUILDING F - ELEVATIONS</b>
A1.01	SITE PLAN		
		G2.01	BUILDING G - ROOF PLAN
B2.01	BUILDING B - ROOF PLAN	G5.01	BUILDING G - ELEVATIONS
B5.01	BUILDING B - ELEVATIONS		
		A3.01	ROOF DETAILS
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E5.01	BUILDING E - ELEVATIONS	11	DOORDENALS
22.01	BOILDING E LEEVITIONS	A6.01	DOOR AND WINDOW ELEVATIONS
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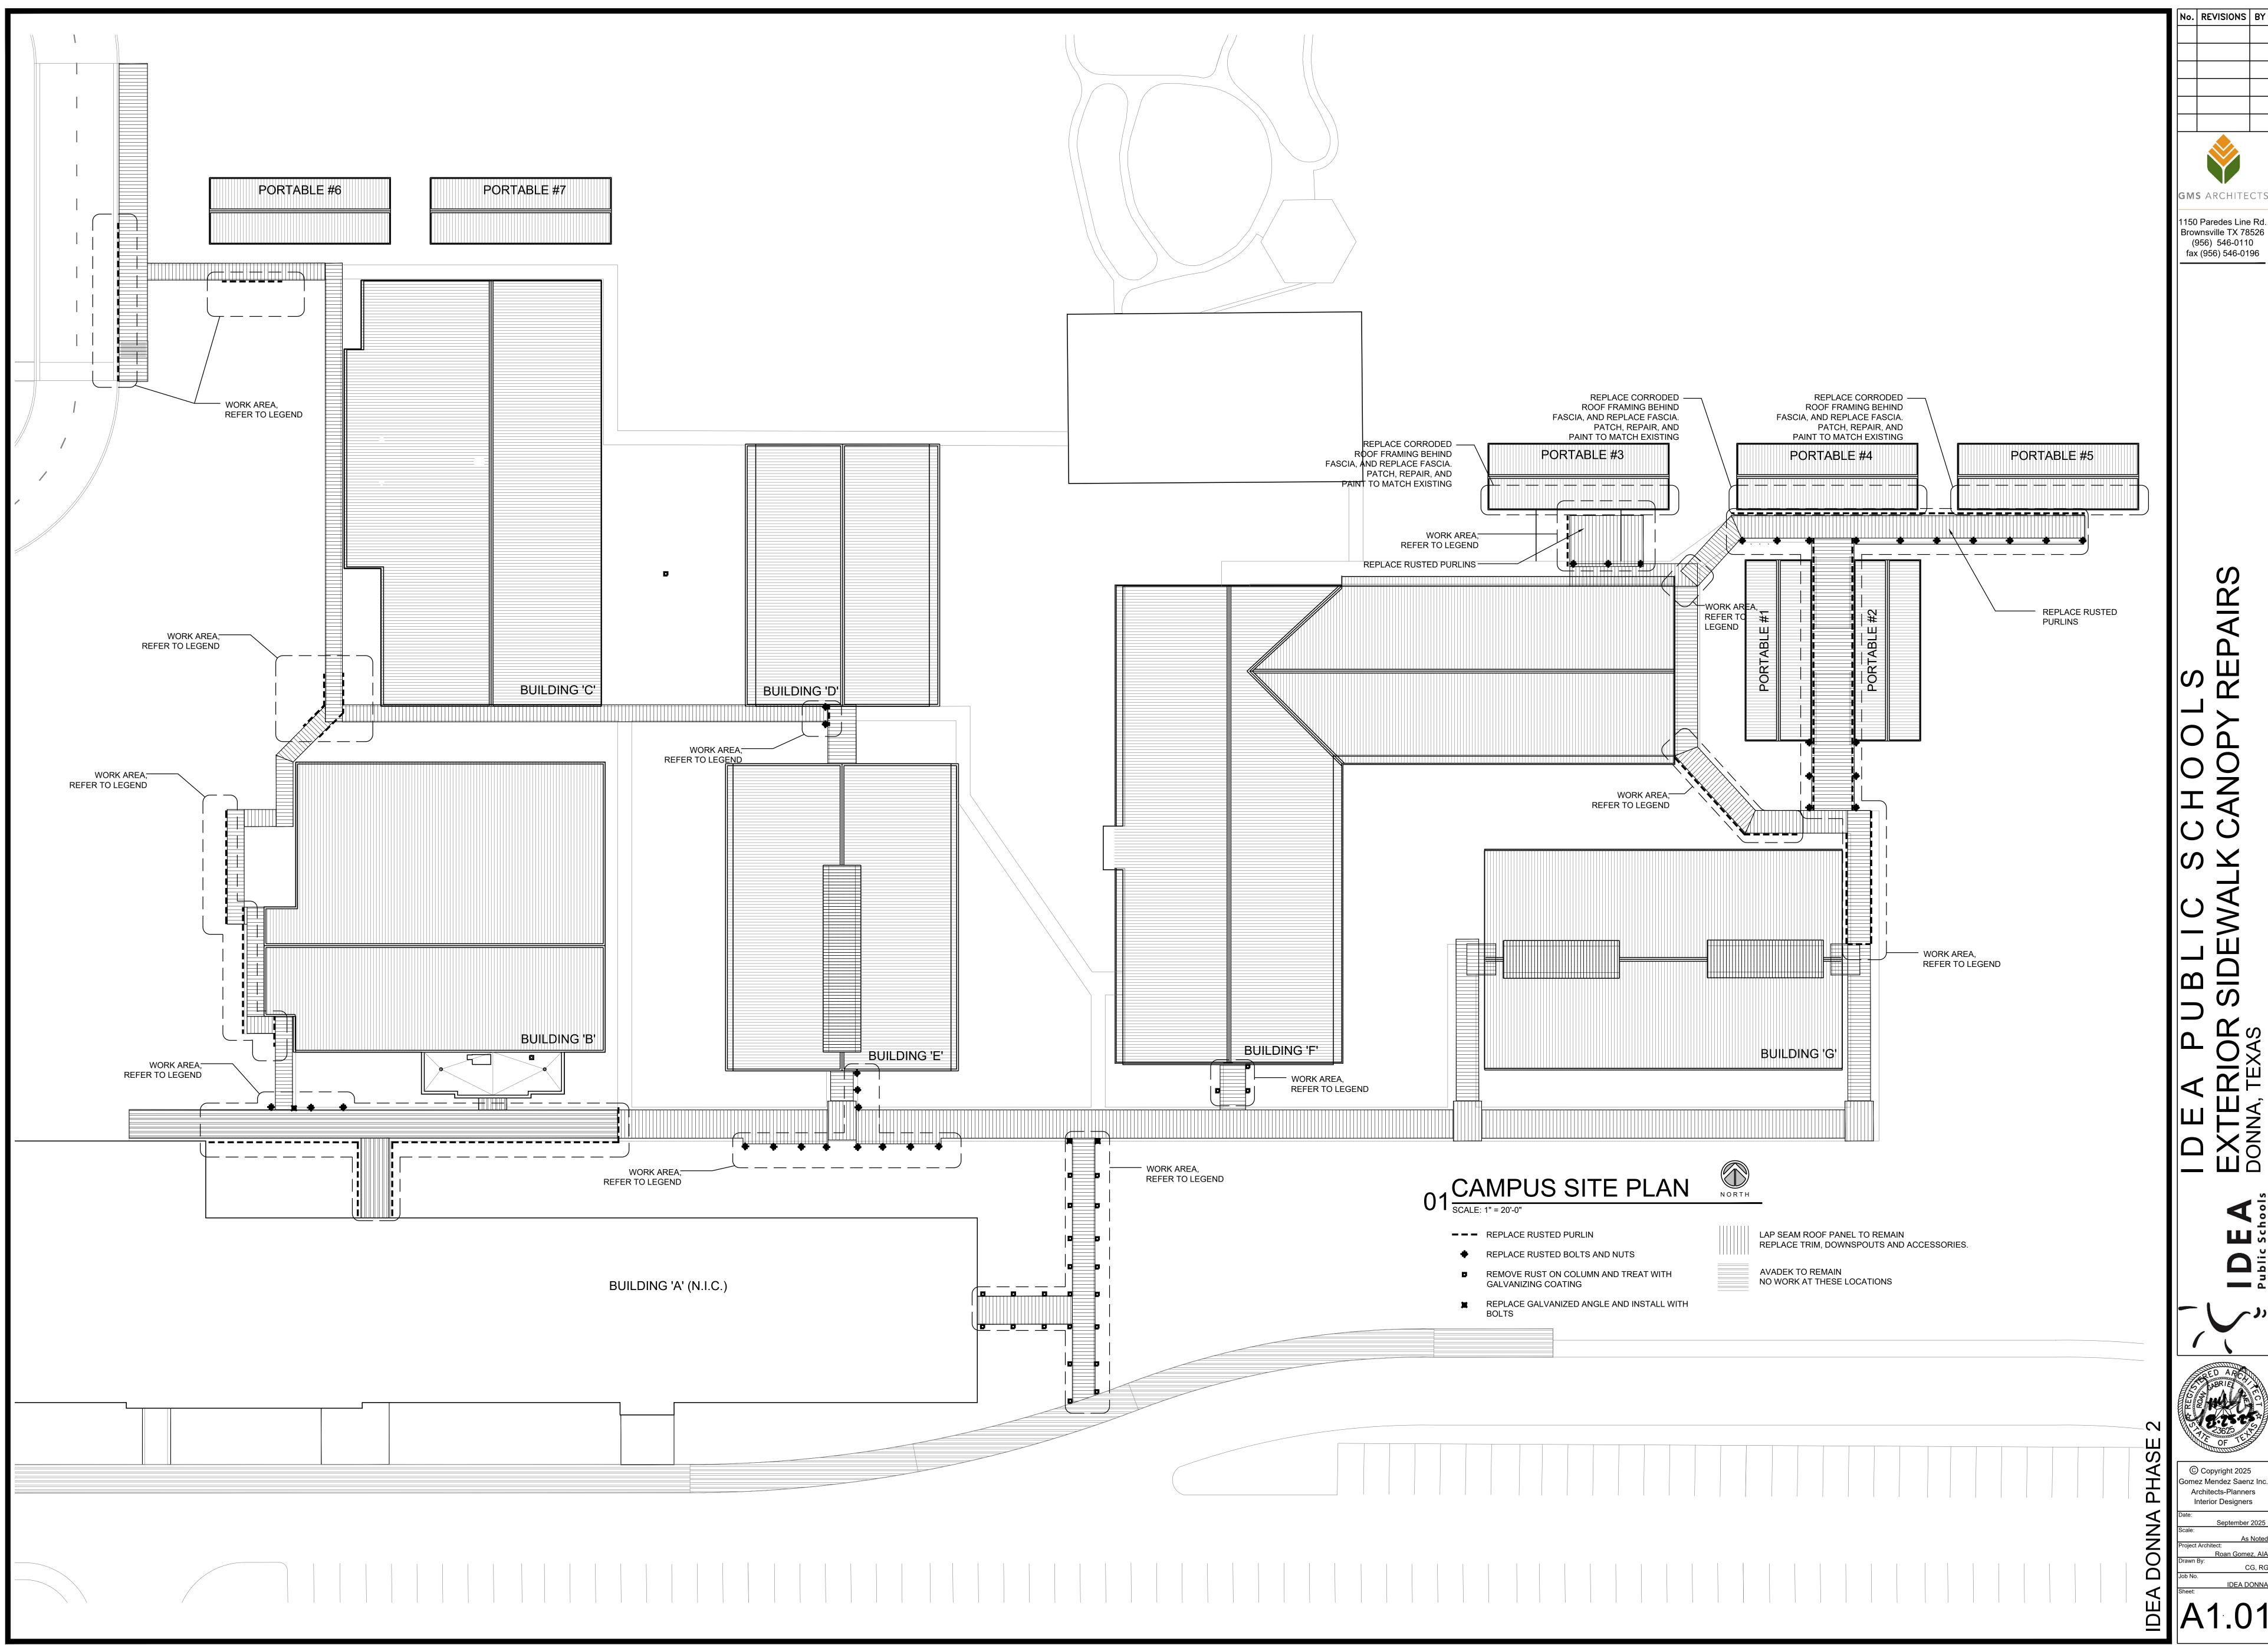
#### ARCHITECTS

#### GOMEZ MENDEZ SAENZ, INC.

1150 PAREDES LINE RD. BROWNSVILLE, TX. 78521 PH. (956) 546-0110 FAX. (956) 546-0196



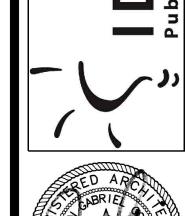




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# **KEYED NOTES**

01 PAINT PLASTER, TYP.

REPLACE HORIZONTAL AND/OR VERTICAL, OR CORNER PLASTER BEADS.
REFER TO DETAILS: 01, 02, 03, 05, 06, 09/A4.01
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06 RE-SEAL ALL WALL EXTERIOR PENETRATIONS, TYP.
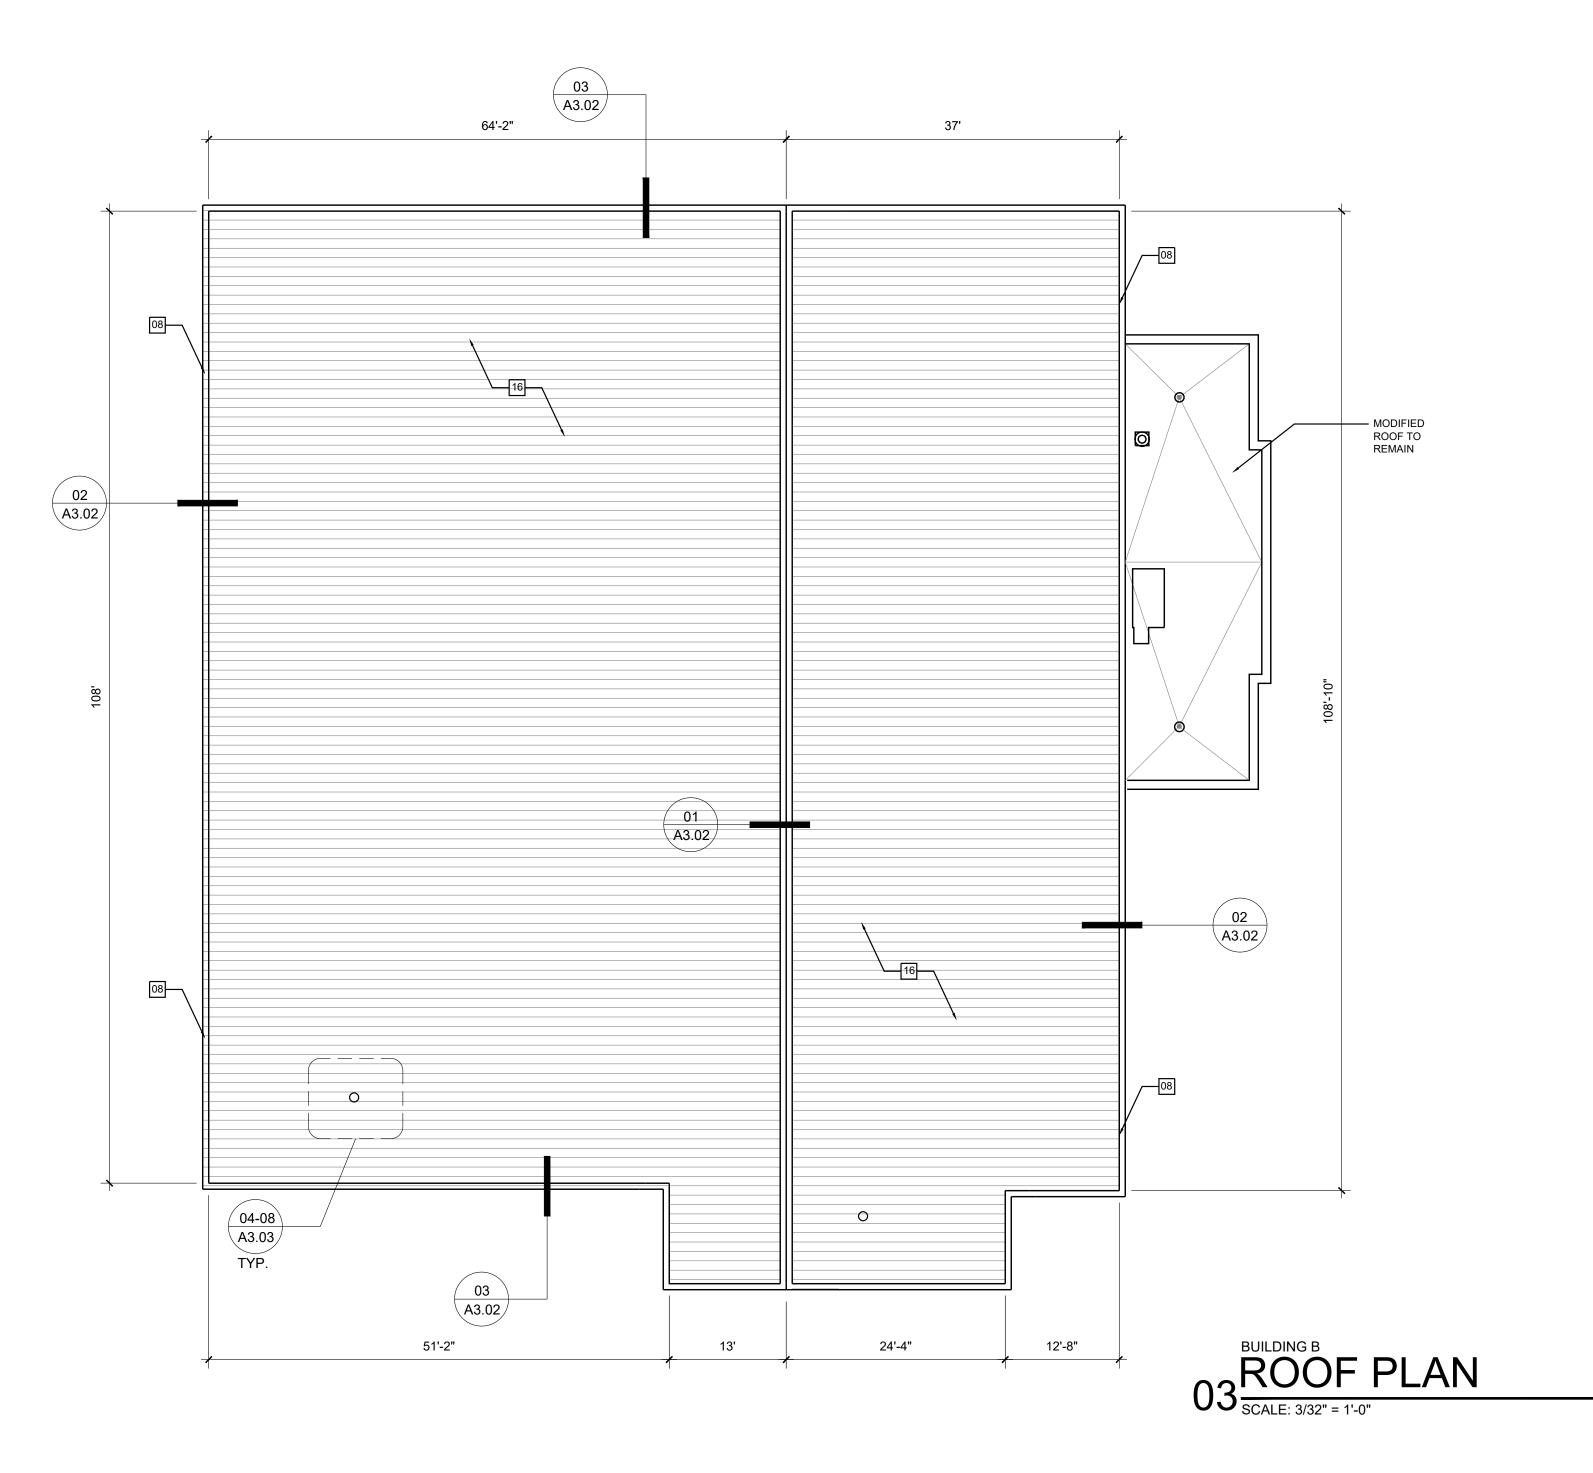
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INSTALL METAL ROOF RECOVER OVER EXISTING ROOF AS SPEC'D


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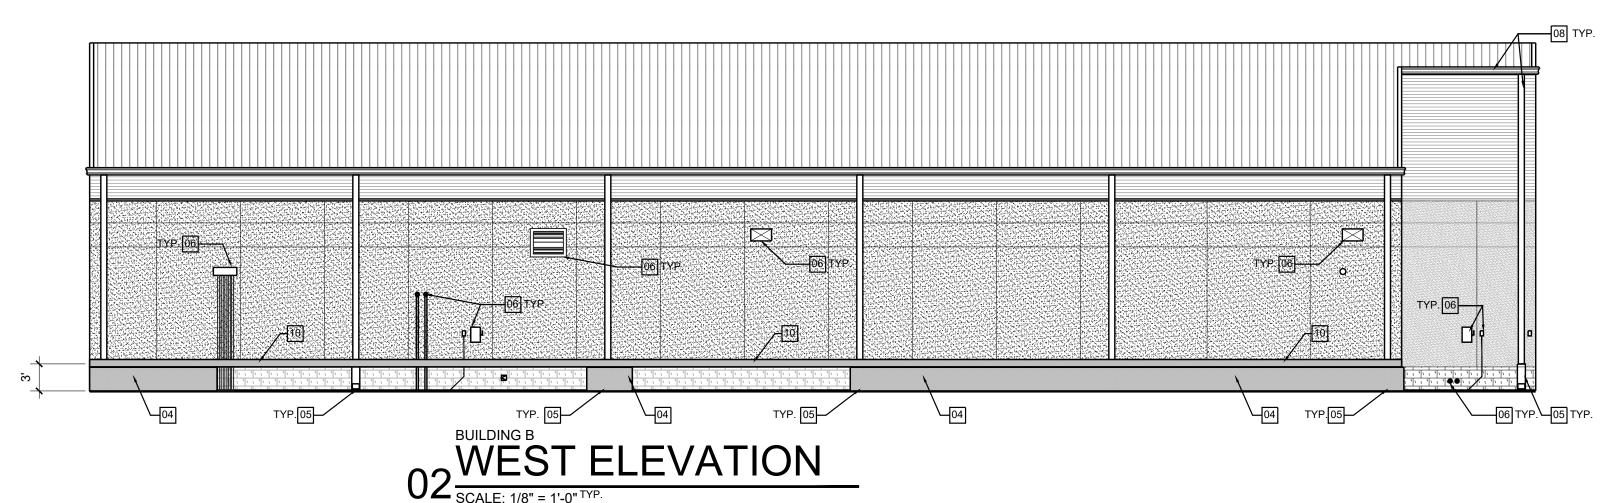
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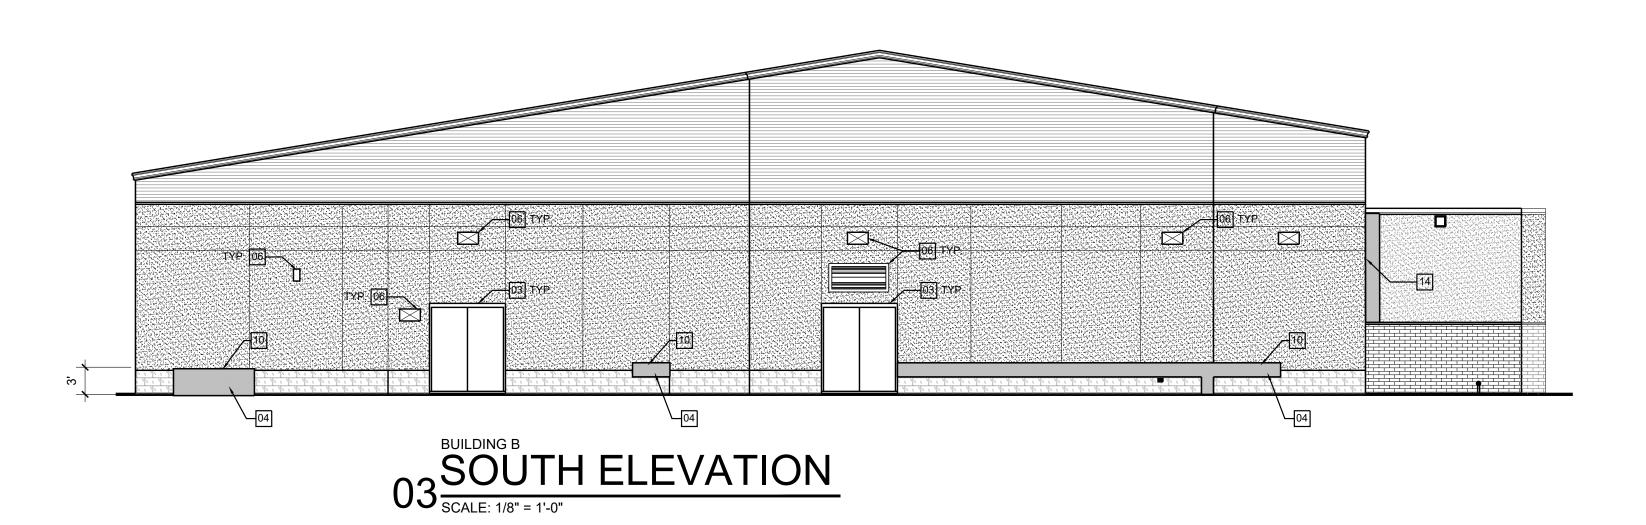
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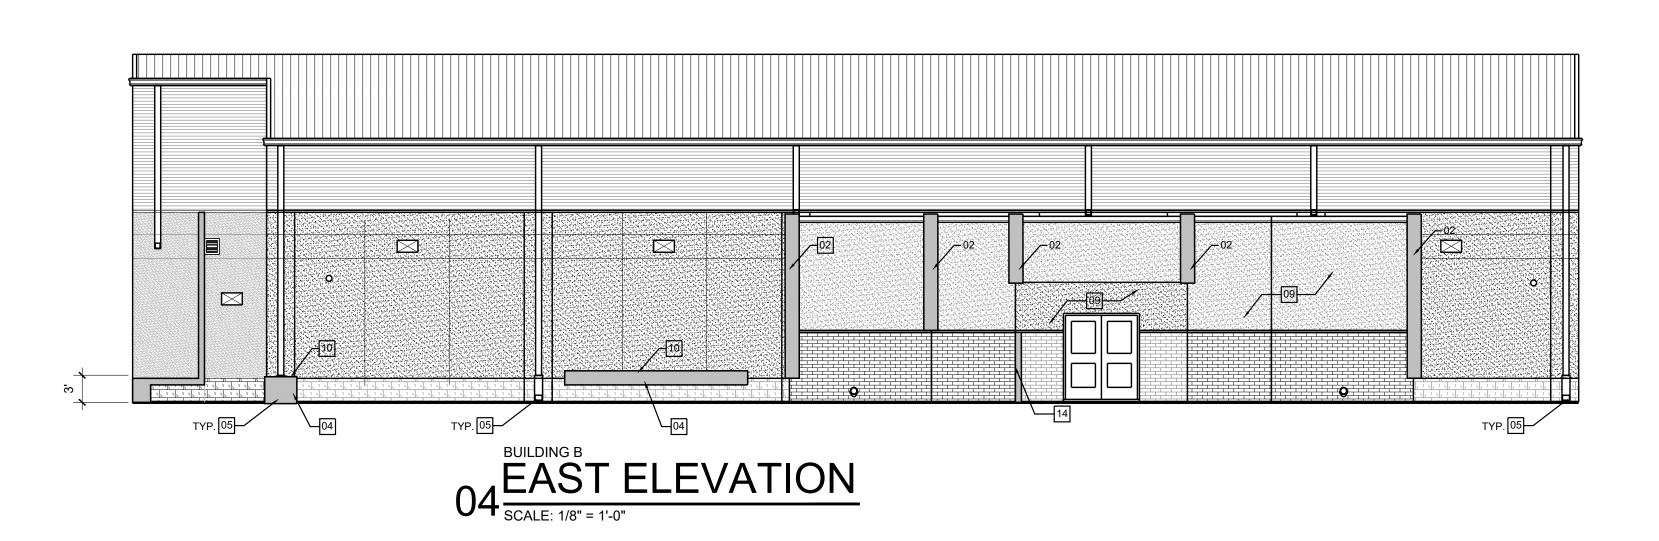
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ALTERNATE 1

LEGEND

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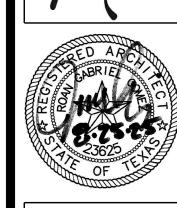
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02 A3.02

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IDEA PUBLIC SCHOOLS EXTERIOR FACILITY IMPROVEMENTS

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# DED ARCHARGE CITY OF TELES
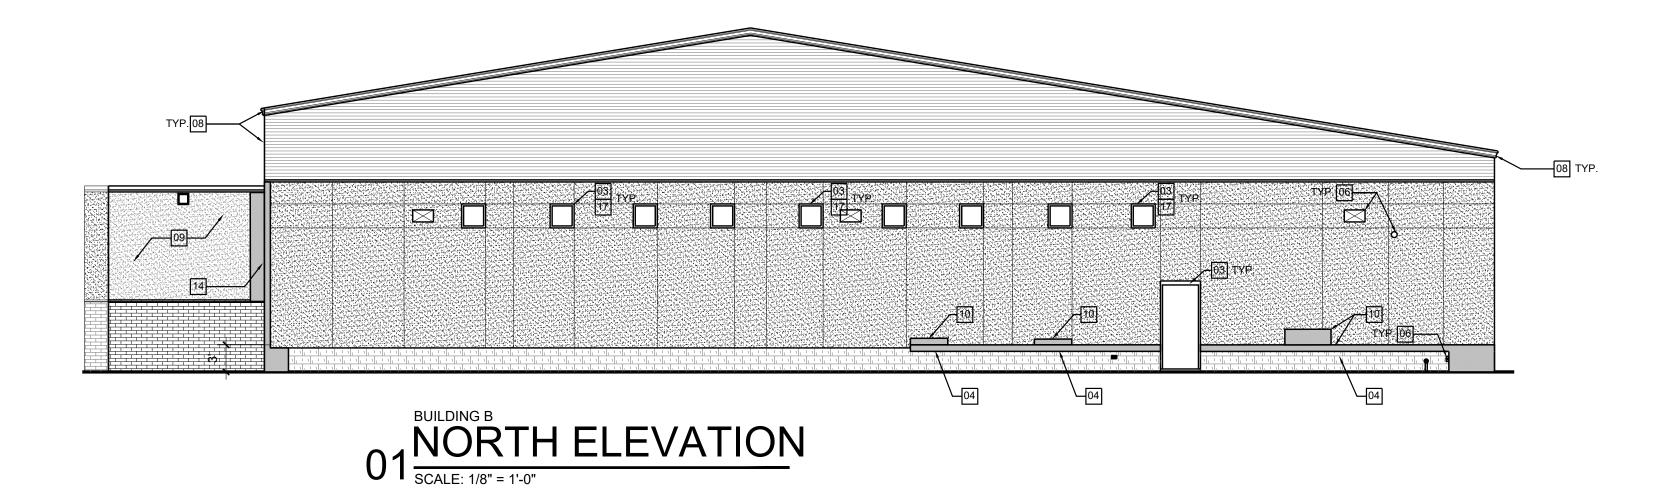
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Date:
September 2025
Scale:
As Notect
Project Architect:
Roan Gomez, ALA
Drawn By:

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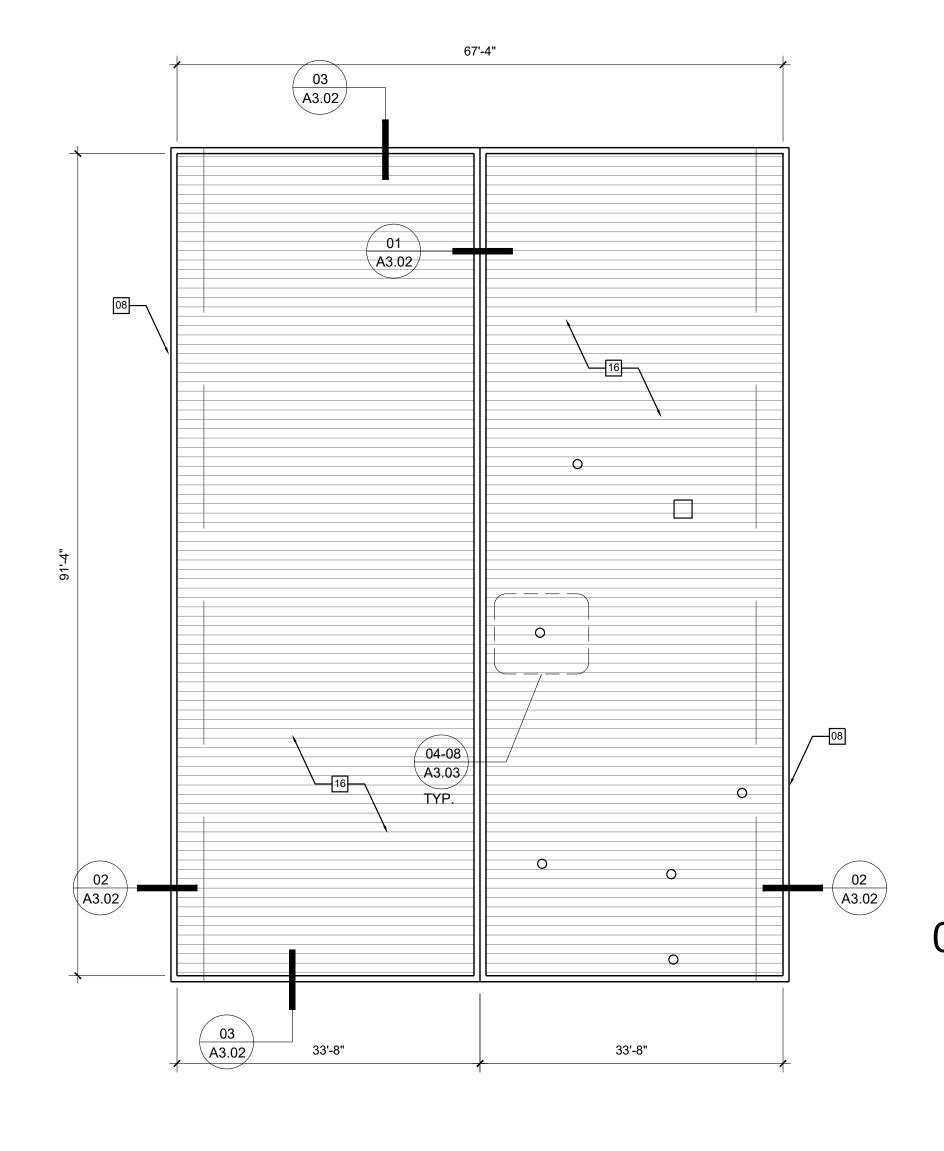
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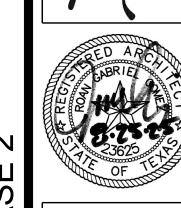
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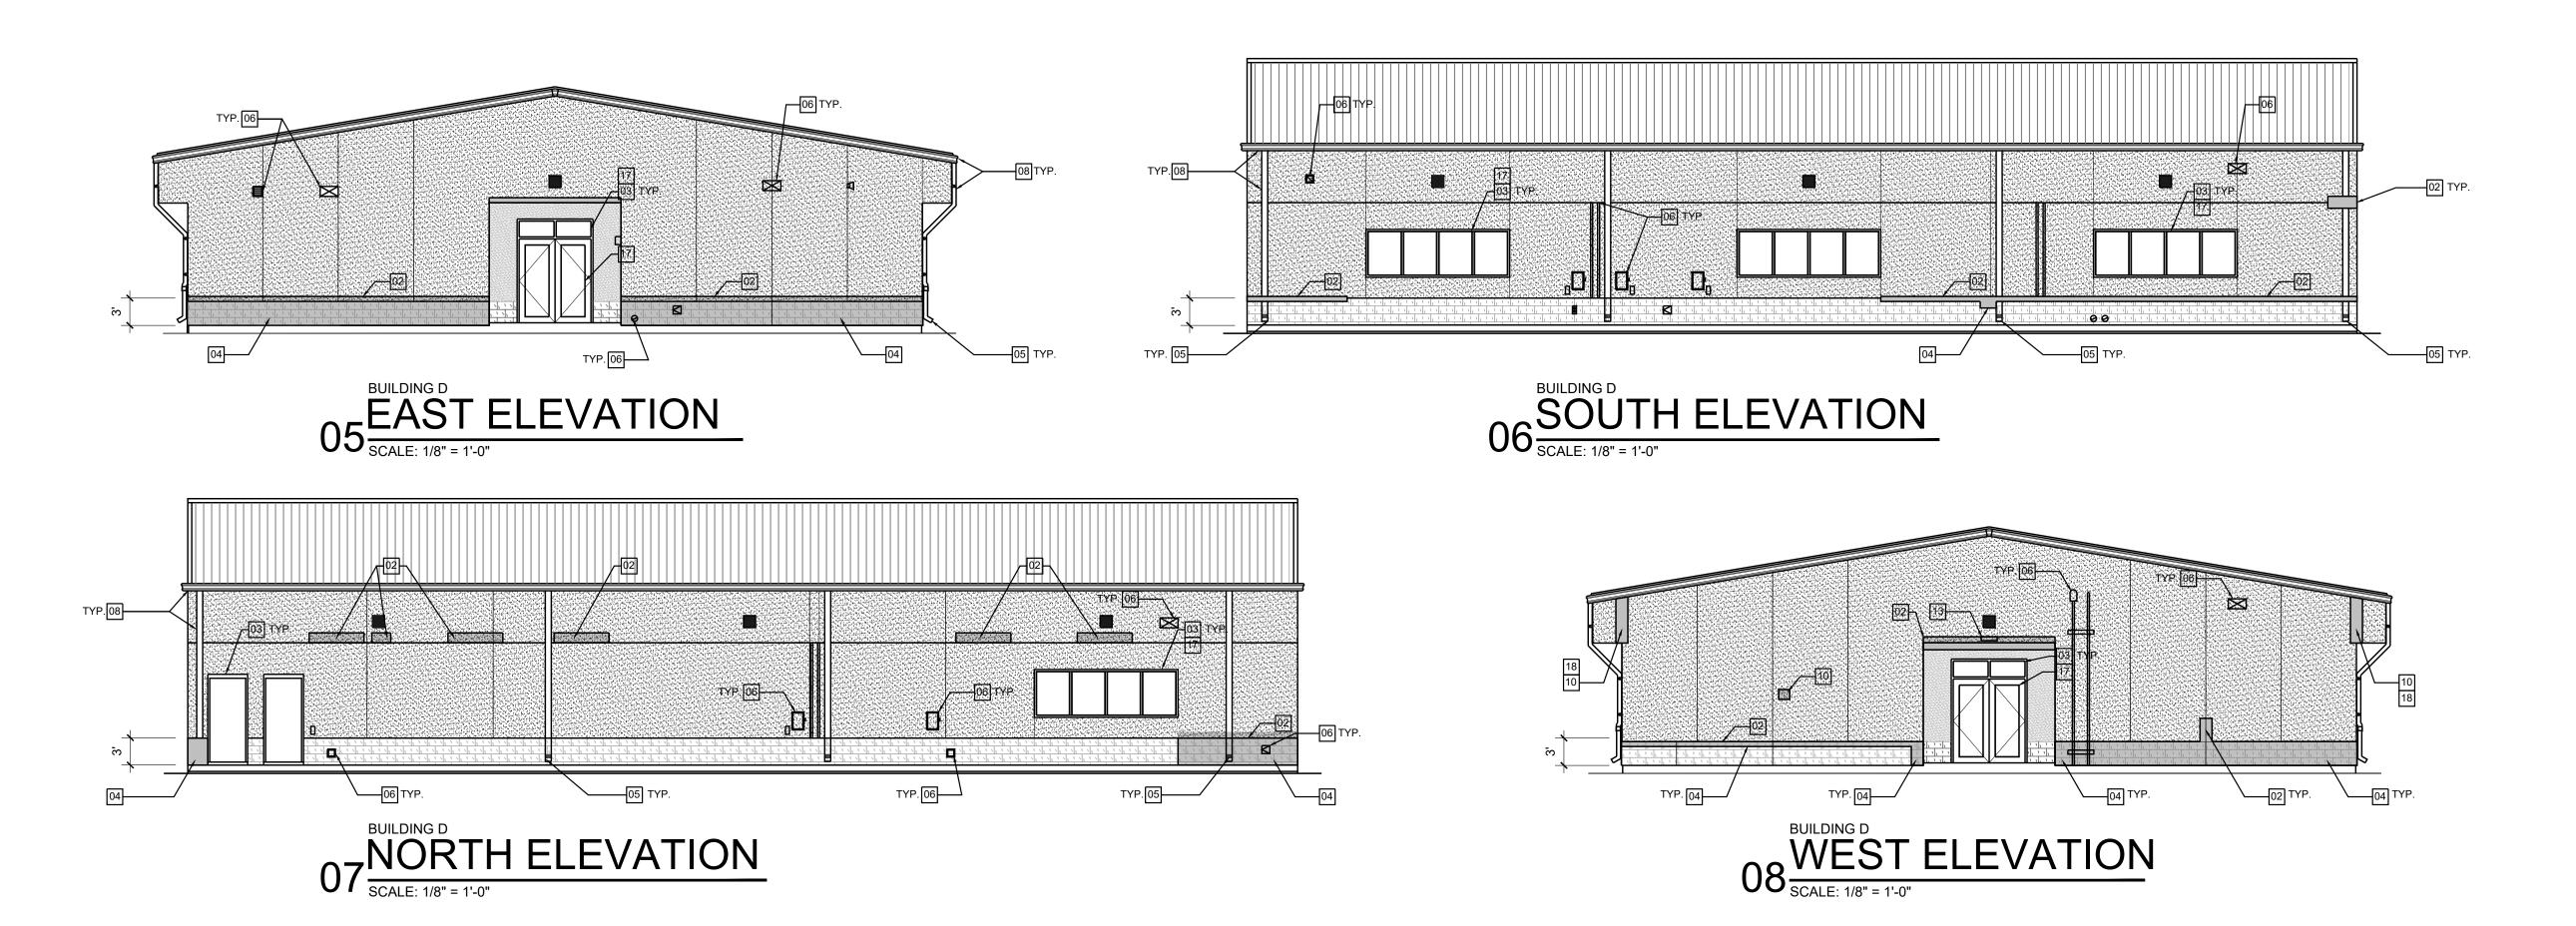
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LEGEND

INDICATES WORK AREA

**ALTERNATE 1** 

**ALTERNATE 2** 

STONE. SEE DETAILS 12,13 A/4.01

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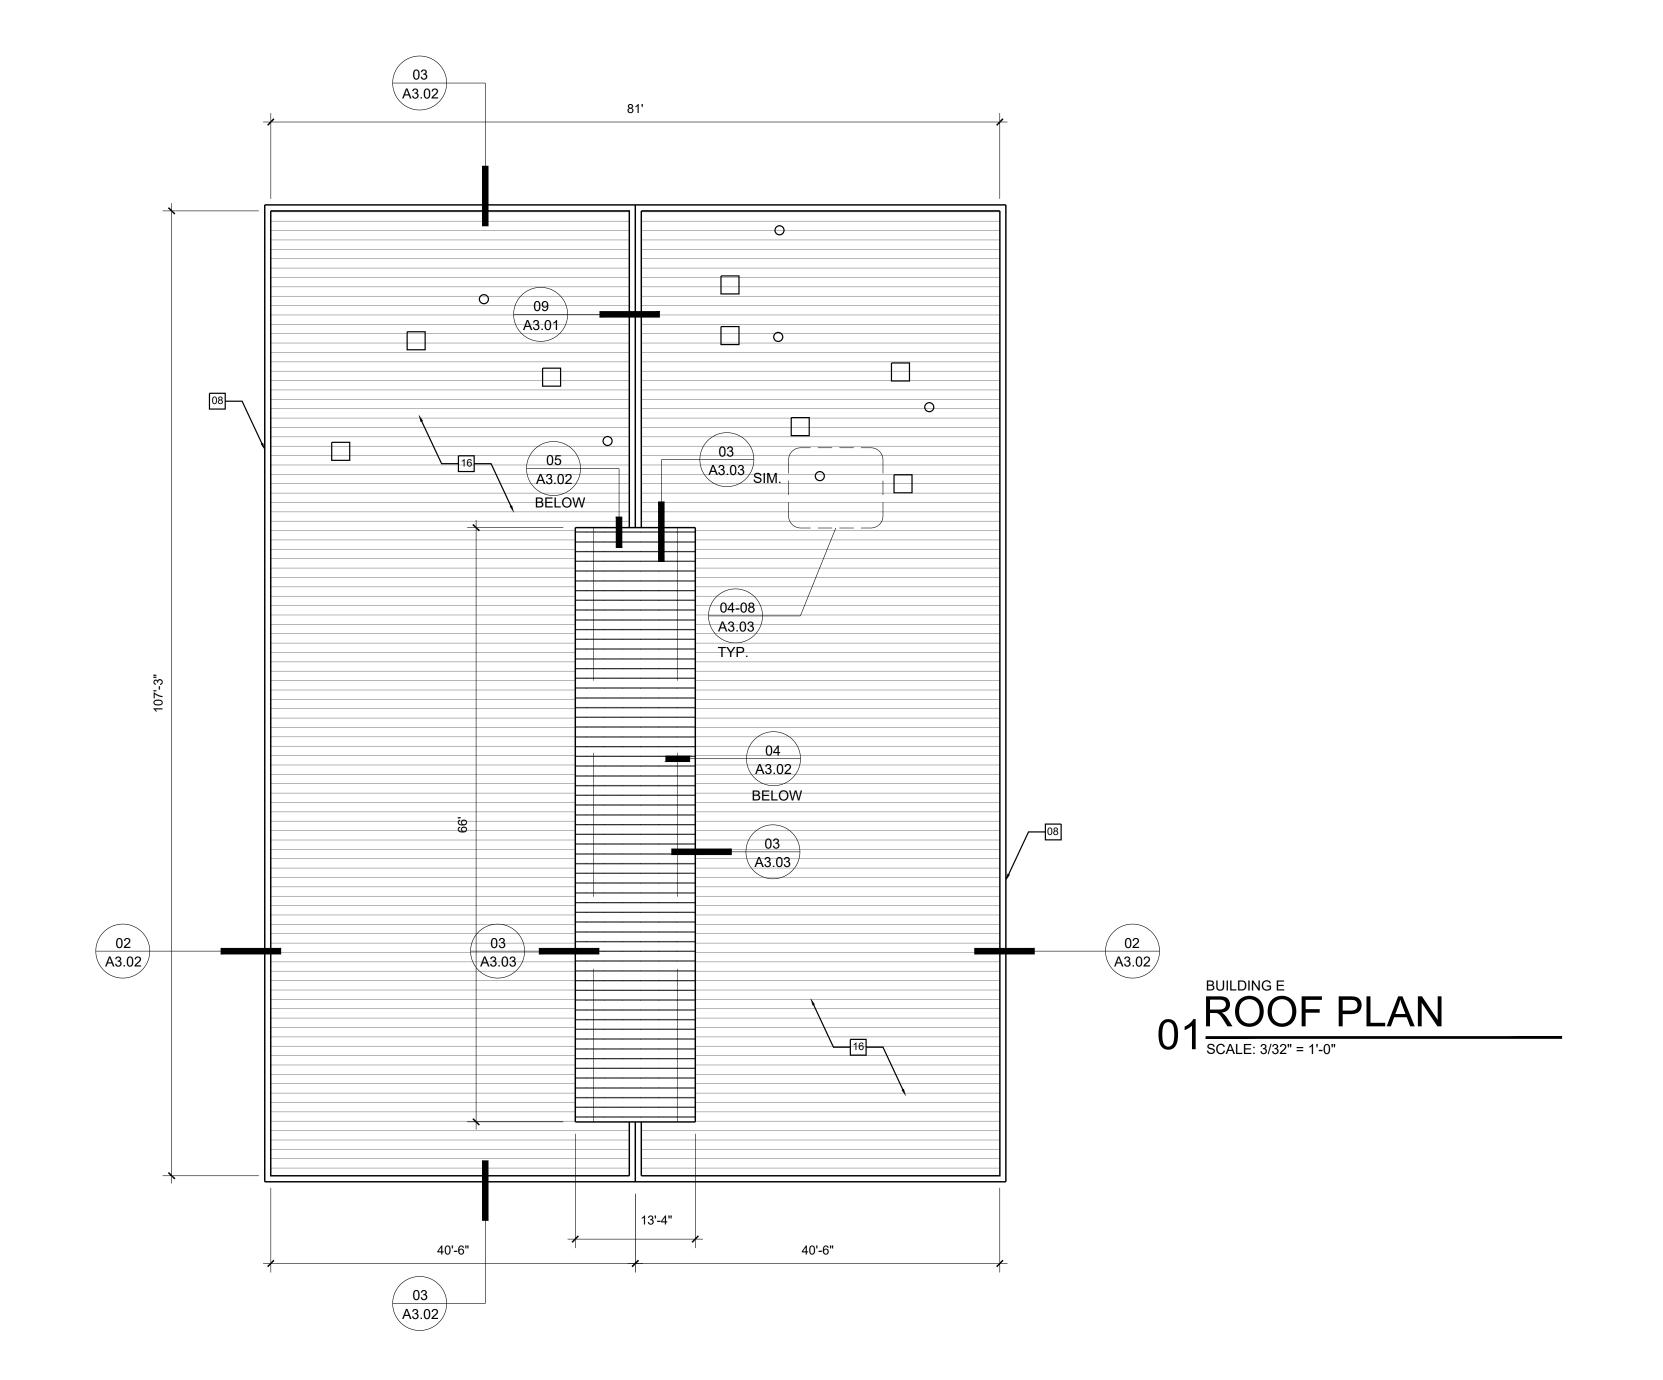
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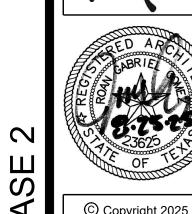
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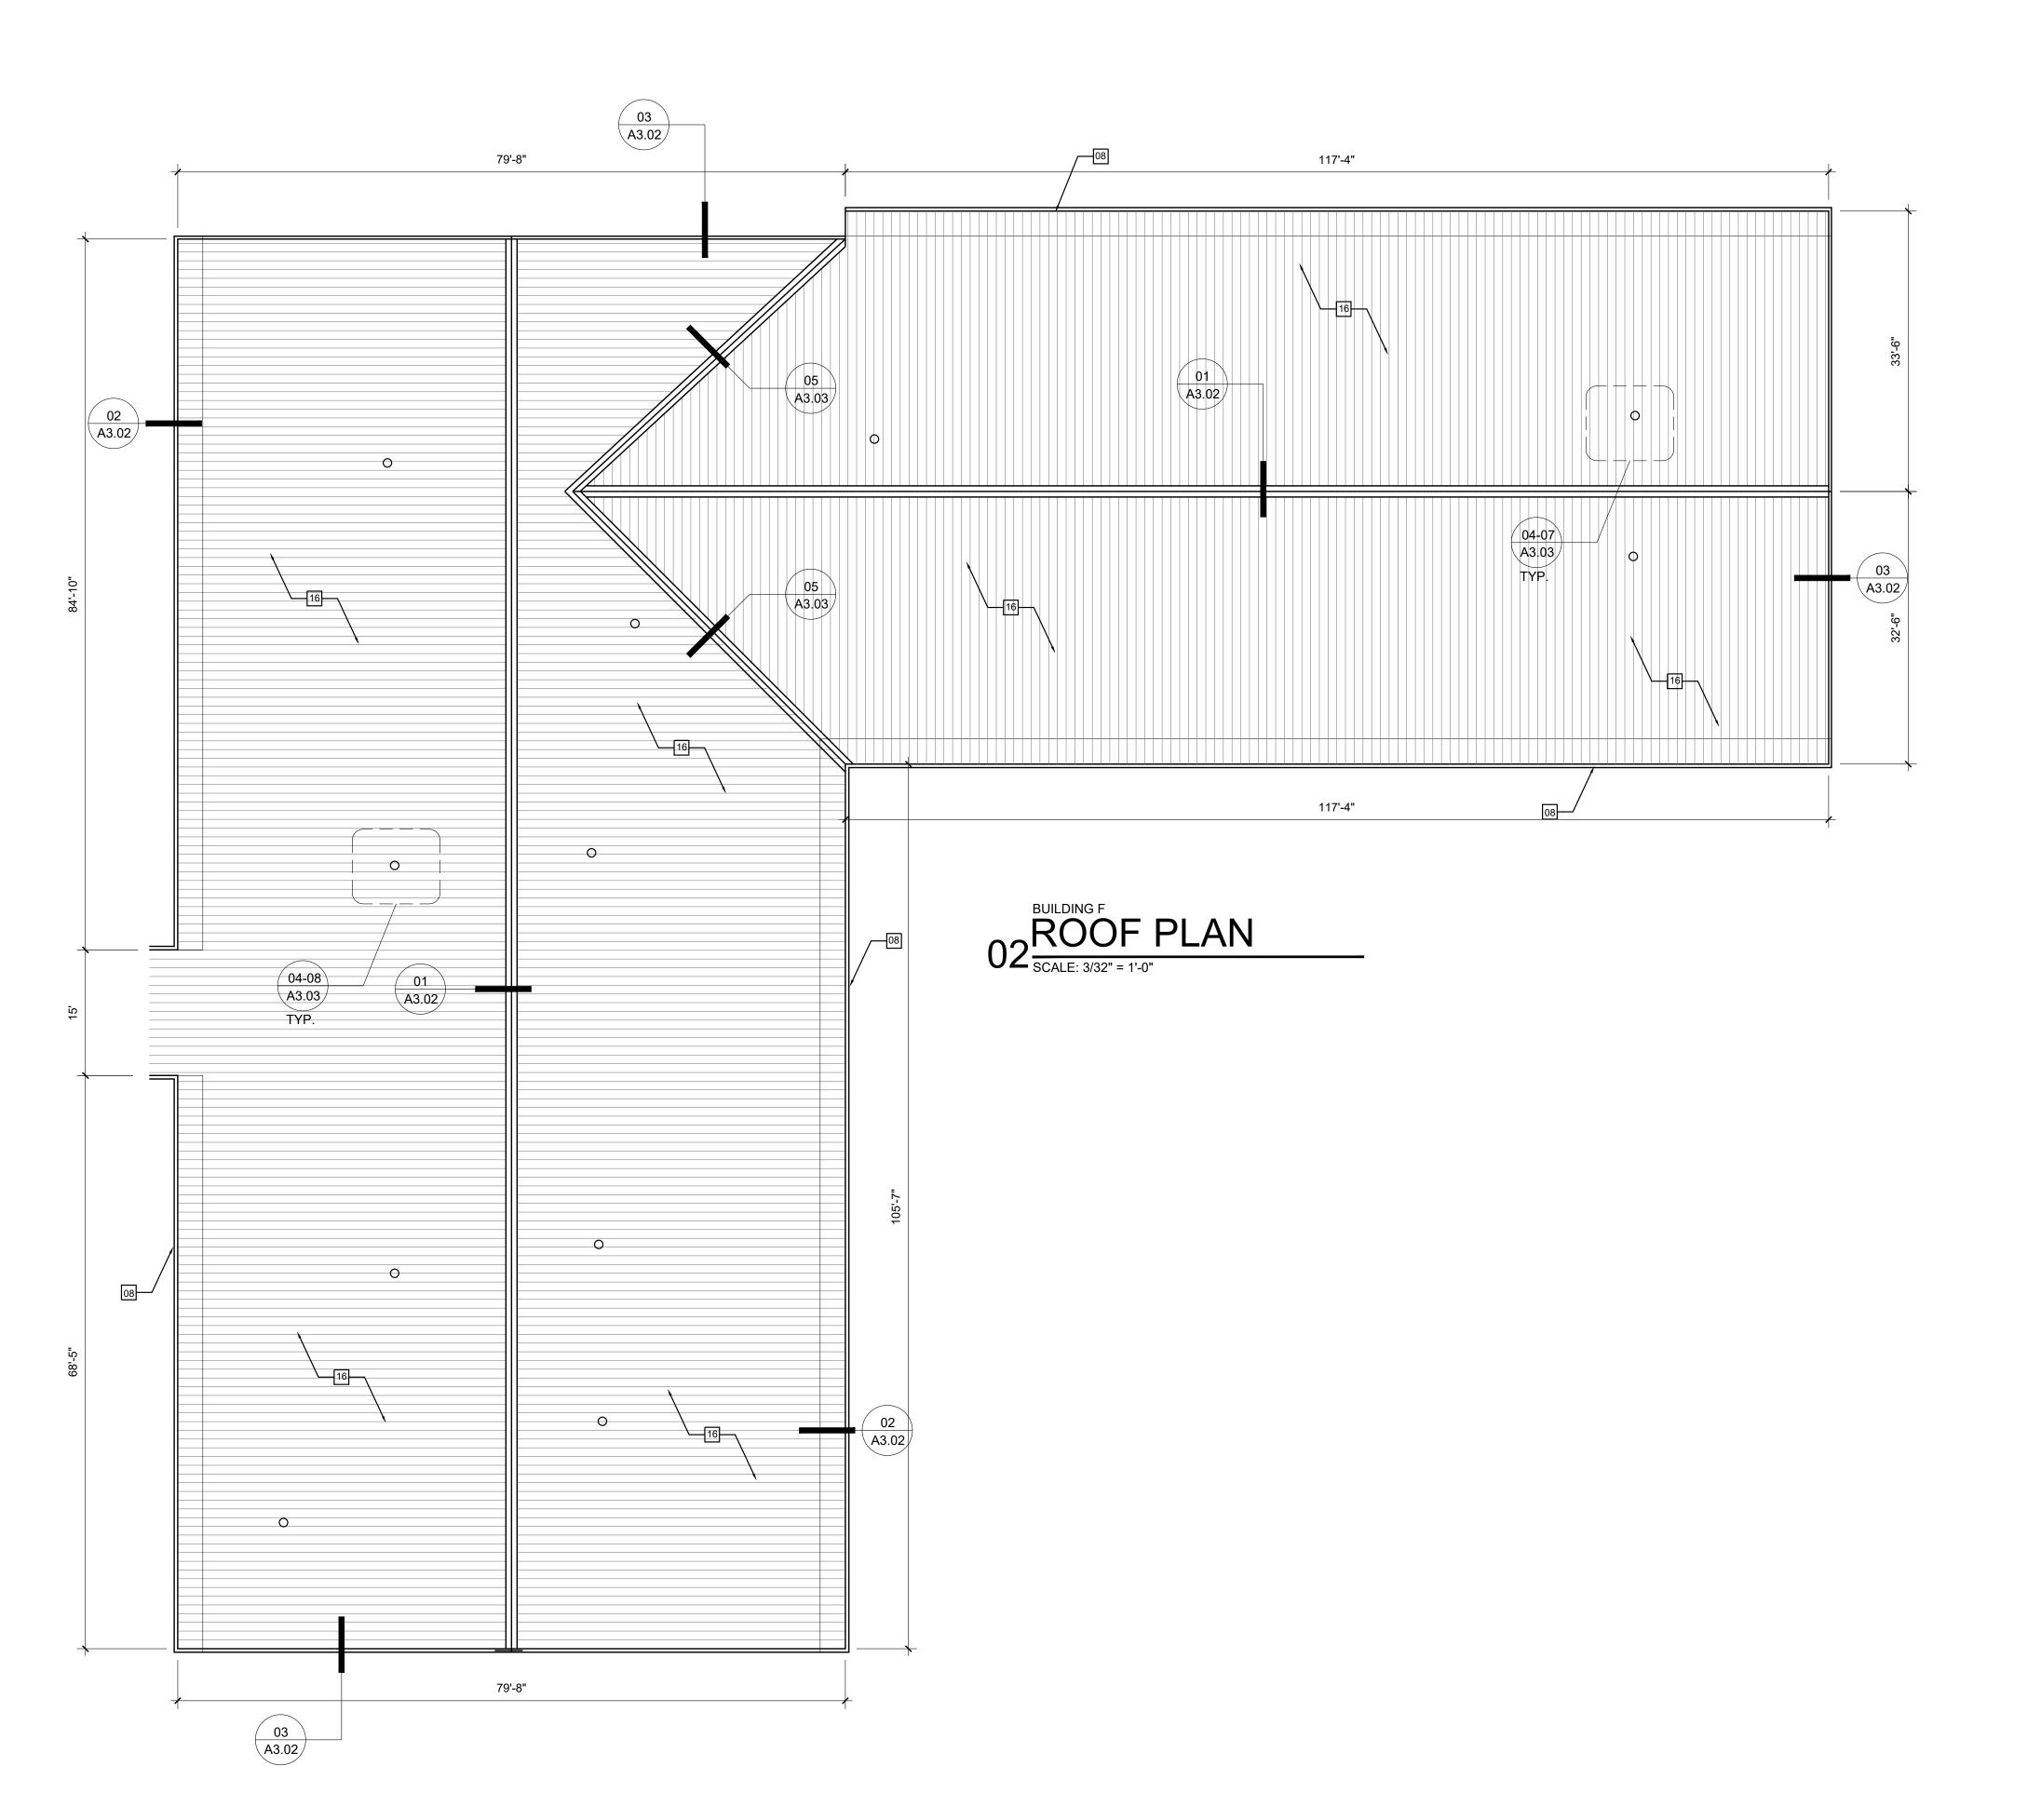
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13 RE-SEAL AROUND COVE LIGHT, PENETRATION, TYP.

REPLACE PLASTER BEADS AND/OR PLASTER ON INSIDE CORNER OR UNDERSIDE 15 GROUT BENCH ON WING WALL, AND RE-ATTACHE STONE (BOTH SIDES)

16 INSTALL NEW ROOF RECOVER SYSTEM AS SPECIFIED

17 REMOVE AND REPLACE WINDOW GASKETS WITH NEW ONES, TYP.

CONTRACTOR TO ACCOUNT FOR SHEATHING REPLACEMENT AT SELECT REPAIR AREAS THAT OVERHANG BUILDING

ROOF: SCOPE OF WORK

INSTALL METAL ROOF RECOVER OVER EXISTING ROOF AS SPEC'D


IF ANY PURLINS OR ROOF STRUCTURE ARE FOUND TO HAVE RUST DAMAGE, TREAT WITH RUST REMOVAL, REPLACE IF SIGNIFICANTLY DAMAGED BEFORE

COVERING UP WITH NEW SYSTEM REPLACE ALL GUTTER AND DOWNSPOUTS TO MATCH NEW ROOF PANELS/SYSTEM ALL OF WHICH SHALL MATCH EXISTING


PROVIDE EXTENSION ACCESSORIES AND COMPONENTS AS REQUIRED FOR ALL


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# 06 SOUTH ELEVATION SCALE: 1/8" = 1'-0"



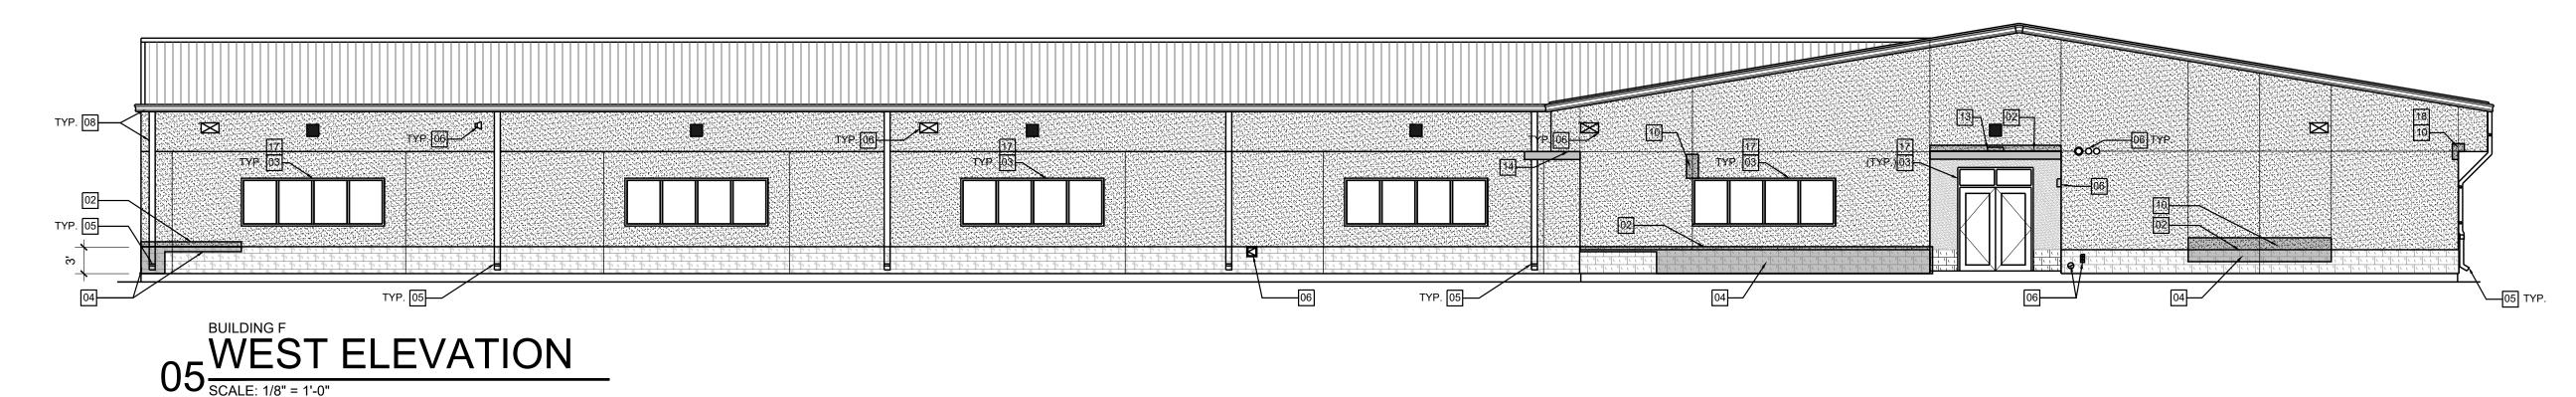

**BUILDING F** 08 EAST ELEVATION
SCALE: 1/8" = 1'-0"
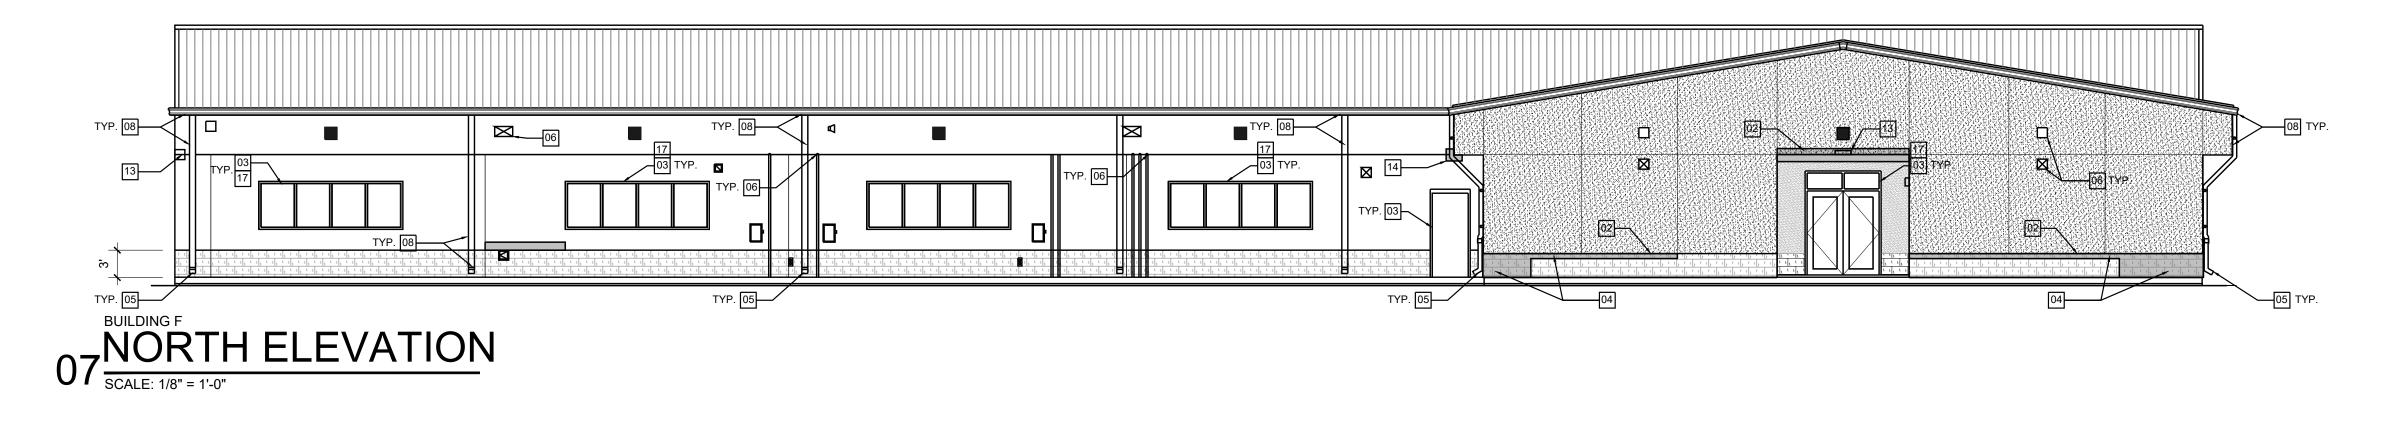
#### EXTERIOR WALLS: SCOPE OF WORK

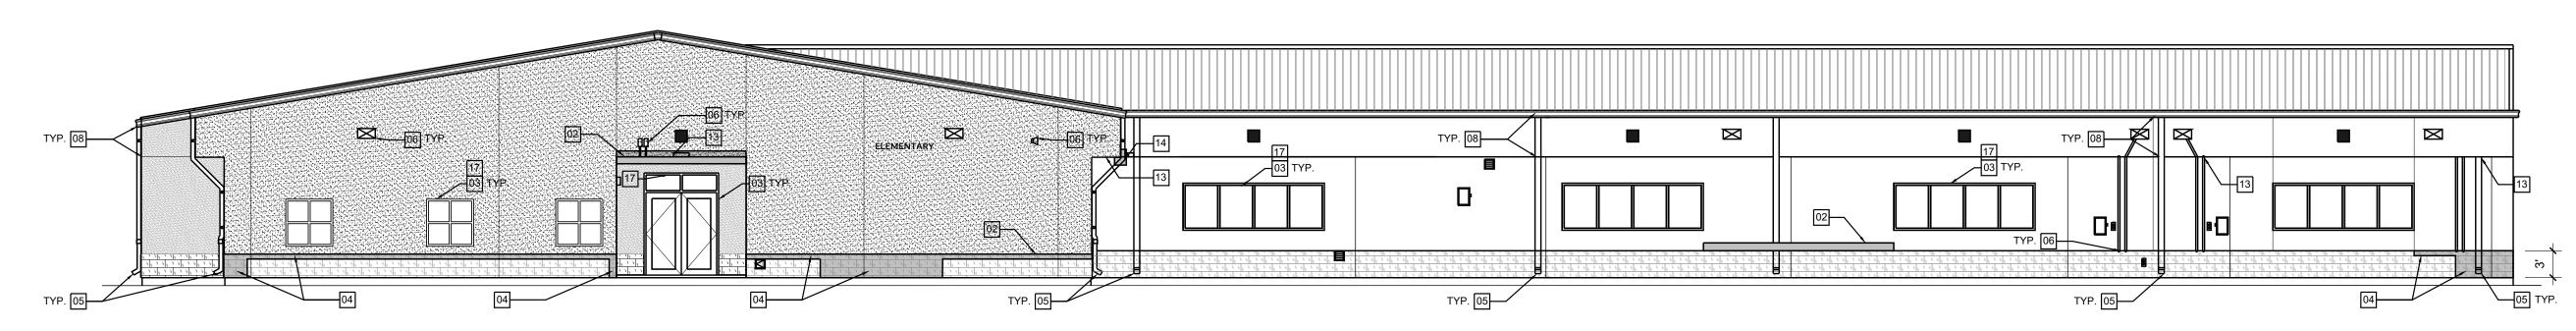- POWER WASH BUILDING EXTERIOR FOR ALL BUILDINGS
- APPLY ELASTOMERIC COATING AT ALL STUCCO WALLS TO MATCH EXISTING
- REPLACE EXISTING EXTERIOR WATERPROOFING/SEALANT JOINTS PROVIDE SPLASH BLOCKS AT EVERY DOWNSPOUT THROUGHOUT CAMPUS

#### LEGEND



#### ALTERNATE 1

ADD 3M SAFETY AND SECURITY WINDOW FILM ULTRA 800 WITH 3M IMPACT PROTECTION SYSTEM TO ALL WINDOWS (INTERIOR SIDE), COORDINATE WITH GASKET REPLACEMENT PRIOR TO FILM INSTALLATION.

#### ALTERNATE 2

- FOR ALL BUILDINGS OTHER THAN FLAGSHIP BUILDING, REMOVE ALL STONE STONE WAINSCOT, METAL LATHE AND WRB AND REPLACE WITH PLASTER WAINSCOT SEPARATED BY A CONTROL JOINT. PAINT TO MATCH THE REMOVED STONE. SEE DETAILS 12,13 A/4.01

#### **KEYED NOTES**


#### 01 PAINT PLASTER, TYP.

- REPLACE HORIZONTAL AND/OR VERTICAL, OR CORNER PLASTER BEADS.
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  REPLACE ALL SEALANT & BACKER RODS @ DOORS/WINDOWS/CONTROL JOINTS,
  TYP. REFER TO DOOR AND WINDOW SEALANT DETAILS ON SHEETS A4.02-A4.04,
  AND CONTROL JOINT DETAILS ON A4.01
- REMOVE AND REPLACE LOOSE OR DAMAGED STONE/BRICK VENEER, REPLACE LATHE TOO. REFER TO DETAILS: 03,04,10, 11/A4.01
- 05 ADD SPLASH BLOCKS, TYP.
- 06 RE-SEAL ALL WALL EXTERIOR PENETRATIONS, TYP.
- 07 REMOVE RUST AND COLD GALVANIZE ROOF FRAMING/EXPOSED METAL
- 08 REPLACE GUTTER/DOWNSPOUT/BOOT CLUSTER OF HAIRLINE CRACKS. WHEN CRACK IS 1/2" OR MORE, REPAIR WITH BACKER ROD AND CAULKING BEFORE PAINTING
- PATCH AND REPAIR PLASTER TO MATCH EXISTING FINISH. REFER TO DETAILS: 06,07,05/A4.01
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- RE-POINT GROUT AT STONE TO STUCCO TRANSITION AT WINDOW COVE, TYP.
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- 17 REMOVE AND REPLACE WINDOW GASKETS WITH NEW ONES, TYP.
- 18 CONTRACTOR TO ACCOUNT FOR SHEATHING REPLACEMENT AT





1150 Paredes Line Rd. Brownsville TX 78526 fax (956) 546-0196

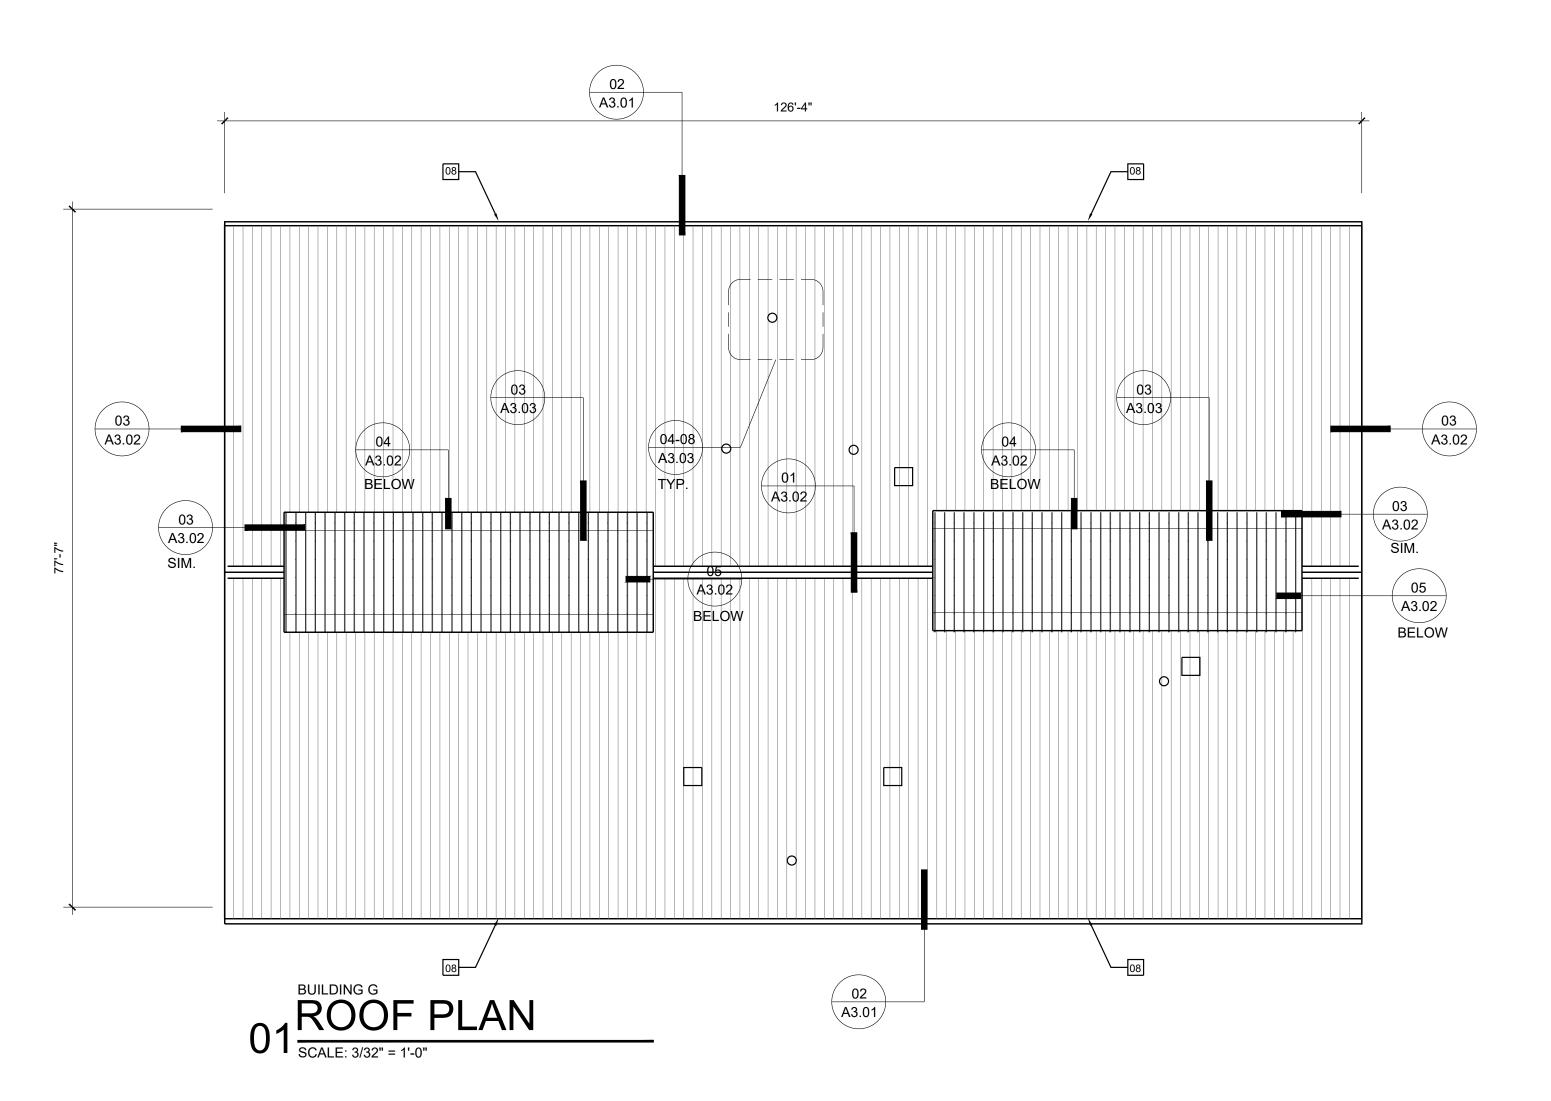

# **KEYED NOTES**

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PROVIDE EXTENSION ACCESSORIES AND COMPONENTS AS REQUIRED FOR ALL EXISTING ROOF COMPONENTS

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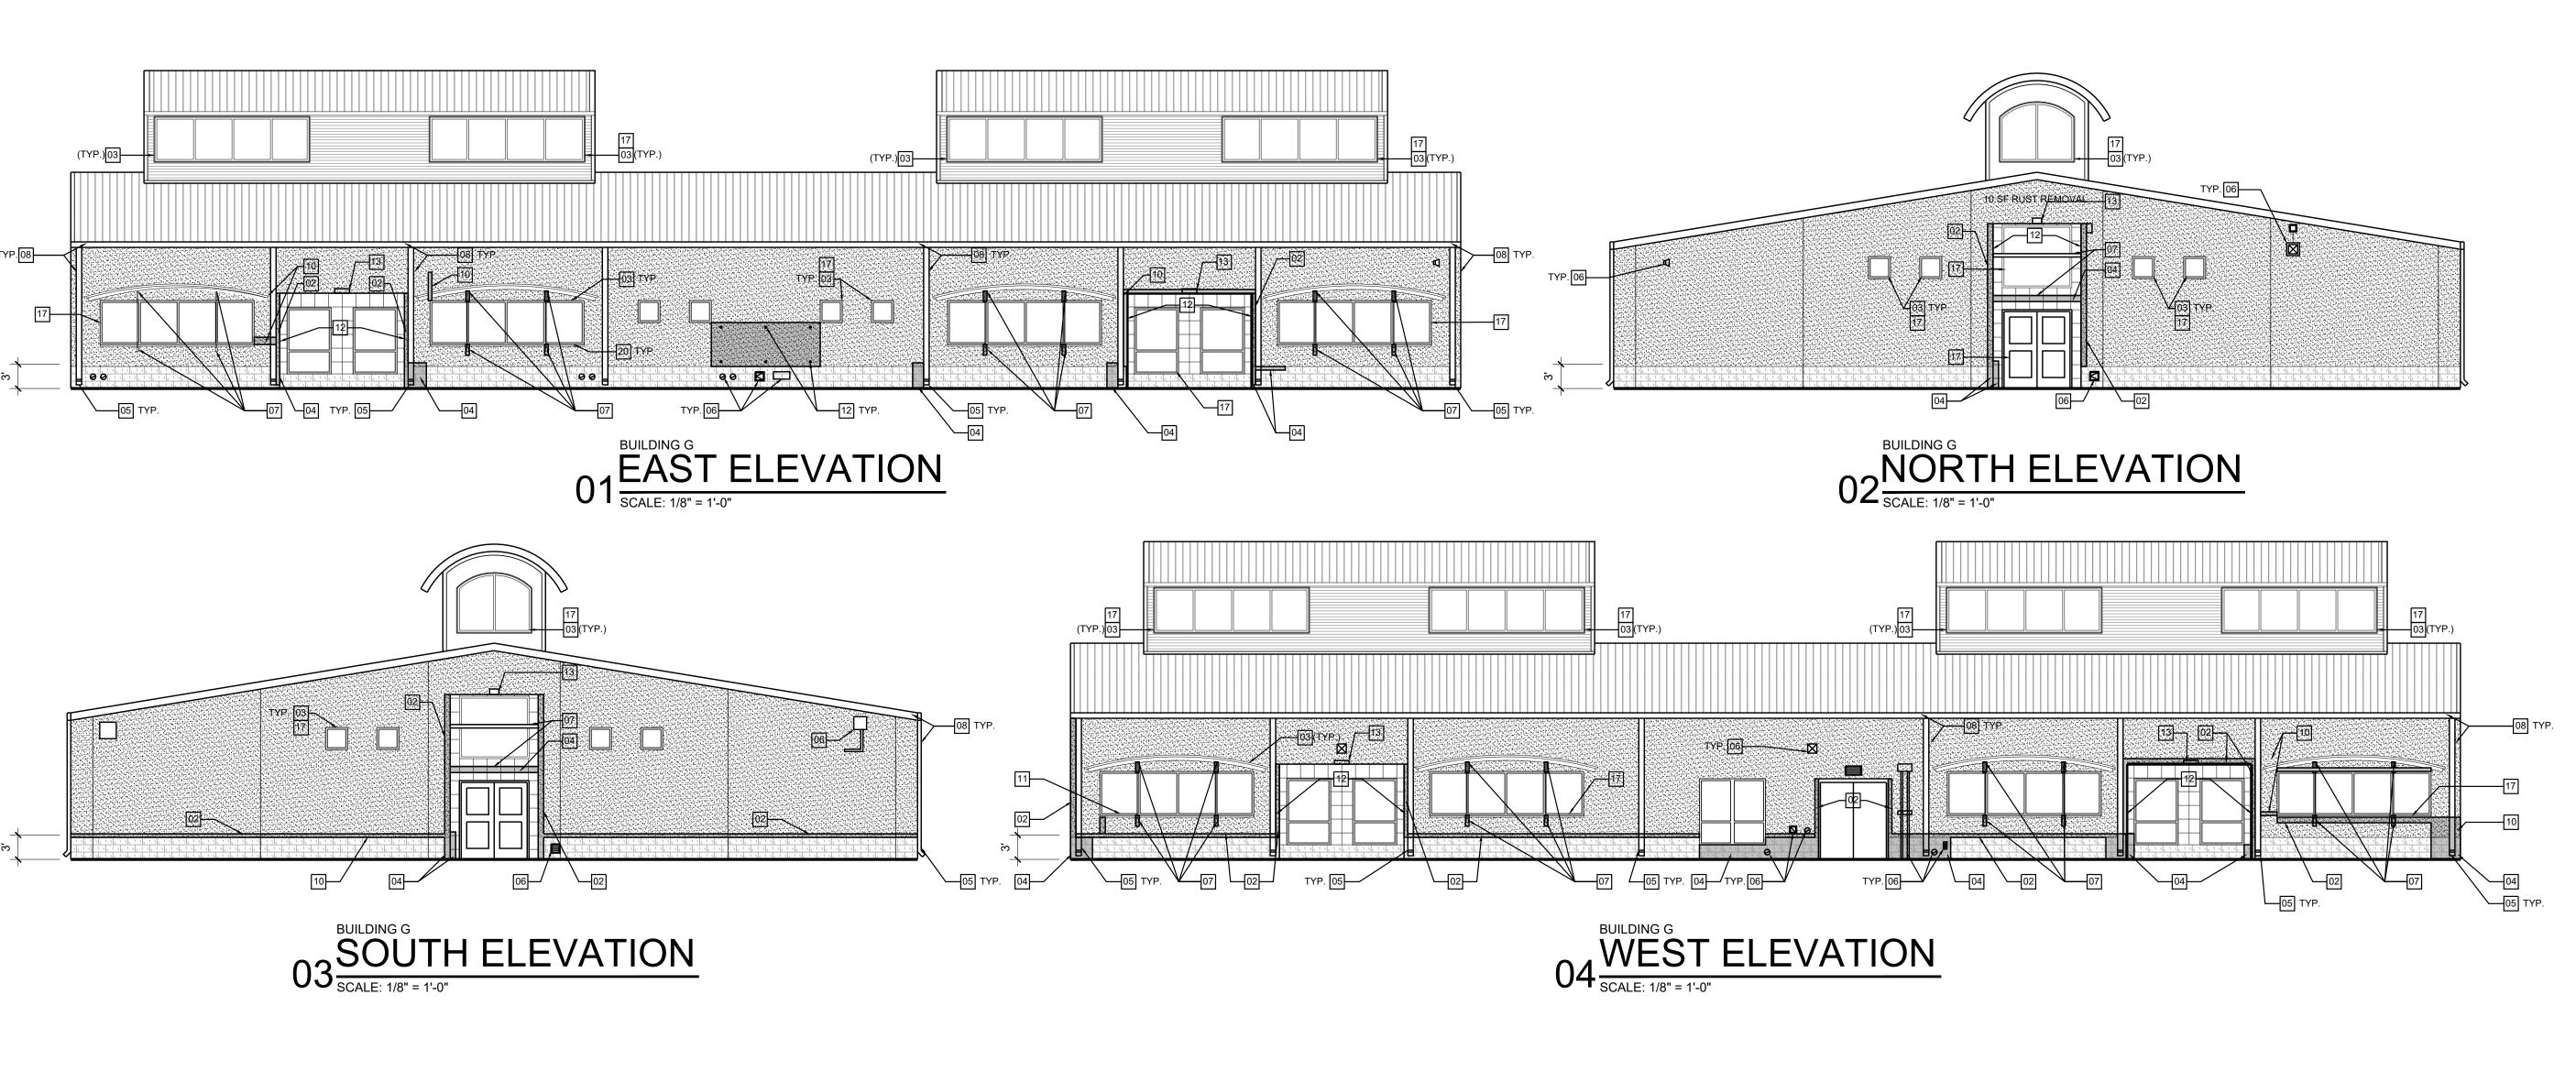
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#### LEGEND

INDICATES WORK AREA

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#### LEGEND

INDICATES WORK AREA

# CLERESTORY WINDOWS OVER

GENERAL NOTES

NEW BARREL — ROOF RECOVER, STANDING SEAM ROOF TO MATCH

**EXISTING** 

WALL FLASHING


RUST TREAT
RAFTERS AS
REQUIRED.

- REMOVE ALL SHEET METAL GUTTERS DOWNSPOUTS FLASHING. PROVIDE UNIT PRICING FOR REPLACEMENT OF EXISTING ROOF CURBS.

- APPLY RUST TREATMENT TO ALL AREAS OF EXISTING STEEL DECK THAT INDICATE SIGNS OF SEVERE OXIDATION AND SURFACE RUST.
- REPLACE EXISTING HEATER VENTS WITH NEW DOUBLE-WALL HEATER VENTS. EXTEND FLUES TO MATCH EXISTING AS REQUIRED TO ACCOMMODATE NEW ROOF THICKNESS AND PROVIDE A MINIMUM 12" HEIGHT FROM ROOF TO BOTTOM OF VENT CAP.
- FIELD VERIFY ROOFS FOR EXISTING ROOF COMPONENTS. EXTEND ALL PIPES, CONDUIT, WIRE, ETC. AS REQUIRED TO ACCOMMODATE NEW ROOF SYSTEM. THE CONTRACTOR SHALL BE
  RESPONSIBLE FOR HAVING A LICENSED ELECTRICAL, PLUMBING, AND MECHANICAL CONTRACTOR CAREFULLY REMOVE, RAISE, OR MODIFY AND CAREFULLY REINSTALL EXISTING OPERATING
  MECHANICAL, ELECTRICAL, PLUMBING AND RELATED EQUIPMENT AS REQUIRED TO COMPLETE THE WORK.
- THE CONTRACTOR SHALL TAKE EXTREME CARE IN WORKING WITH EXISTING ITEMS THAT ARE TO REMAIN DAMAGE CAUSED BY THE CONSTRUCTION PROCESS WILL BE PREPARED BY THE CONTRACTOR AT NO COST TO THE OWNER.
- IT IS THE CONTRACTOR'S RESPONSIBILITY TO FIELD-VERIFY EXISTING CONDITIONS. DIMENSIONS. QUANTITIES, AND ETC. PRIOR TO BIDDING.
- INSPECT ALL DECK SUPPORTED STRUCTURAL AREAS FOR DAMAGE AND REPORT TO ARCHITECT ANY DEFICIENCIES FOUND. PROVIDE UNIT PRICING FOR REPLACING.
- RE-INSTALL OR PROVIDE NEW CONCRETE SPLASH BLOCKS AT THE BASE OF ALL NEW DOWN SPOUTS.

AT ALL EXISTING ROOF PENETRATIONS, PROVIDE FOR NEW FLASHING MATERIALS AND OR SEALS, SEALANTS AND REQUIRED PRODUCTS FOR PROPER FLASHING.
 KITCHEN MAY NEED TO REMAIN OPERATIONAL DURING RE-ROOFING CONSTRUCTION. IT IS THE CONTRACTORS RESPONSIBILITY TO VERIFY OPERATION SCHEDULE AND TO INCLUDE ALL COSTS ASSOCIATED WITH REMODELING WHILE KITCHEN IS OPEN IF REQUIRED.

F CAMPUS REQUIRES NO WORK ON SITE OR IN SPECIFIC BUILDINGS DURING ACADEMIC TESTING DAYS, IT IS THE CONTRACTORS' RESPONSIBILITY TO ATTAIN SCHEDULE AND COVER ANY COSTS ASSOCIATED FOR ACCOMMODATING THE CAMPUS'S TESTING SCHEDULE.

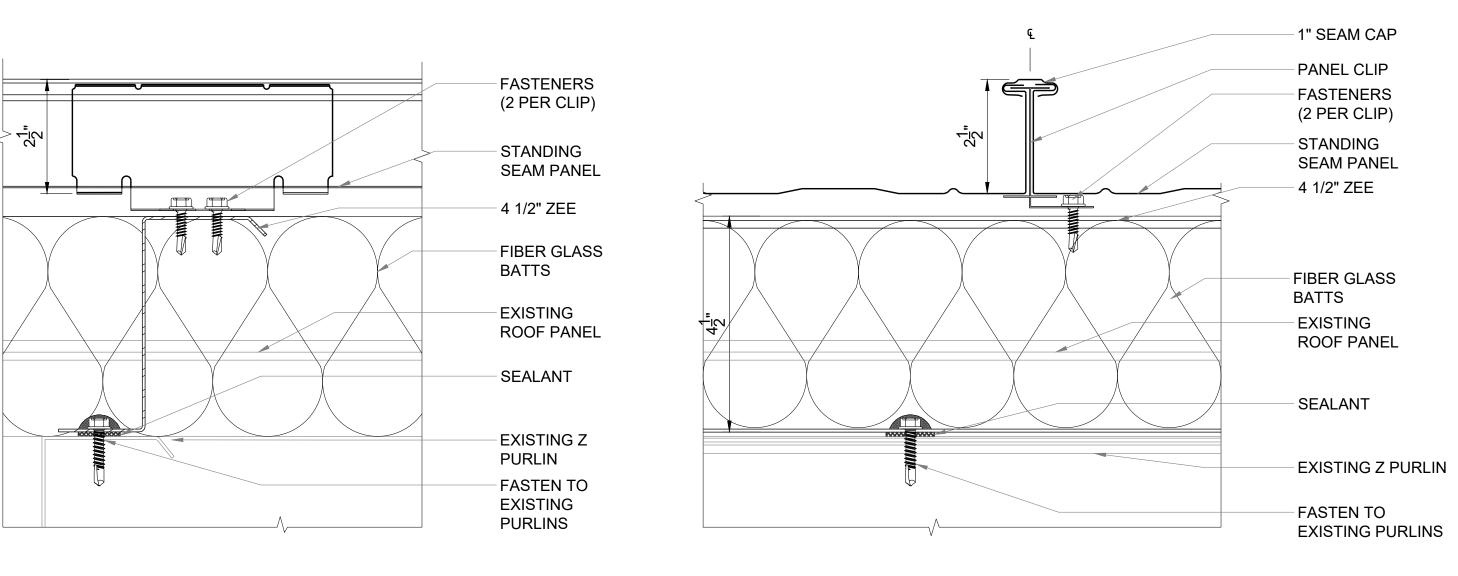

CLERESTORY WINDOWS REFLECTED CEILING PLAN

03


A3.03

**CEILING TO** 


CLERESTORY WINDOWS OVER BARREL ROOF


**RAFTERS** 

# TYPICAL ROOF ASSEMBLY, TYPE-1

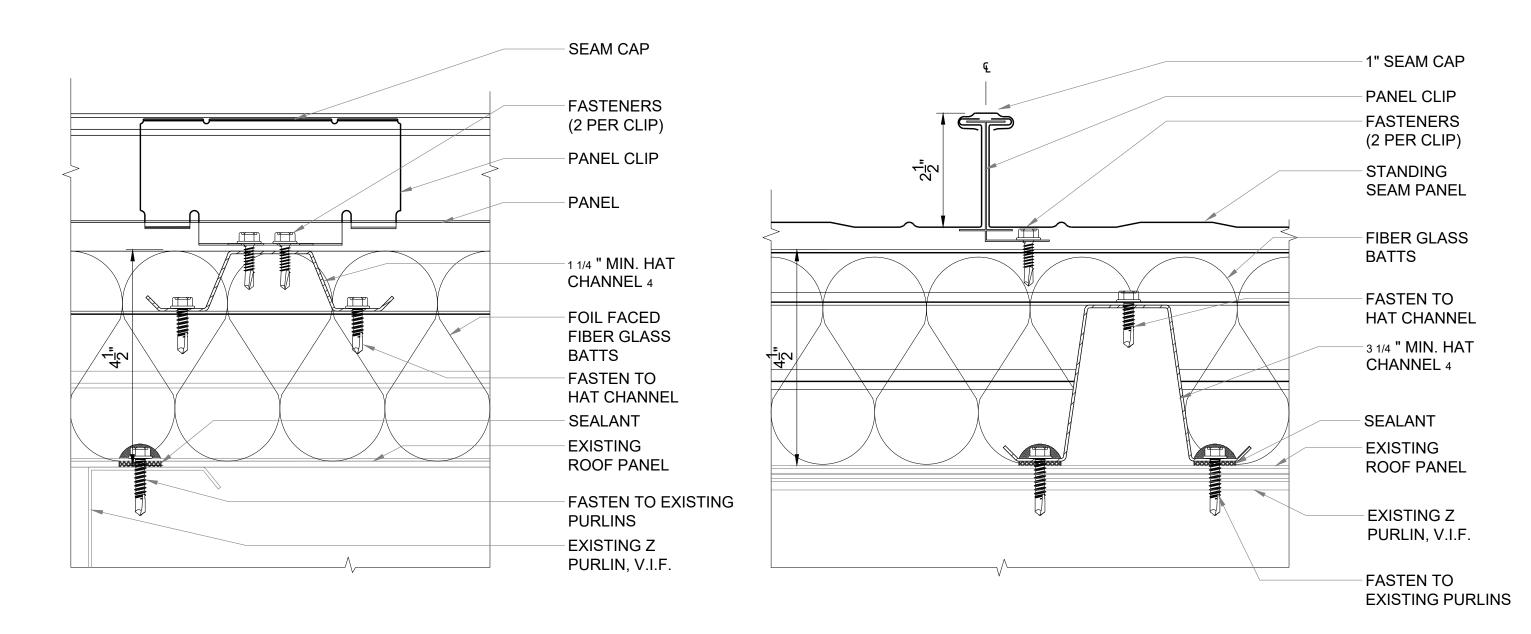


TYPICAL ROOF ASSEMBLY, TYPE-2 (ZONES 2N, 2R, 3E, 3R)

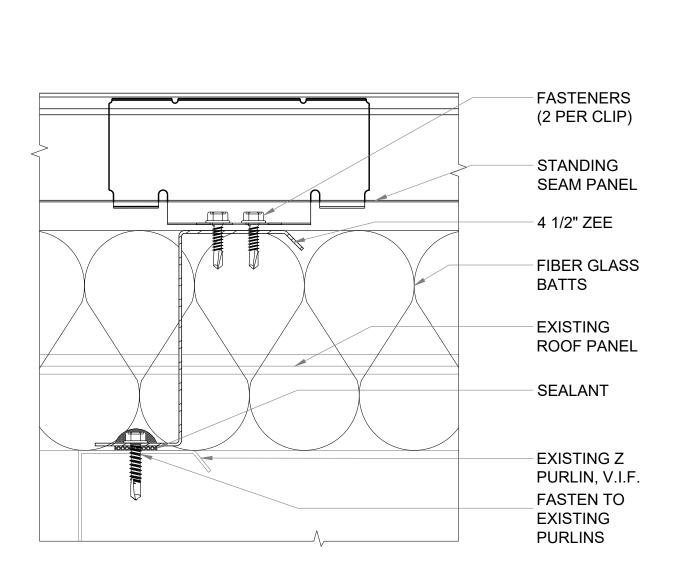

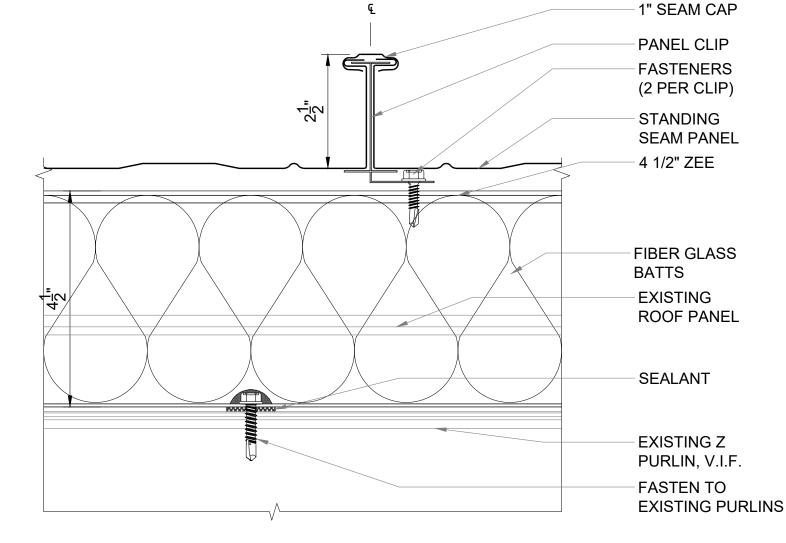

# TYPICAL ROOF ASSEMBLY, TYPE-1 (ZONE 1)

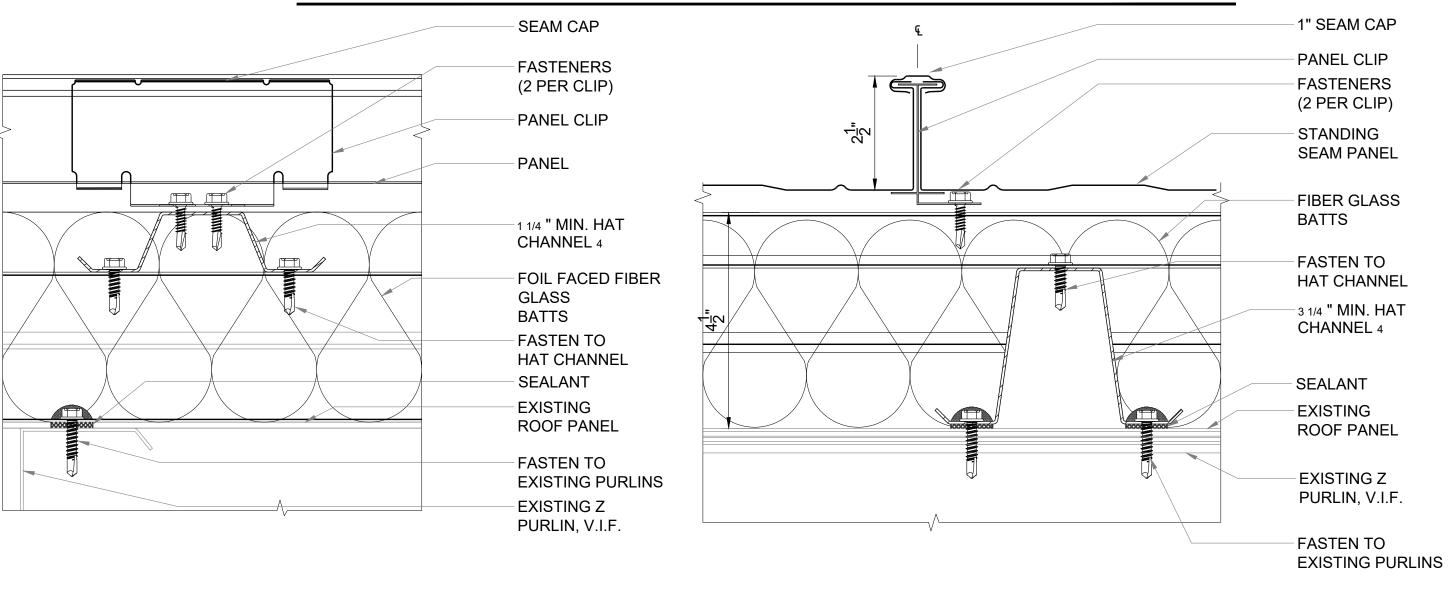

TYPICAL ROOF ASSEMBLY, TYPE-2 (ZONE 2E, 2R, 3)

EXTERIOR FACILITY

GMS ARCHITEC

1150 Paredes Line Ro

Brownsville TX 78526

fax (956) 546-0196

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Gomez Mendez Saenz Indexidentes Planners
Interior Designers

Date:
September 2029
Scale:
As Note
Project Architect:
Roan Gomez, Ald
Drawn By:
CG,R

43.01

IDEA FACILITIE

EAVE

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2 ROWS OF NON-CURING BUTYL SEALANT APPLIED BETWEEN VERTICAL PANEL LEGS 12 2 SLOPE SEAM CAP PANEL CLIP NEOPRENE CLOSURE, CONTINUOUSLY, WITH 2 ROWS OF NON-CURING BUTYL - FIBER GLASS EDGE STIFFENING INSULATION **EAVE TRIM** - 16 GA. MIN. EAVE SUPPORT 2" GUTTER STRAP @ 30"-- SEALANT O.C. 1/8" ALUMINUM PAINTED TO MATCH GUTTER (BY INSTALLER) GUTTER SCREW W/-NEOPRENE WASHER, - EXISTING EAVE BEDDED IN SEALANT STRUT, V.I.F. NEW FLUID APPLIED WRB-FASTEN TO NEW GUTTER TO MATCH-**EXISTING** EXISTING STRUCTURE/PURLINS, WHEN PENETRATING AIR\_ BARRIER, SCREW W/ NEOPRENE WASHER, BID SHALL INCLUDE DEMO AND BEDDED IN SEALANT REPLACE EXISTING 2X 2" GUTTER STRAP @ 30"-NAILERS/BOLTS. IF CONDITION O.C. 3/16" ALUMINUM IS GOOD, CREDIT SHALL BE PAINTED TO MATCH APPLIED TOWARD

**EXPANDING EAVE** 





REFERENCE PT.

RIDGE TRIM —

SEALANT

TAPE,

INSTALL

STANDING -

SEAM PANEL

1 1/2" MIN. HAT

CHANNEL

4 1/2" ZEE-

FIBER GLASS-

BATTS

SEALANT-

PANEL

EXISTING ROOF -

EXISTING Z -

FASTEN TO -

**EXISTING** 

**PURLINS** 

PURLIN (V.I.F.)

CONTINUOUSLY

SEALANT

APPLIED @

OF HEAD

INTERSECTION

CLOSURE TRIM

TO VERTICAL

PANEL LEG.

FASTENERS

(2 PER CLIP)

STANDING

SEAM PANEL

-1 1/2" MIN. HAT

GUTTER, (BY INSTALLER)

DOWNSPOUT BEYOND-

OUTLET TUBE-

FASCIA CLOSURE-

MATCH EXISTING

AND BACKER ROD

NEW ELASTOMERIC-COATING AS SPEC'D EXISTING STUCCO FINISH-

NEW FASCIA TRIM TO-

SEAL WITH NEW CAULK-

CHANNEL

FIBER GLASS

−4 1/2" ZEE

SEALANT

-EXISTING

**ROOF PANEL** 


EXISTING Z

FASTEN TO


**EXISTING** 


**PURLINS** 

PURLIN (V.I.F.)

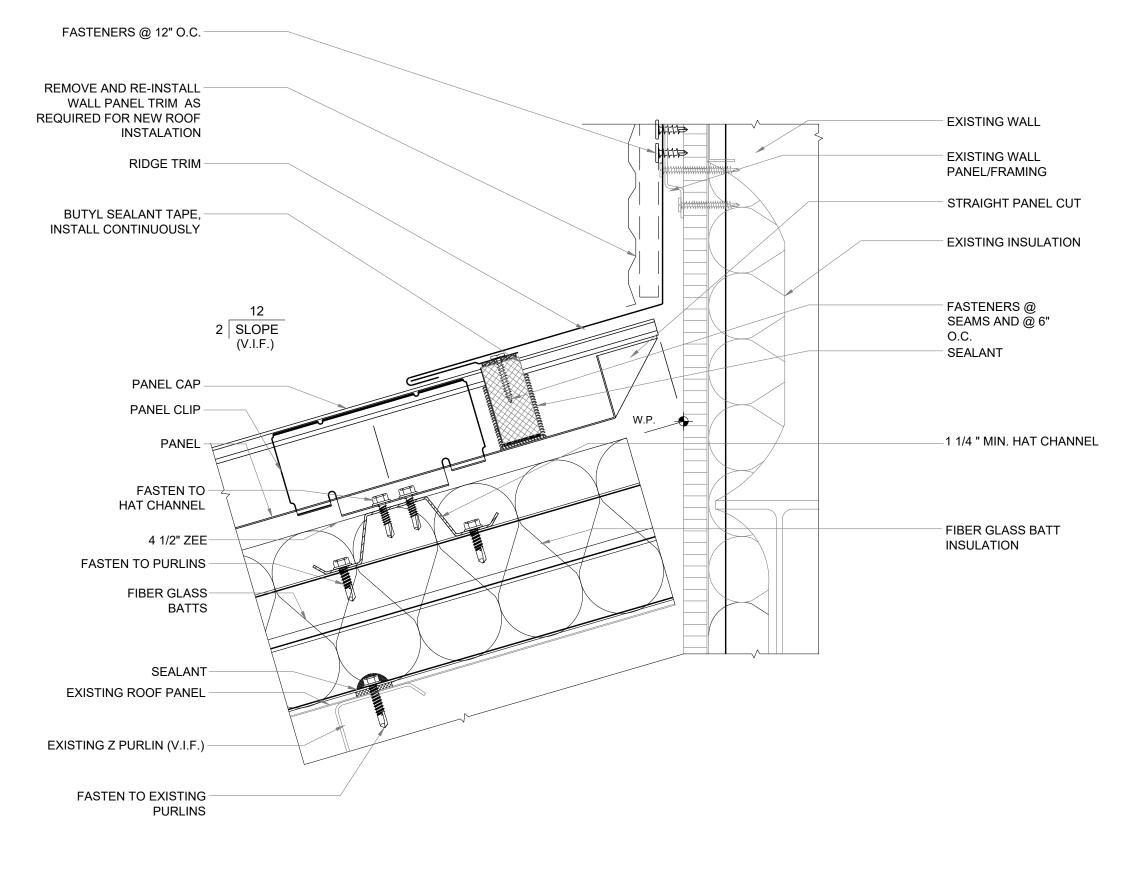

04 FIXED HEAD DETAIL
SCALE: NTS

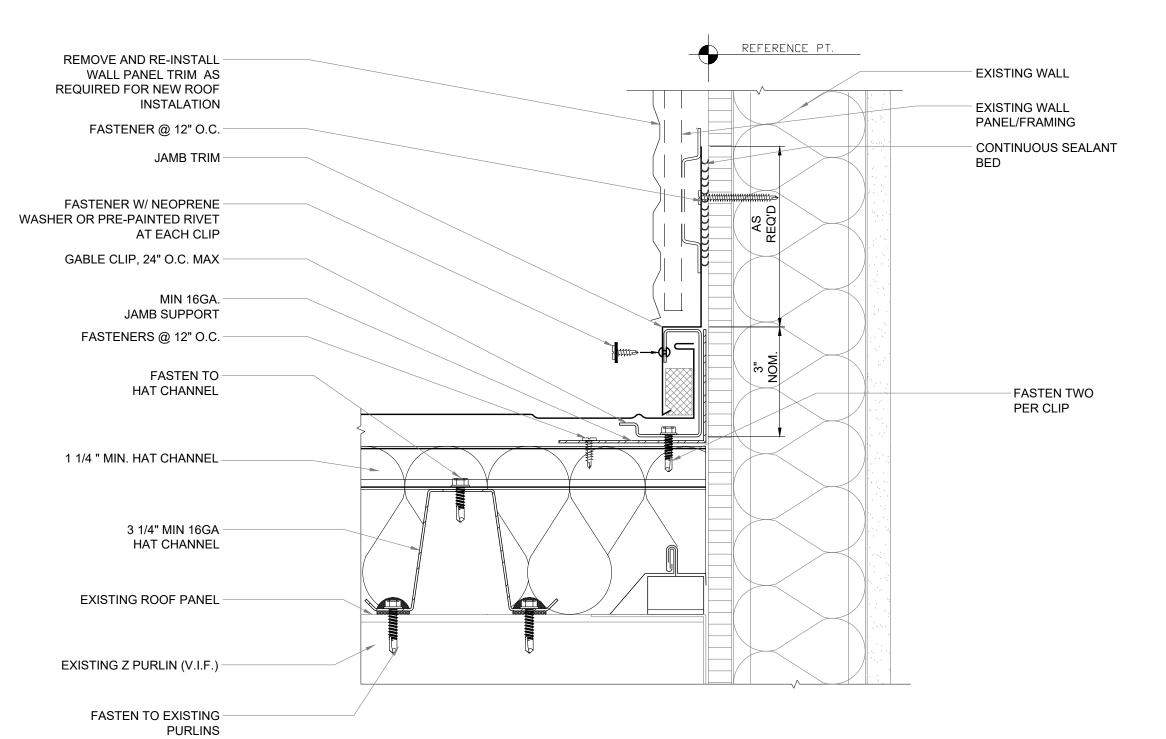

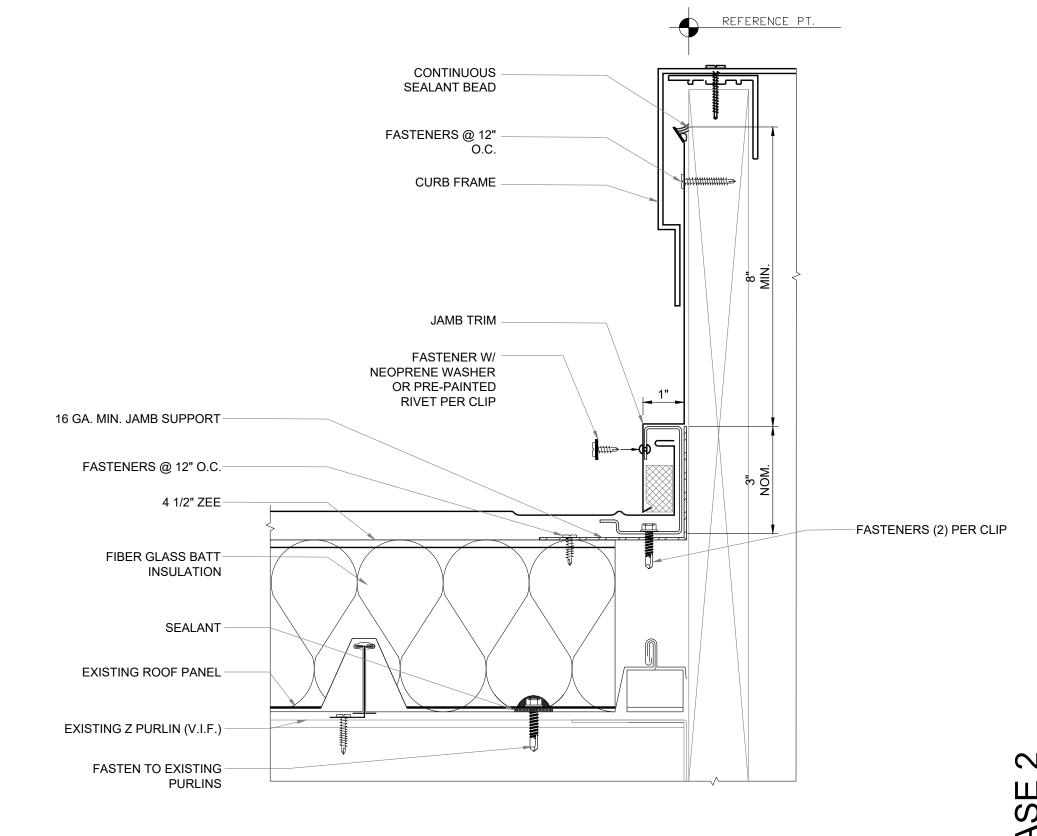

03 RAKE DETAIL

SCALE: NTS

GABLE CLIP -

RAKE TRIM -

SELF-ADHERING -

NEOPRENE CLOSURE

FASTENERS, 12" O.C.

HOLD DOWN CLEAT-

FASTENERS, 12" O.C. -

BID SHALL INCLUDE DEMO -

NAILERS/BOLTS. IF

CONDITION IS GOOD,

TOWARD ALLOWANCE.

FASTENERS, 12" O.C. -

NEW FASCIA TRIM TO-

ALLOWANCE.

MATCH EXISTING

HOLD DOWN CLEAT-

SEAL WITH NEW CAULK-AND BACKER ROD

EXISTING STUCCO FINISH-


NEW ELASTOMERIC-

COATING AS SPEC'D

AND REPLACE EXISTING 2X


CREDIT SHALL BE APPLIED

06 SLOPING JAMB DETAIL @ CURB

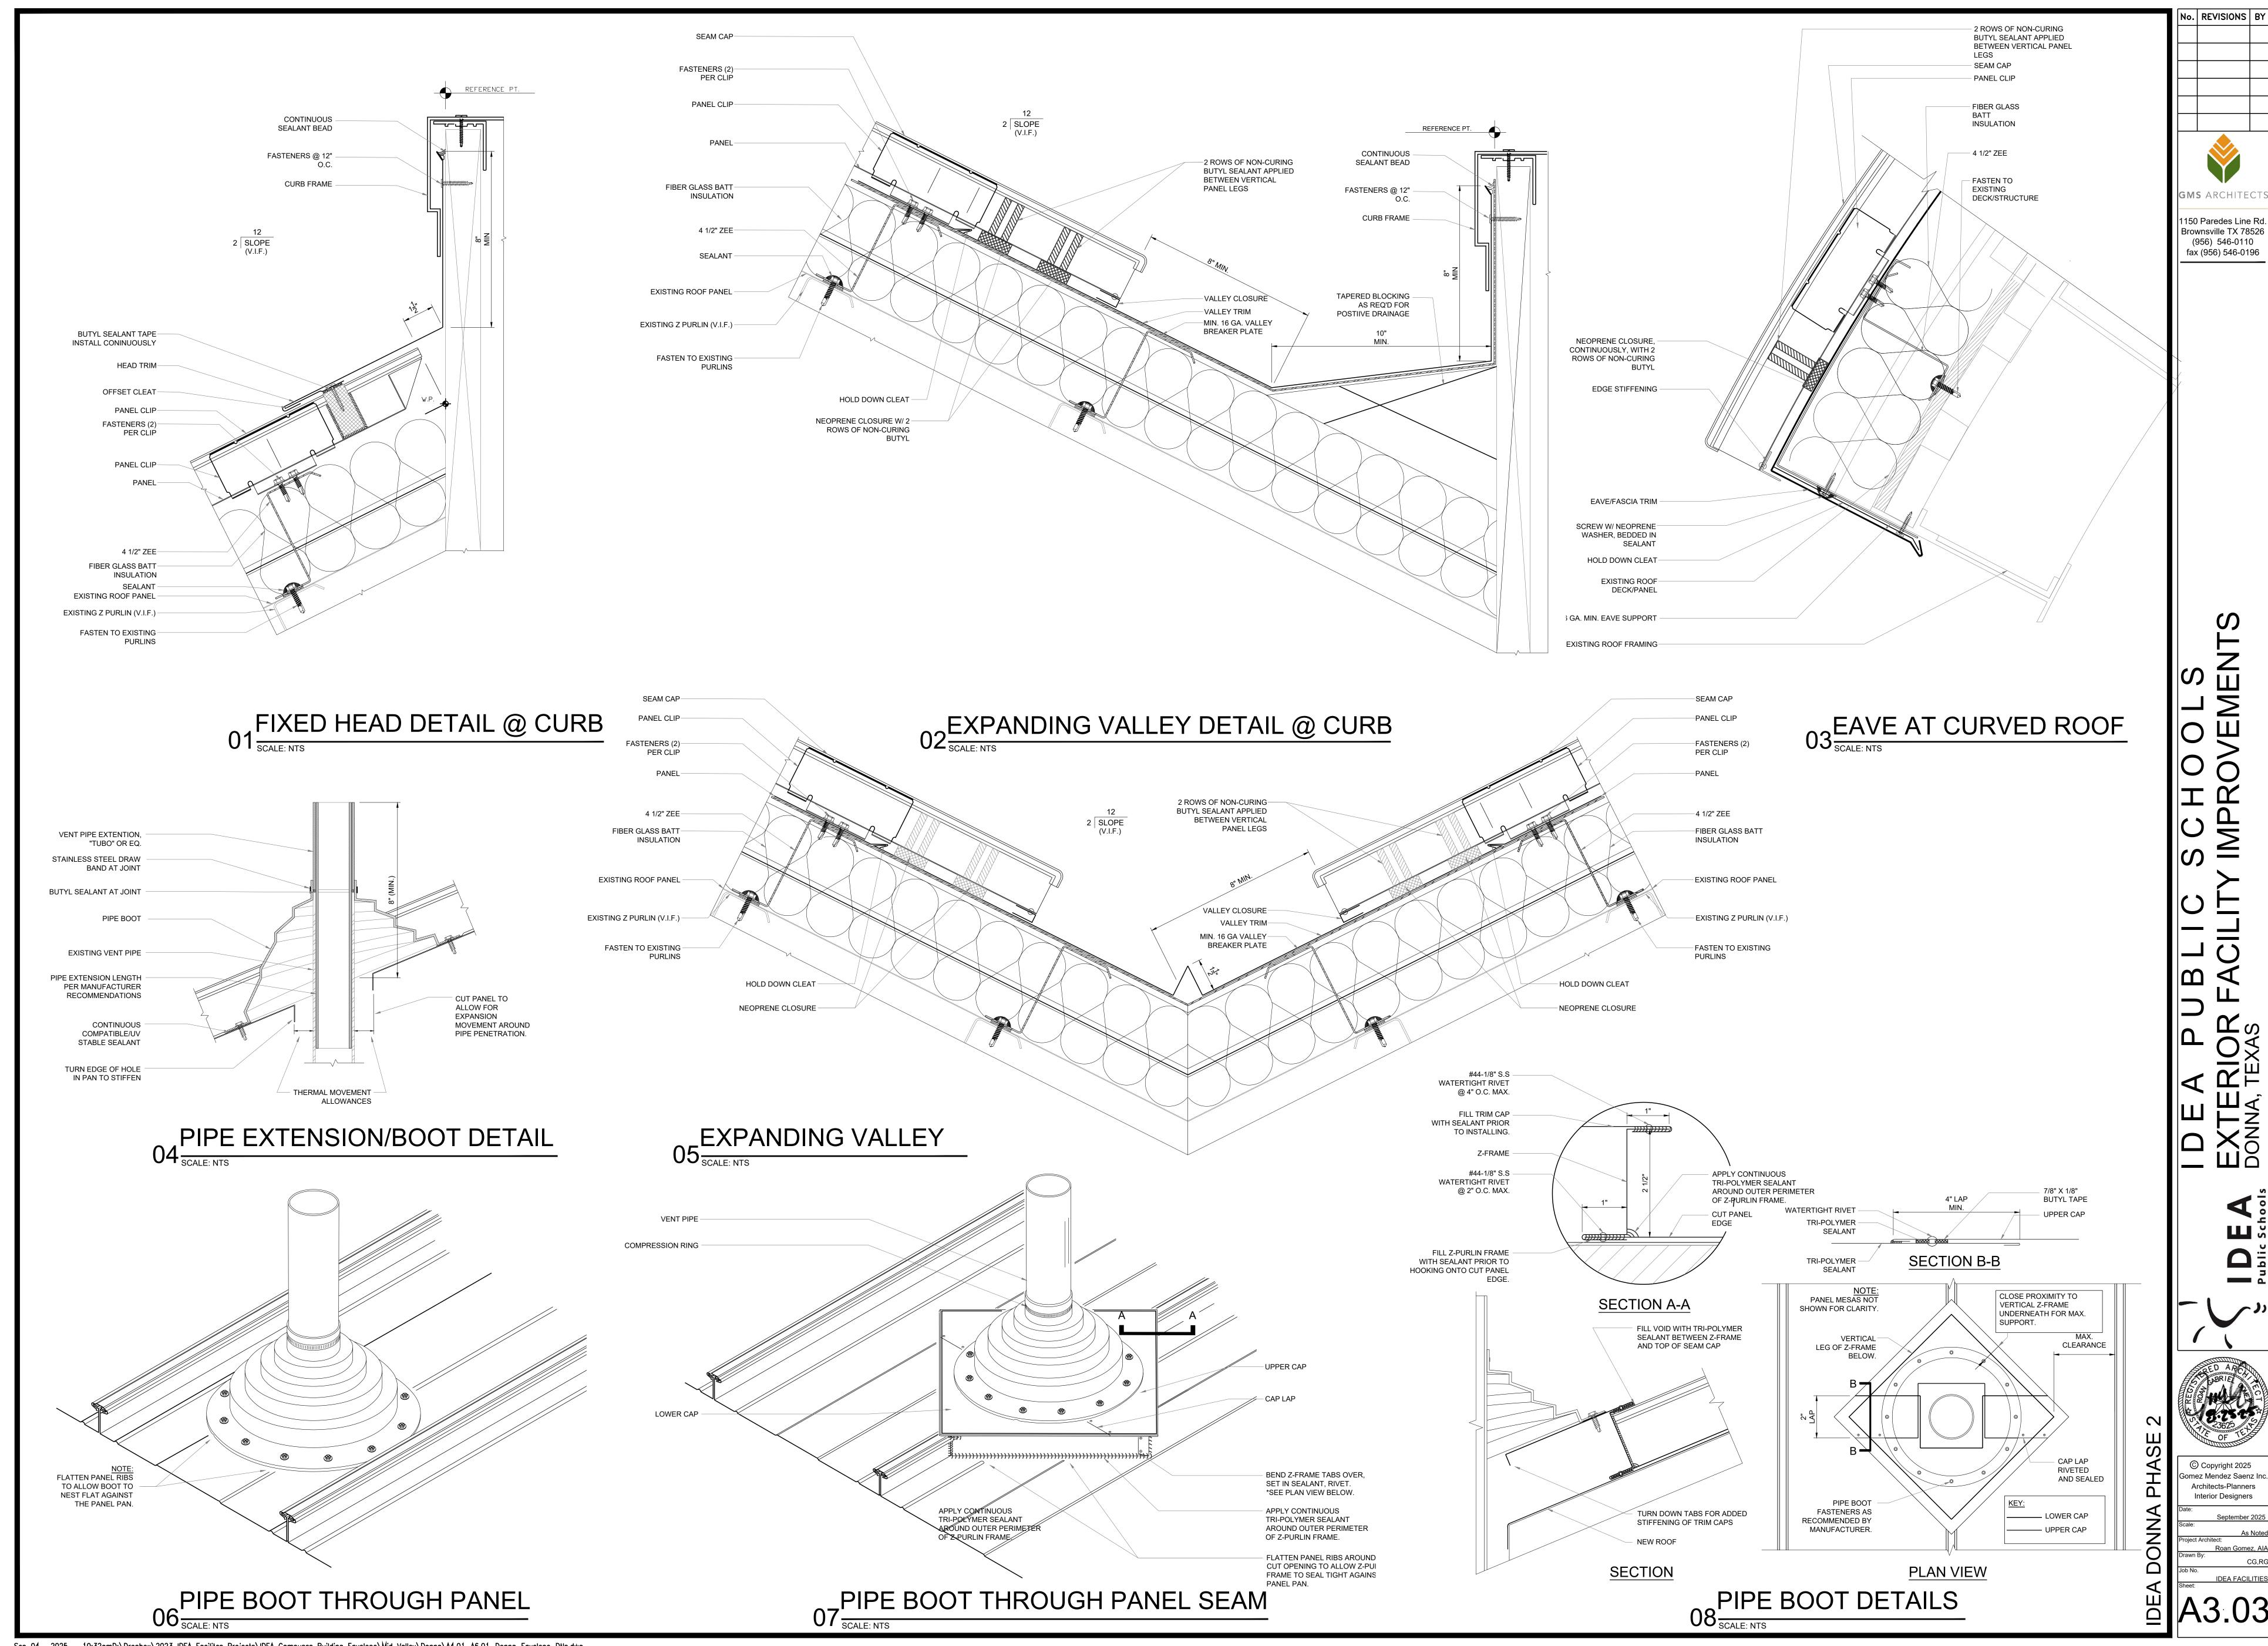


Sep 04, 2025 - 10:32amD:\Dropbox\2023 IDEA Facilites Projects\IDEA Campuses Building Envelope\Mid Valley\Donna\A4.01-A6.01-Donna\_Envelope\_Dtls.d\yg


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TYPICAL VERTICAL
CONTROL JOINT @ STONE
02
SCALE: 6" = 1'-0"

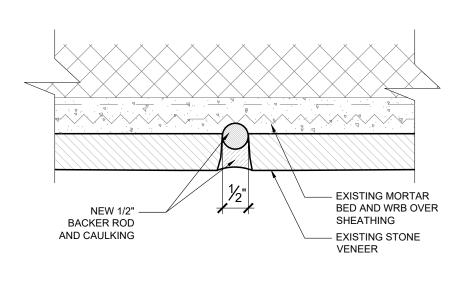

TYPICAL TRANSITION
REPAIR @
STUCCO/STONE
03
SCALE: 6" = 1'-0"

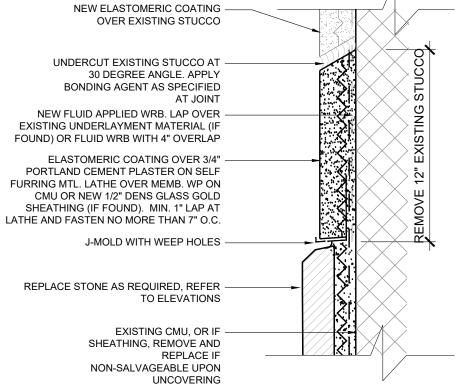


TYPICAL STONE

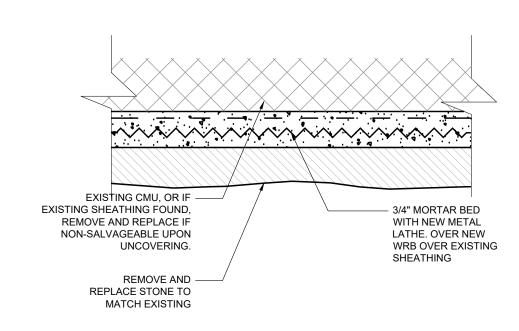04

REPLACEMENT DETAIL


SCALE: 6" = 1'-0"

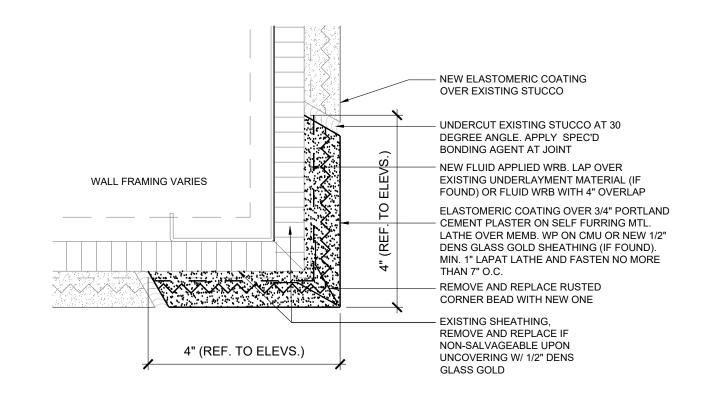

TYPICAL DRIP DETAIL @

O5


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TYPICAL CORNER DETAIL

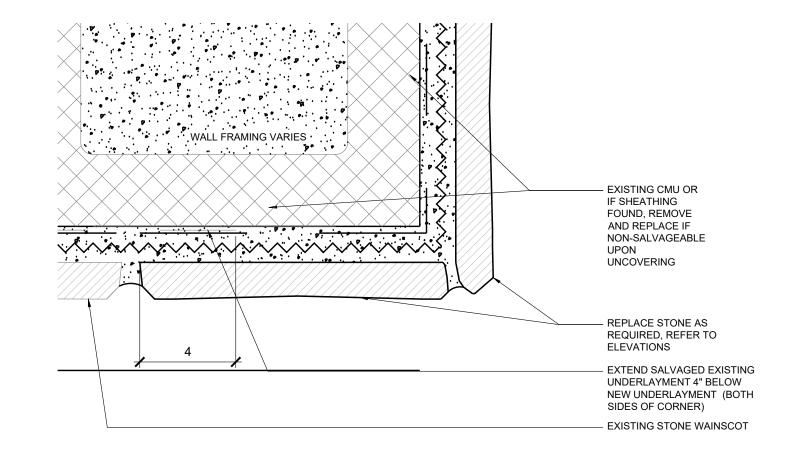
10 STONE

SCALE: 6" = 1'-0"



PLASTER REPAIR DETAIL

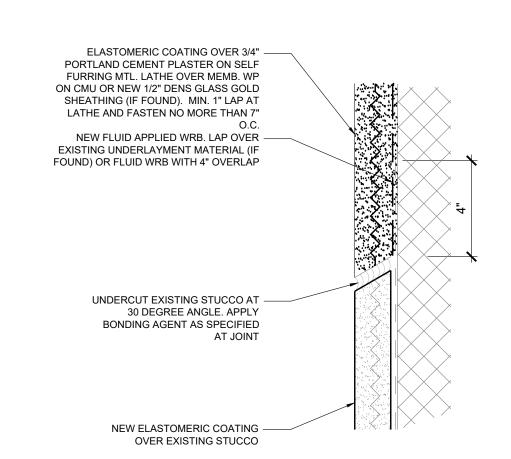(TOP PORTION REMOVED)

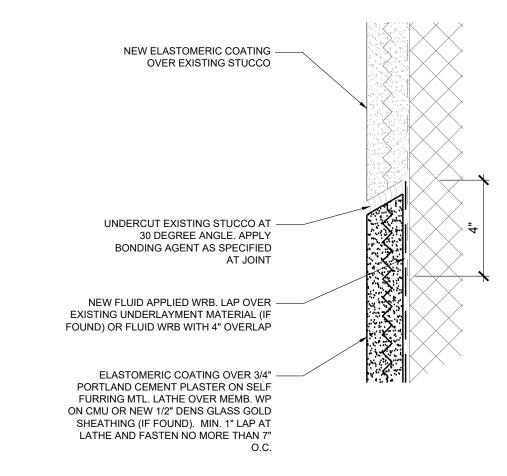


PLASTER REPAIR DETAIL

(BOTTOM PORTION REMOVED)

07


SCALE: 6" = 1'-0"

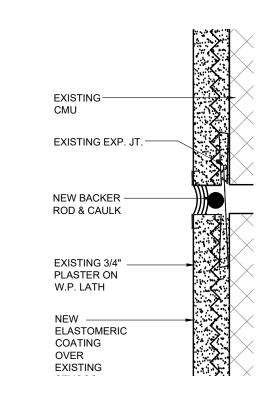

EXPANSION JOINT @

08 STUCCO


SCALE: 6" = 1'-0"

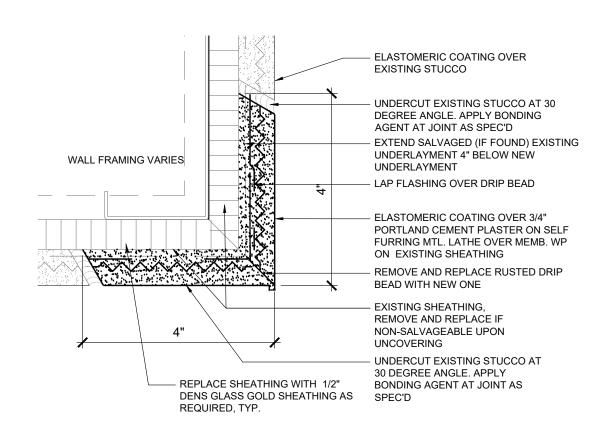

TYPICAL CORNER DETAIL

09 PLASTER


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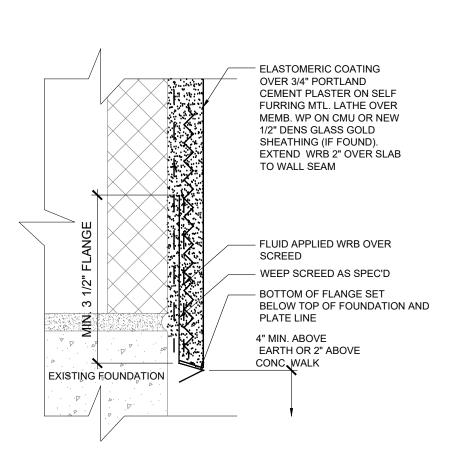
TYPICAL REPOINTING DETAIL @

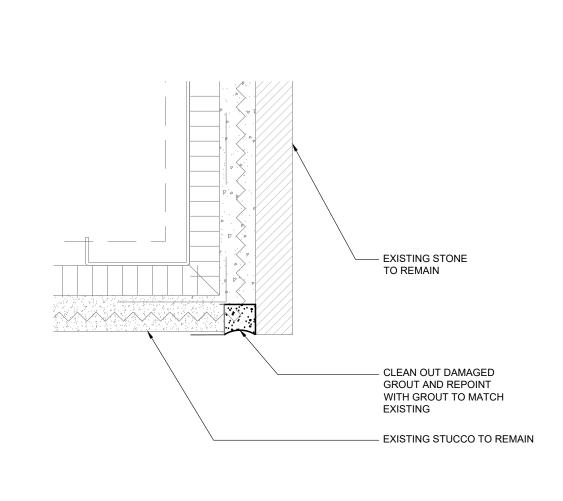11 STONE TO STUCCO


SCALE: 6" = 1'-0"



ALTERNATE 2:
STUCCO REPLACEMENT @
WAINSCOT- SEAM

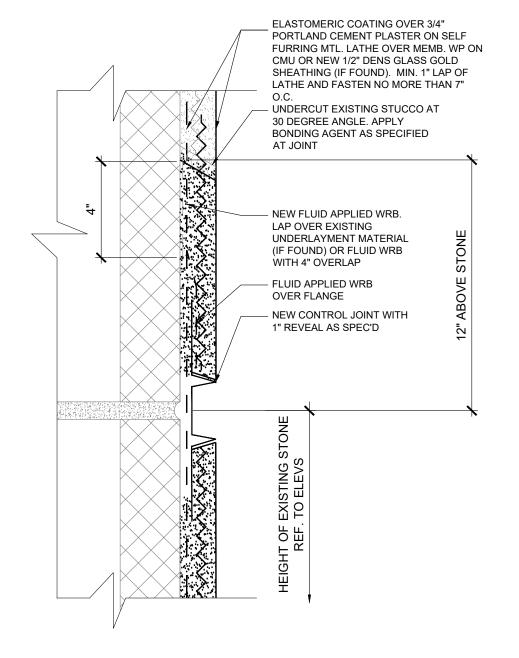

ALTERNATE 2:
STUCCO REPLACEMENT @
WAINSCOT- BASE

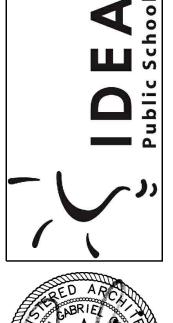


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**GMS** ARCHITEC

1150 Paredes Line Ro

Brownsville TX 78526

(956) 546-0110 fax (956) 546-0196

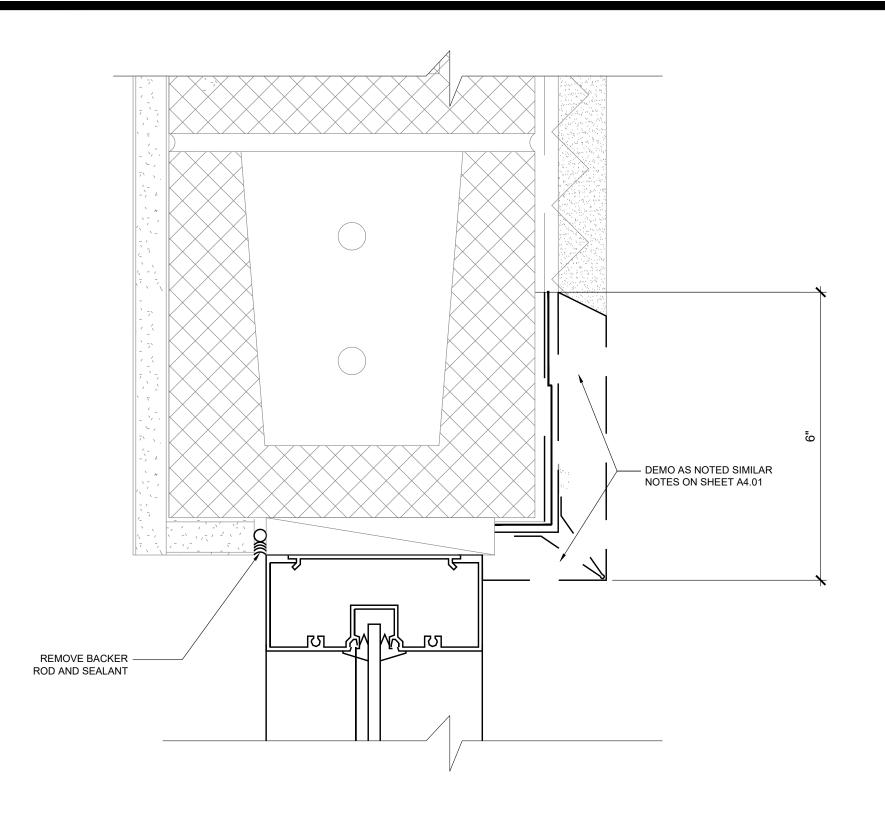

# TYPICAL STUCCO REPAIR @ WINDOW 01 HEADER - DEMOLITION SCALE: 6" = 1'-0"

IF DAMAGED, REMOVE -AND REPLACE DRY WALL AND PAINT TO MATCH NEW BACKER ROD AND -— DEMO AS NOTED SIMILAR NOTES ON SHEET A4.01

TYPICAL STUCCO REPAIR @ WINDOW 03 JAMB - DEMOLITION
SCALE: 6" = 1'-0"

# TYPICAL STUCCO REPAIR @ WINDOW HEADER

IF DAMAGED, REMOVE AND REPLACE DRY WALL
AND PAINT TO MATCH
EXISTING

NEW BACKER ROD

— UNDERCUT EXISTING STUCCO AT 30 DEGREE ANGLE. APPLY BONDING AGENT AT JOINT

EXTEND SALVAGED EXISTING

**NEW DAMPROOFING** UNDERLAYMENT


— EXISTING METAL WALL

- NEW CORNER DRIP BEAD - NEW ELASTOMERIC COATING AS SPECIFIED, TO MATCH


- NEW BACKER ROD AND

- WINDOW TO REMAIN

UNDERLAYMENT 2" BELOW NEW UNDERLAYMENT

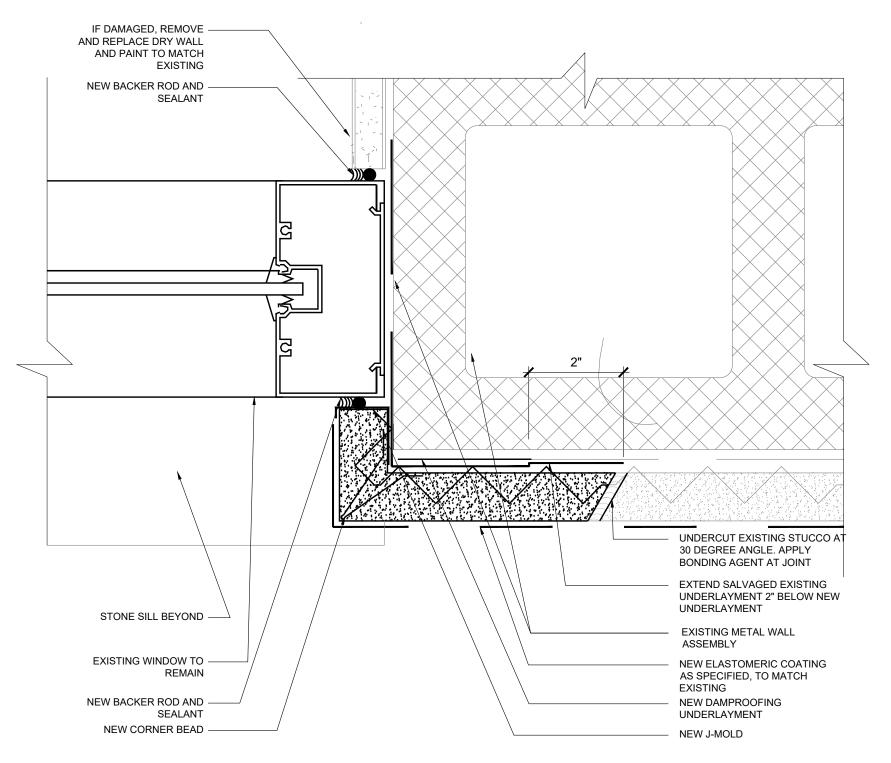


# TYPICAL STUCCO REPAIR @ WINDOW JAMB 04<sub>SCALE: 6" = 1'-0"</sub>

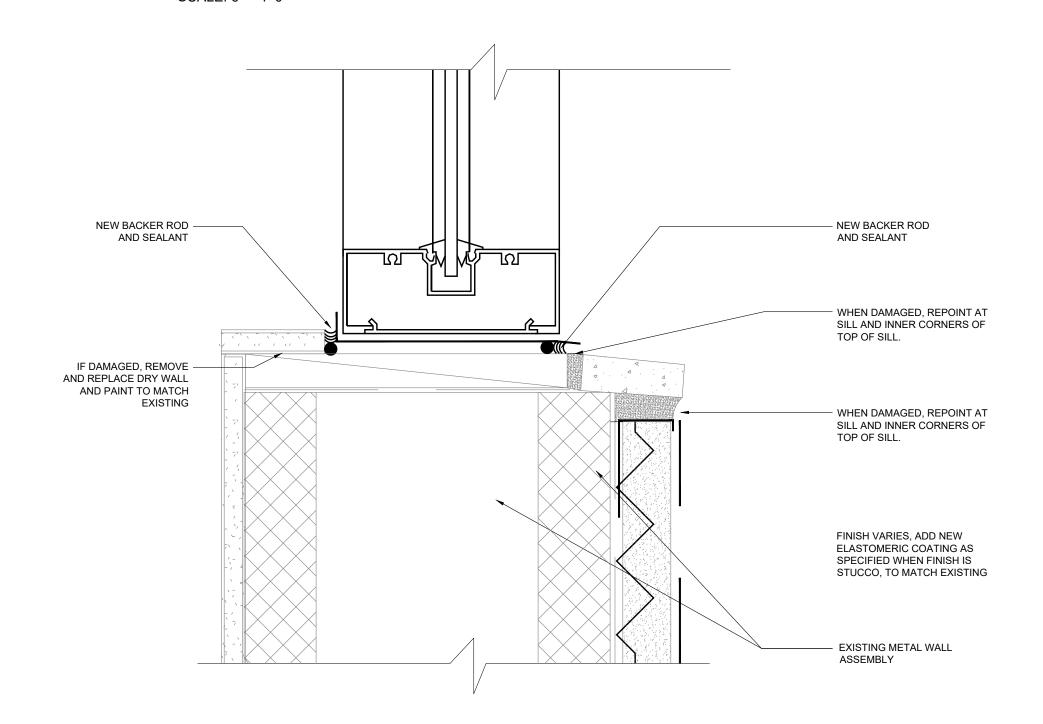


TYPICAL REPAIR @ STONE SILL (HEAD 05 AND JAMB SIM.)


SCALE: 6" = 1'-0"

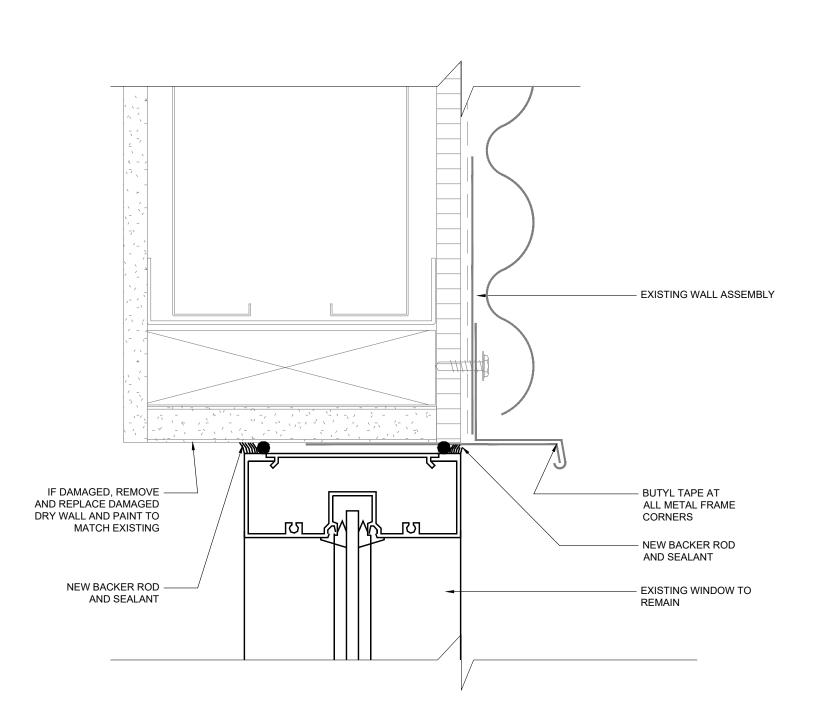


# TYPICAL STOREFRONT SEALANT 01 REPAIR @ WINDOW HEAD SCALE: 6" = 1'-0"

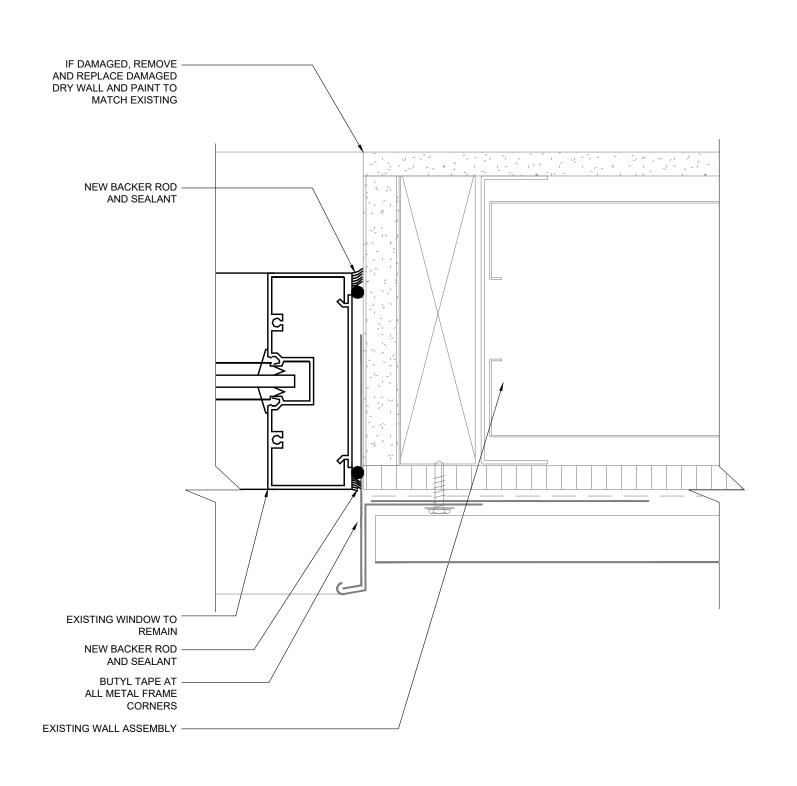


# TYPICAL STOREFRONT SEALANT 03 REPAIR @ WINDOW JAMB

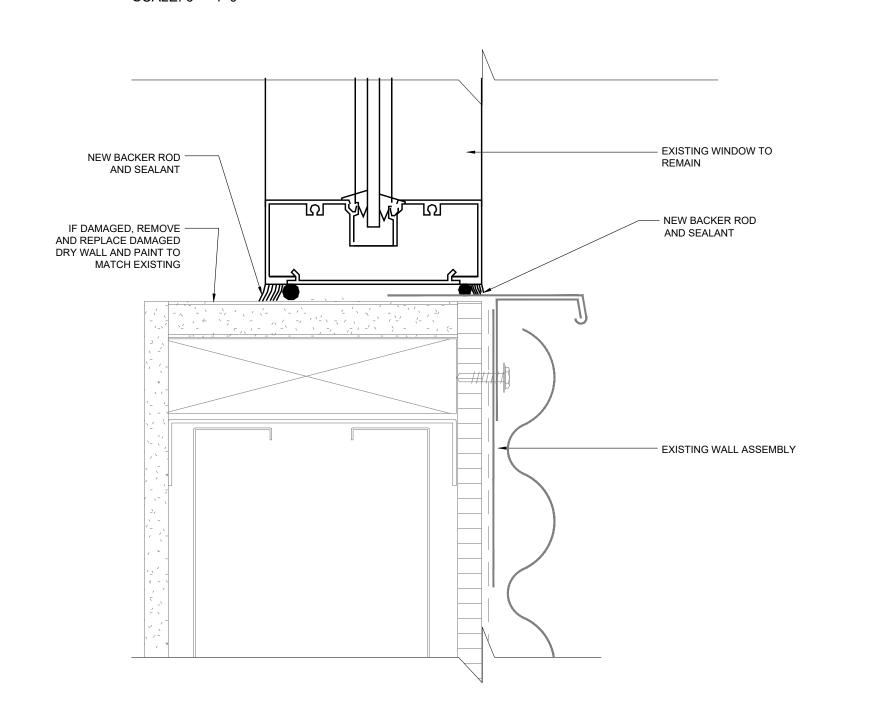


TYPICAL STOREFRONT SEALANT REPAIR @ WINDOW SILL

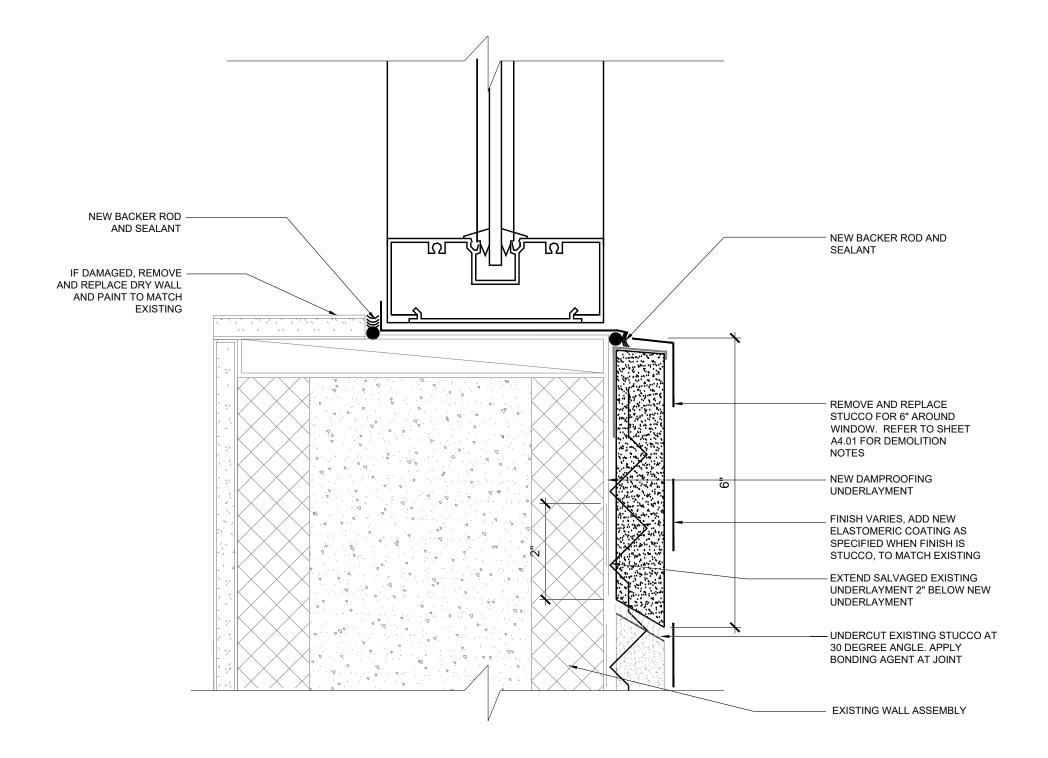


# STUCCO REPAIR @ STOREFRONT -WINDOW SILL

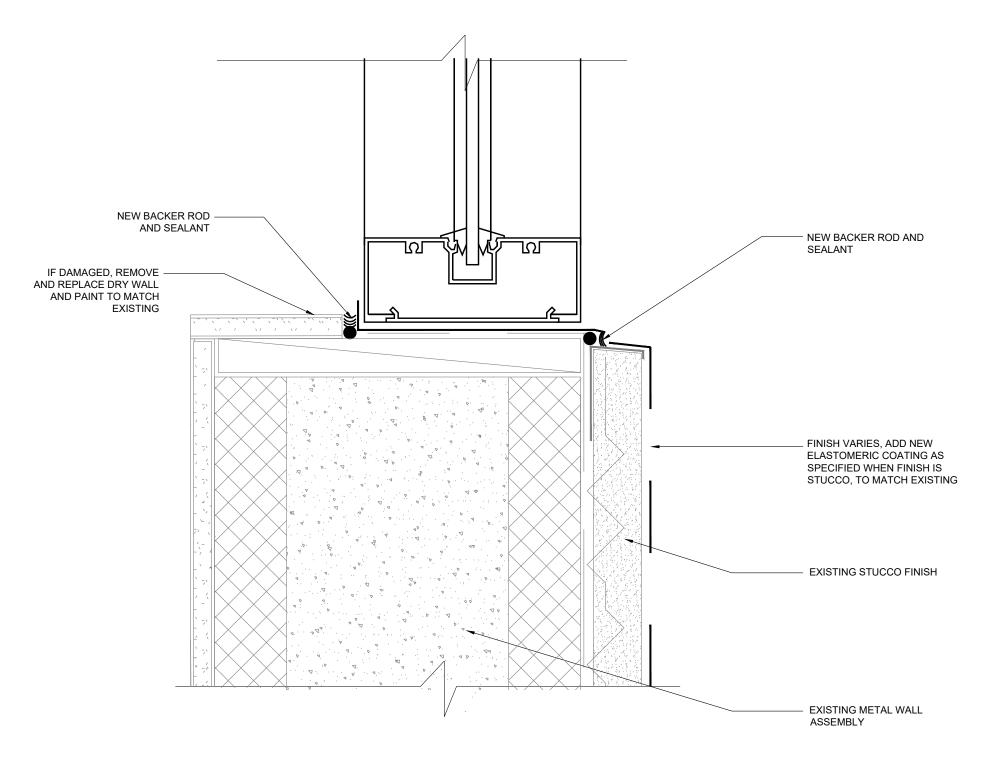


# TYPICAL SEALANT REPAIR @ STOREFRONT - WINDOW SILL

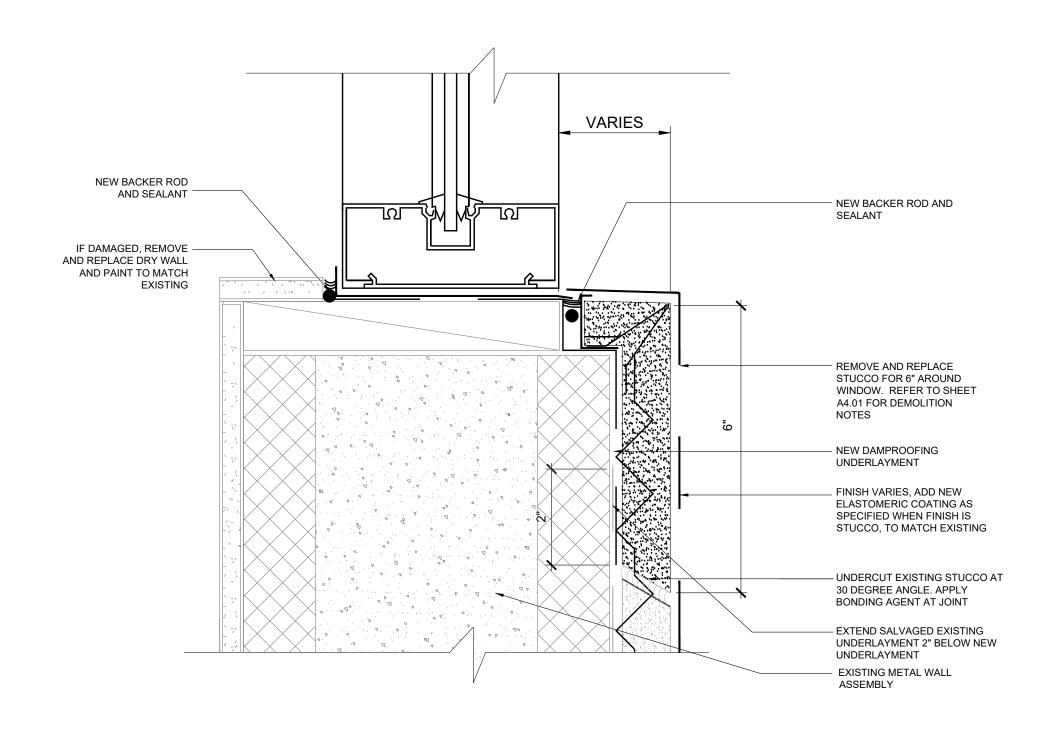


STUCCO REPAIR @ STOREFRONT -WINDOW SILL

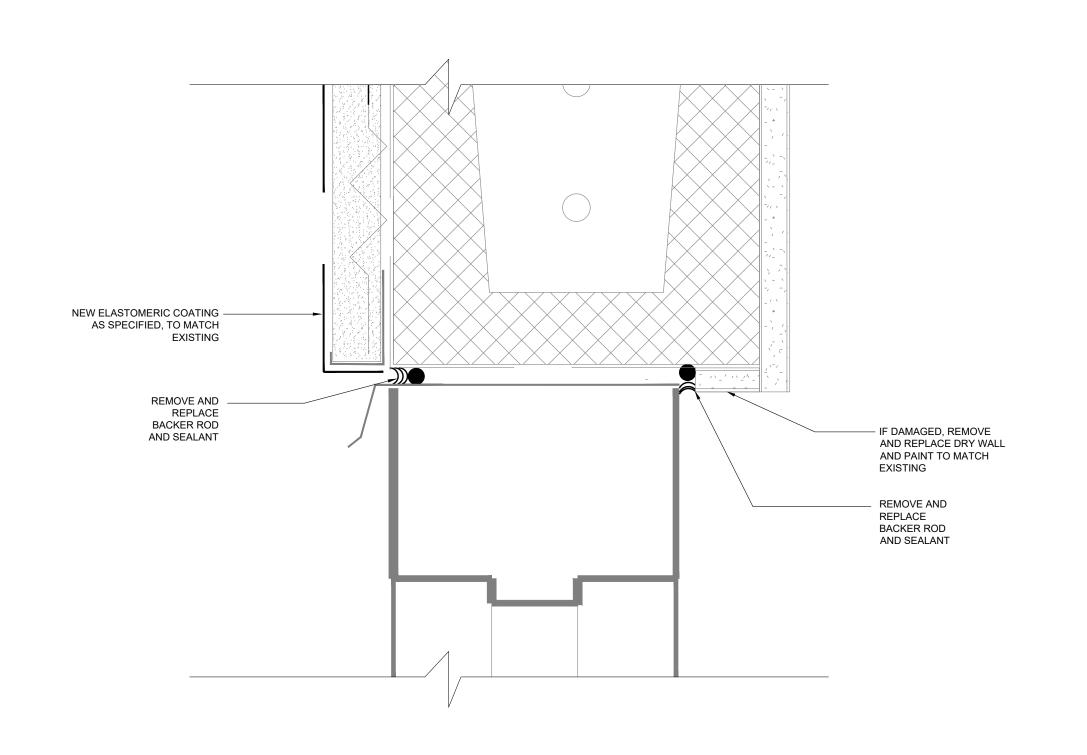


# TYPICAL SEALANT AT METAL DOOR 01 SCALE: 6" = 1'-0" (HEADER VIEW)

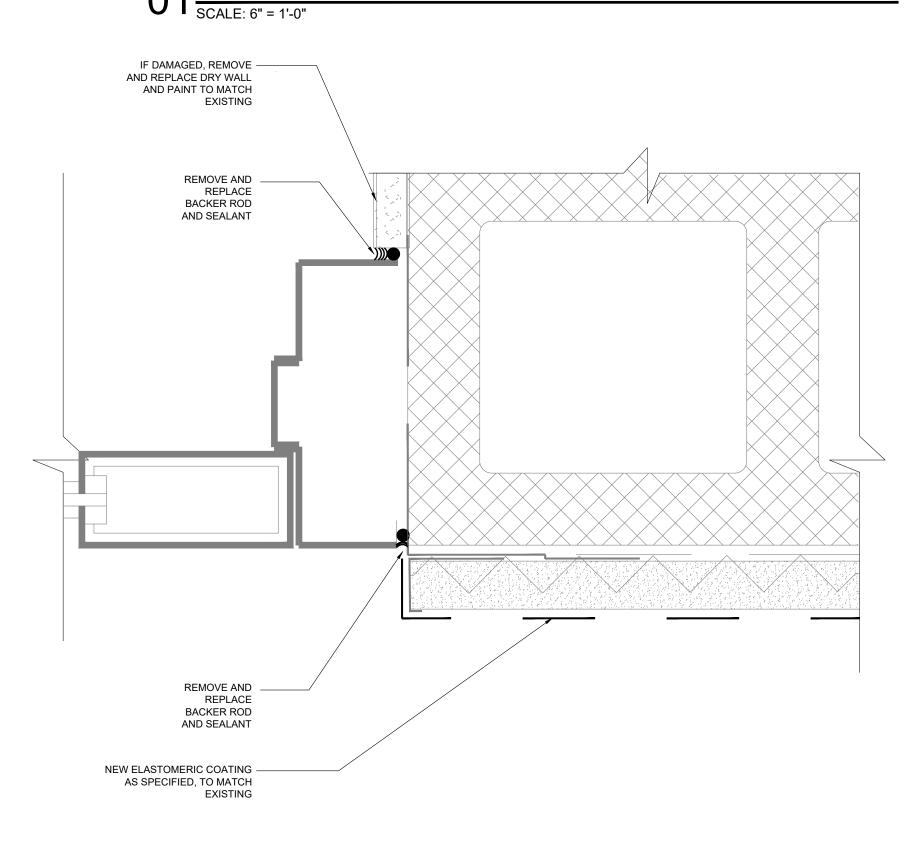


TYPICAL SEALANT AT METAL DOOR 04 SCALE: 6" = 1'-0"

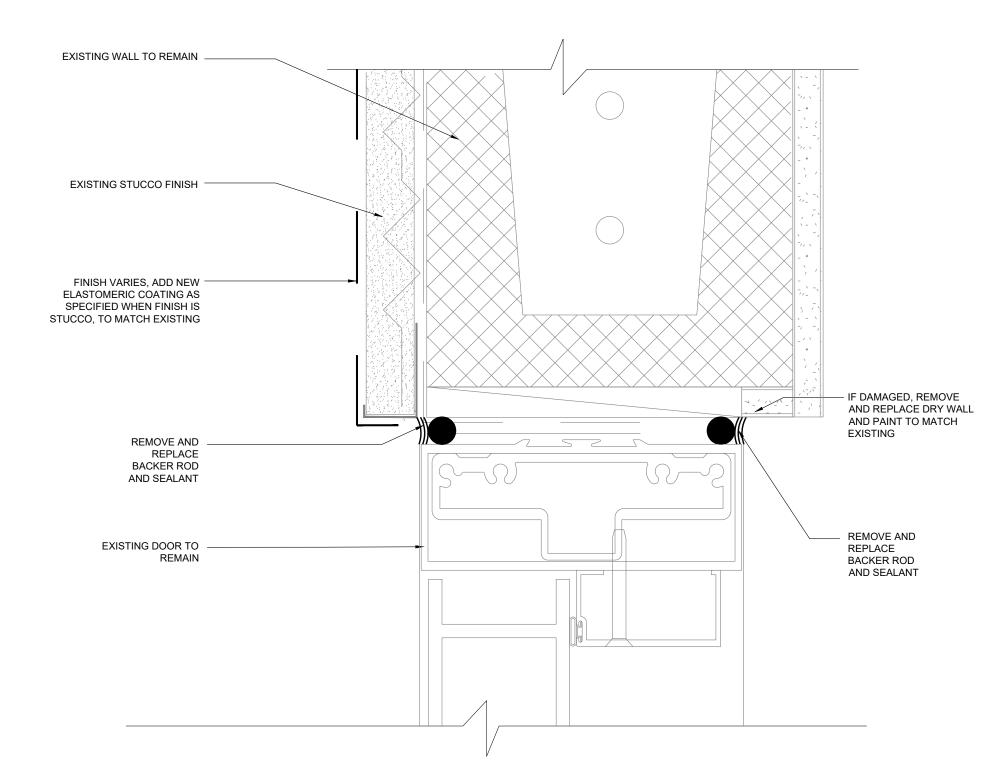


# TYPICAL SEALANT AT STOREFRONT 02 DOOR @ STUCCO (HEADER VIEW)

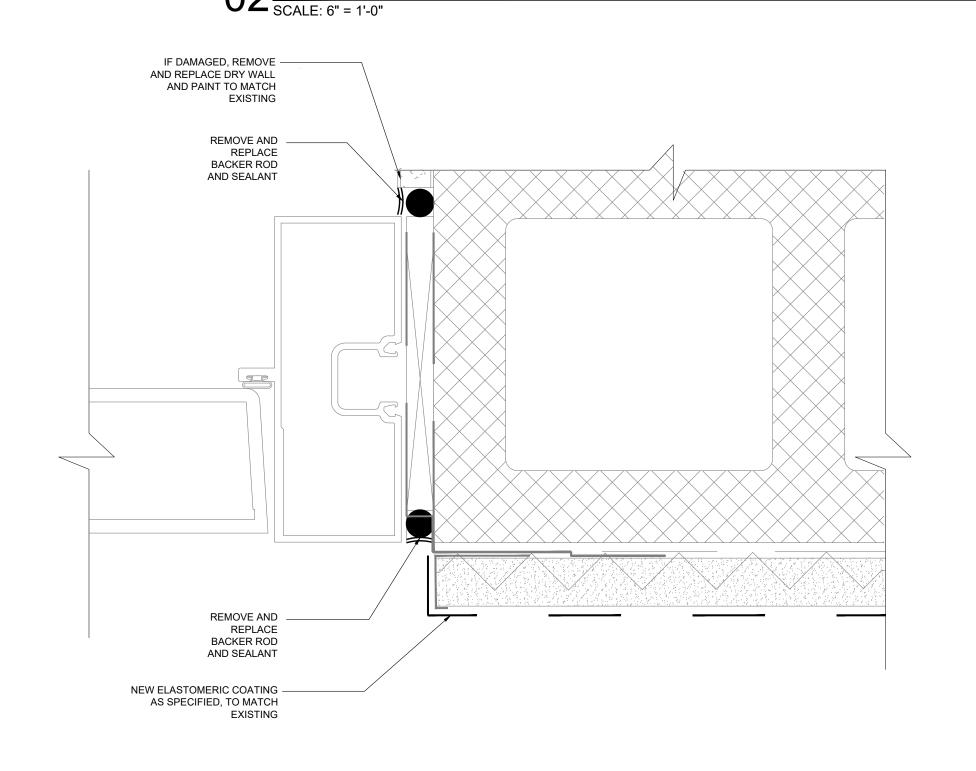


TYPICAL SEALANT AT STOREFRONT 05 DOOR @ STUCCO (JAMB VIEW)

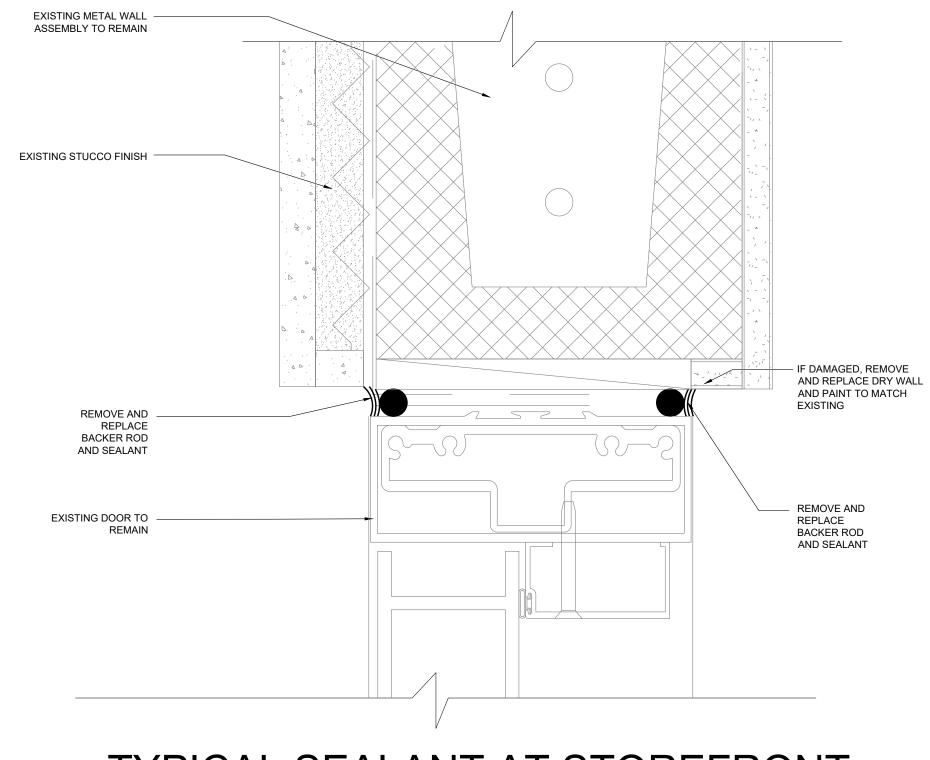


# TYPICAL SEALANT AT STOREFRONT 03 DOOR @ STONE (HEADER VIEW)

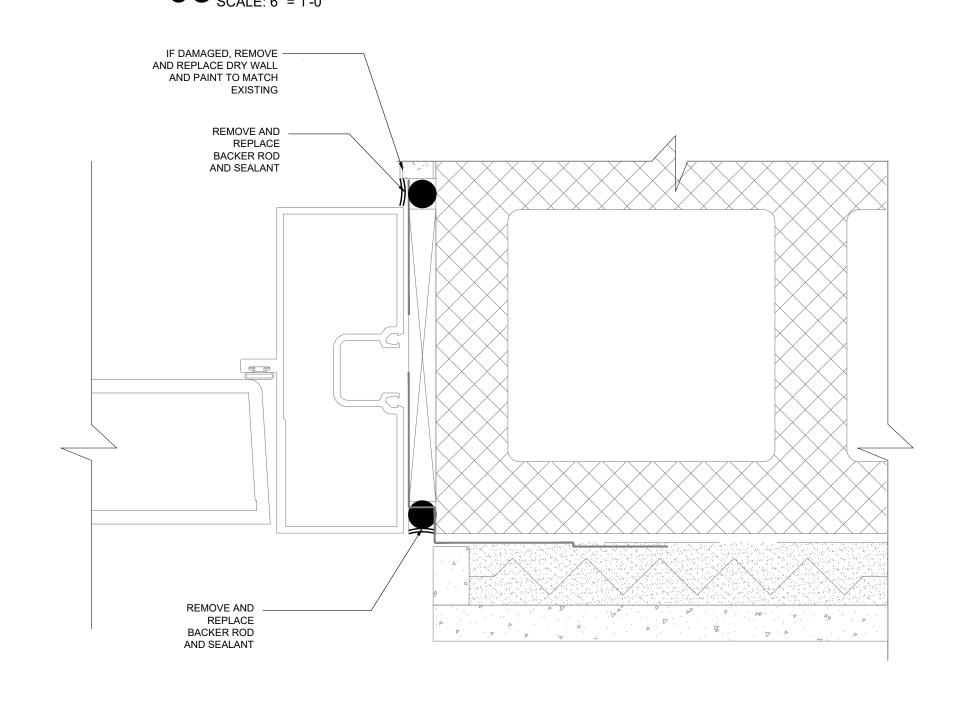

TYPICAL SEALANT AT STOREFRONT 06 DOOR @ STONE (JAMB VIEW)

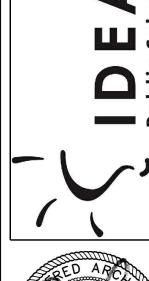

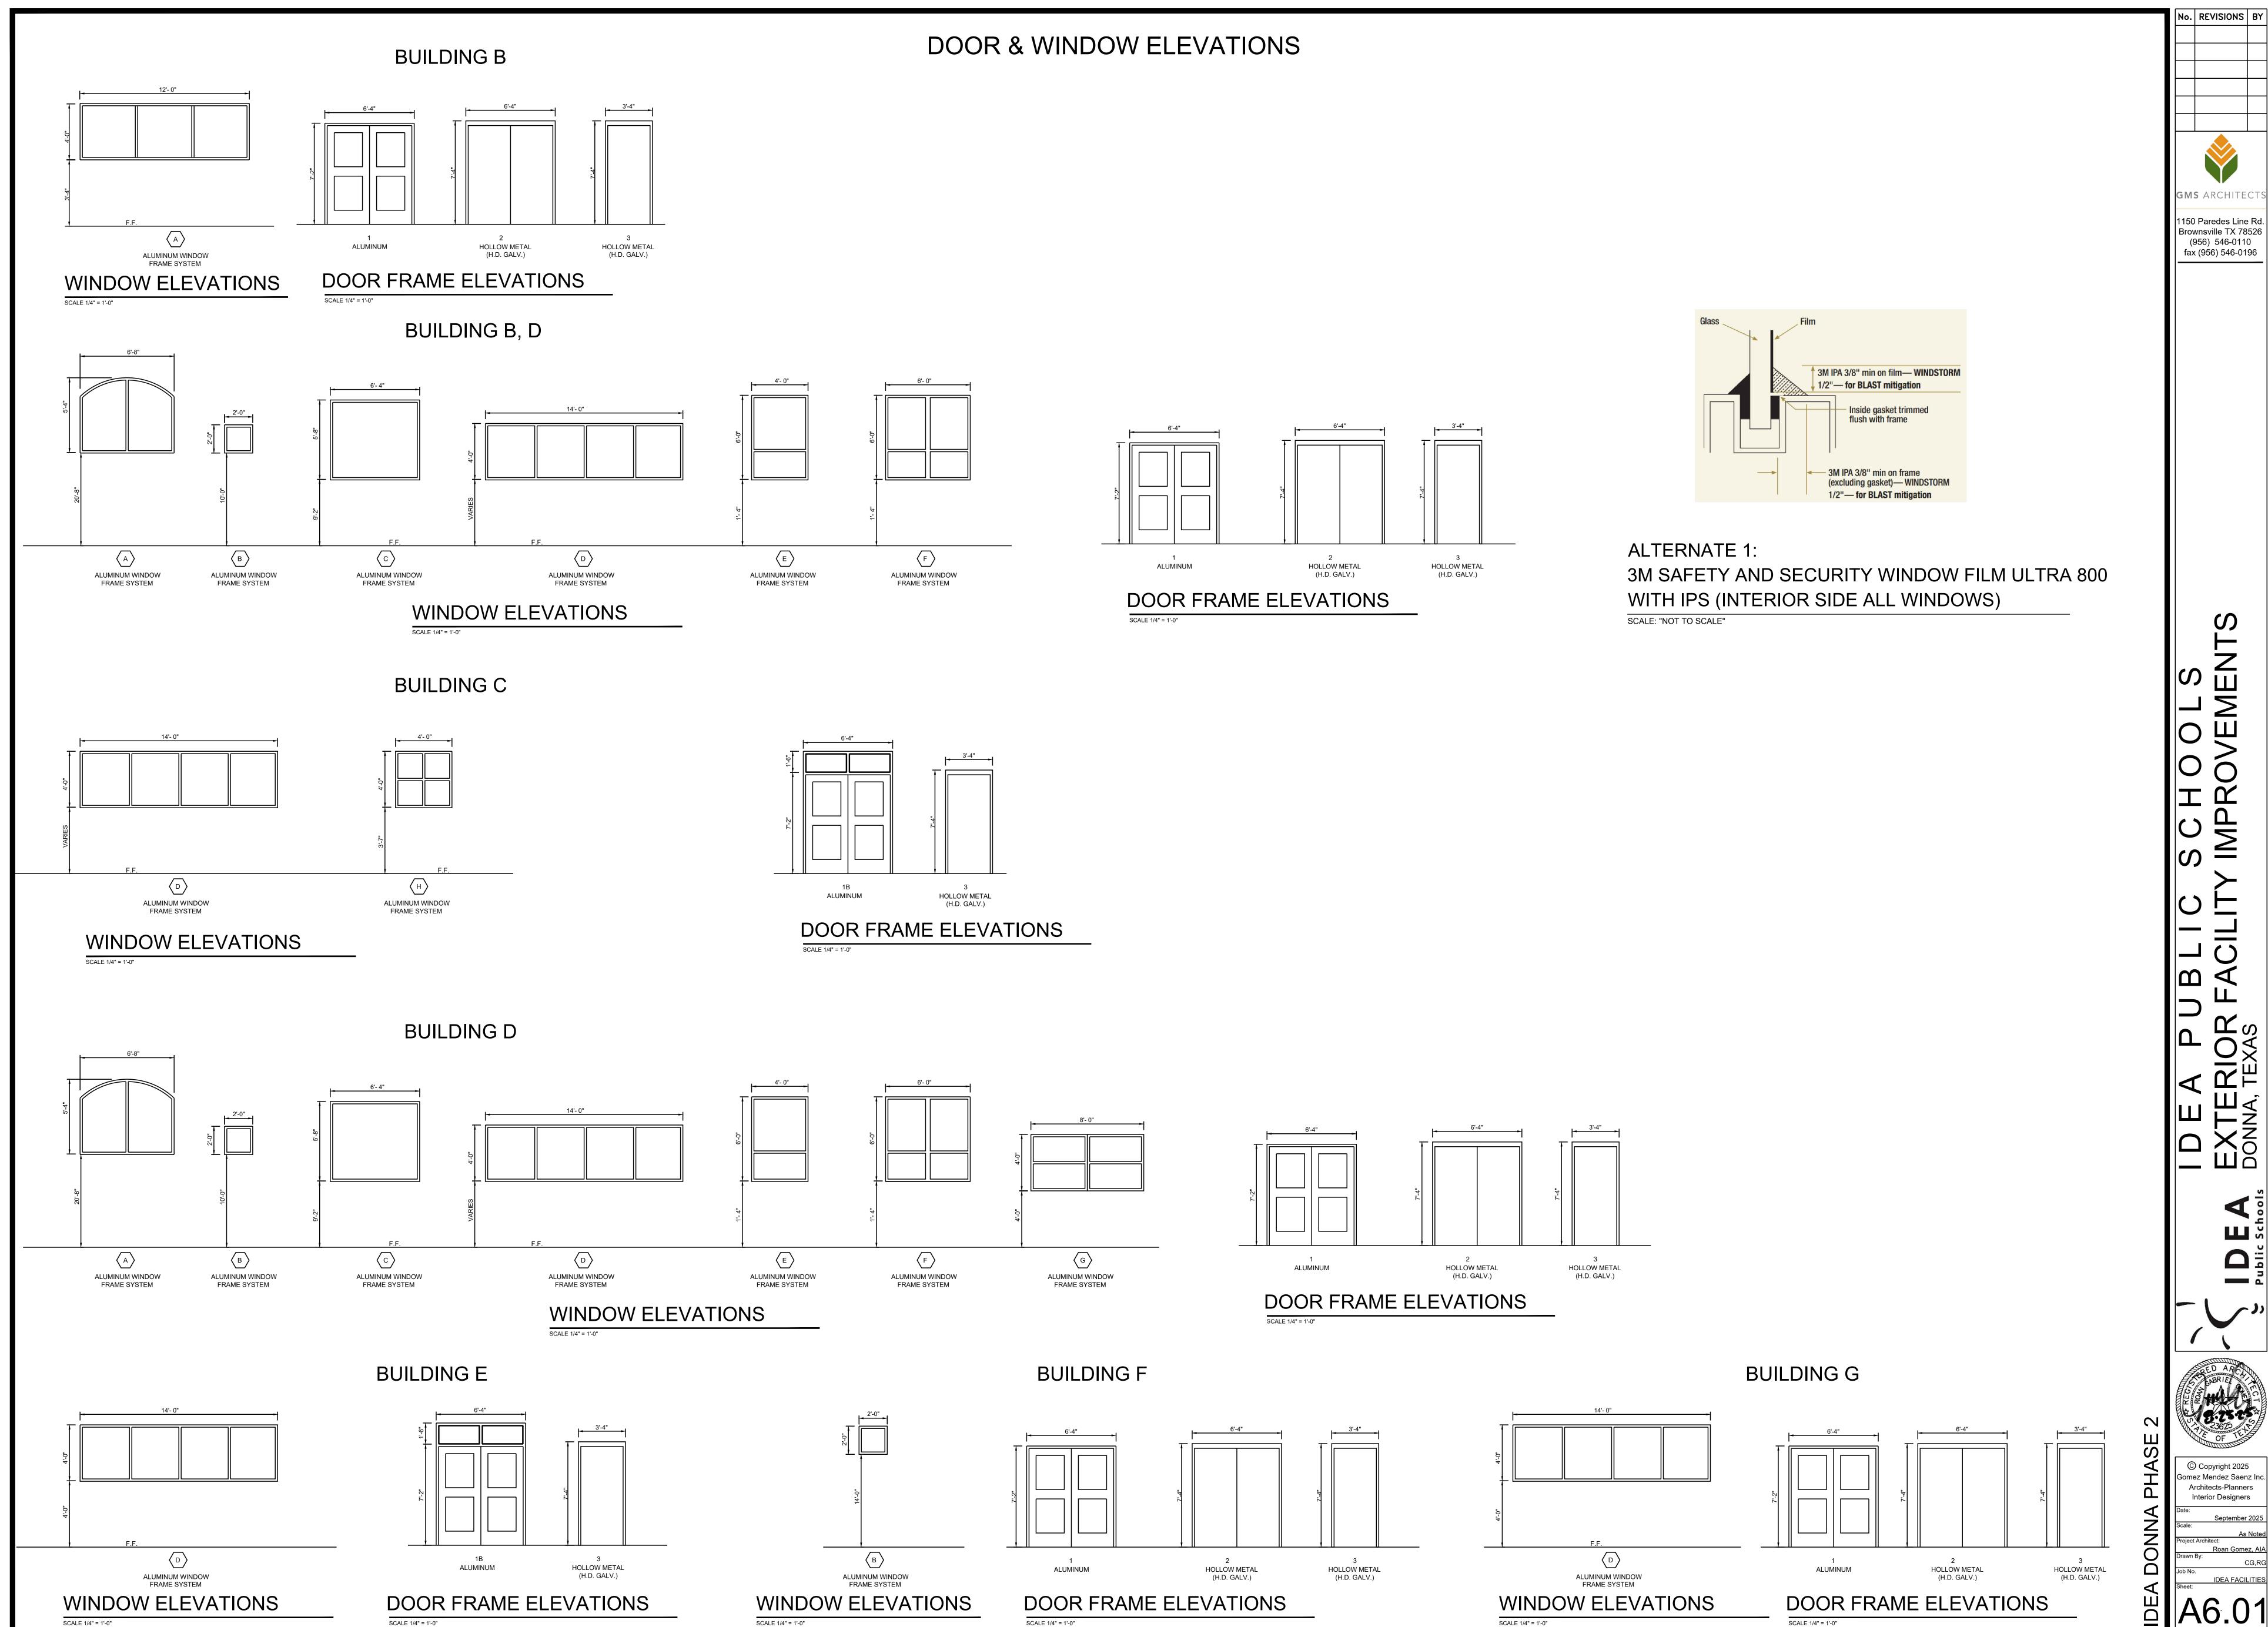

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Architects-Planners