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1 | Page

May 02, 2024

IDEA PS - Plumbing Upgrades at Lower RGV Campuses CSP#27-LRPU-0424

ADDENDUM NO. 2

A. PURPOSE AND INTENT

This addendum is issued for the purpose of modifying the plans for the project referenced above. This addendum shall become part of the contract and all contractors shall be bound by its content. All aspects of the specifications and drawings not covered herein shall remain the same. The General Conditions and the Special Conditions of the specifications shall govern all parts of the work and apply in full force to this addendum.

B. SCOPE

I. Drawings

- 1. Sheet P5.01 See attached.
 - a) Revised Demolition Electrical and Plumbing Plan drawings.
- 2. Sheet P5.02 see attached.
 - a) Revised Demolition Electrical and Plumbing Plan drawings.
 - b) Revised New Electrical and Plumbing Plan drawings.
 - c) Revised Demolition Plumbing Keynotes.
- 3. Sheet P5.03 see attached.
 - a) Revised Electrical and Plumbing Plan drawings.
 - b) Revised New Electrical and Plumbing Plan drawings.
 - c) Revised Demolition Plumbing Keynotes.
- 4. Sheet P5.04 See attached.
 - a) Revised Electrical and Plumbing Plan drawings.
 - b) Revised New Electrical and Plumbing Plan drawings.
 - c) Revised Demolition Plumbing Keynotes.
 - d) Revised Plumbing Keynotes.
 - e) Added Drywell Detail.
- 5. Sheet P5.06 See attached.
 - a) Revised Plumbing Keyed notes.
 - b) Revised Demolition Electrical and Plumbing Plan drawings.

ADDENDUM NO. 2

- 6. Sheet P6.03 See attached.
 - a) Revised Keyplan.
- 7. Sheet P6.04 See attached.
 - a) Revised Keyplan.



ADDENDUM NO. 2 2 | Page

C

CHECKED BY: DRAWN BY: PROJECT NO.:

P5.01

GENERAL NOTES:

- 1. PLUMBING CONTRACTOR SHALL ISOLATE DOMESTIC COLD WATER SYSTEM AT THE WORKING AREAS PRIOR ANY WORK BEING DONE.
- 2. FOR ALL WALL HYDRANTS BEING REPLACED, CONTRACTOR SHALL RETAIN EXISTING BOX/ENCLOSURE AND SHALL REPLACE ALL INTERNAL COMPONENTS. IT WILL BE CONTRACTOR RESPONSIBILITY TO PROVIDE AN EQUAL/SIMILAR HYDRANT TO FIT INTO EXISTING BOX/ENCLOSURE.
- 3. PLUMBING CONTRACTOR SHALL PERFORM ALL WORK CAREFULLY TO NOT DAMAGE BUILDING FACADE/STRUCTURE.

DEMOLITION ELECTRICAL KEYED NOTES:

APPROXIMATE LOCATION OF EXISTING PANELBOARD SERVING ELECTRIC WATER HEATER.

ELECTRICAL NEW KEYED NOTES:

- APPROXIMATE LOCATION OF EXISTING PANELBOARD SERVING ELECTRIC WATER
- 2 CONNECT NEW ELECTRIC WATER HEATER. RETAIN AND REUSE EXISTING BRANCH CIRCUIT. IF EXISTING BRANCH CIRCUIT DOES NOT REACH NEW POINT OF CONNECTION PROVIDE A J-BOX AND EXTEND WIRING AS NECESSARY.

- 2) DISCONNECT EXISTING ELECTRIC WATER HEATER FOR INSTALLATION OF NEW ELECTRIC WATER HEATER. RETAIN AND REUSE EXISTING BRANCH CIRCUIT.

DEMOLITION GENERAL NOTES:

- 1. ALL DEMOLITION WORK SHALL BE DONE IN ACCORDANCE WITH ALL APPLICABLE CODES INCLUDING THOSE PUBLISHED BY OSHA.
- 2. A VISIT TO THE SITE IS REQUIRED TO PROPERLY BID THE DEMOLITION PLUMBING WORK. ALL INFORMATION SHOWN ON THE EXISTING CONSTRUCTION WILL BE REFERENCE ONLY AND WILL NEED TO BE FIELD VERIFIED BY THE CONTRACTOR.
- 3. PROVIDE ALL DEMOLITION WORK REQUIRED FOR THE REMOVAL OF EXISTING NON REUSED PLUMBING EQUIPMENT AND ASSOCIATED DEVICES. PROVIDE A COMPLETE AND OPERABLE SYSTEM UPON COMPLETION OF THE PROJECT.
- 4. COORDINATE DEMOLITION OF DIVISION 22 SYSTEM AS REQUIRED WITH ALL OTHER TRADES.
- 5. ALL EXISTING EQUIPMENT AND MATERIALS REMOVED DURING CONSTRUCTION, THAT IS NOT TO BE REUSED, SHALL BE REMOVED FROM THE JOB SITE AND PROPERLY RETURNED TO THE OWNER, IF DESIRED BY
- COORDINATE WITH OWNER, AND DISPOSE OF EQUIPMENT AND MATERIALS THAT OWNER DOES NOT REMAIN.
- PREPARE AREA FOR INSTALLATION OF NEW PLUMBING SYSTEMS. REFER TO NEW PLANS AND COORDINATE WITH DEMOLITION WORK.


DEMOLITION PLUMBING KEYED NOTES:

- 1 DEMOLISH EXISTING ELECTRIC WATER HEATER AT THIS APPROXIMATE LOCATION.
- 2 DEMOLISH EXISTING DRINKING FOUNTAINS AT THIS APPROXIMATE LOCATION.
- 3 ISOLATE AND DISCONNECT EXISTING COLD AND HOT WATER PIPES SERVING PLUMBING FIXTURE AT THIS APPROXIMATE LOCATION. CONNECT AFTER REPLACING.
- 4 DEMOLISH EXISTING PLUMBING FIXTURES MARKED ON PLANS.
- 5 PREPARE AREA FOR INSTALLATION OF NEW PLUMBING FIXTURES. COORDINATE WITH DEMOLITION.

PLUMBING KEYED NOTES:

- 1 REMOVE AND REPLACE WALL HYDRANT AT THIS APPROXIMATE LOCATION. SEE SCHEDULE ON SHEET P5.11.
- 2 PROVIDE AND INSTALL NEW ELECTRIC WATER HEATER EWH-1 AS SCHEDULED OR AN APPROVED EQUAL. REFER TO P5.11. ADJUST PLUMBING LINES AND FITTINGS AS NECESSARY TO RECEIVE NEW WATER HEATER. REFER TO DETAIL ON DETAIL SHEET P5.11.
- 3) PROVIDE NEW DRINKING FOUNTAINS EDF-1&2 WITH NEW ONES INDICATED ON THE SCHEDULES OR AN APPROVED EQUAL. REFER TO P5.11. ADJUST PLUMBING LINES AND FITTINGS TO THE NEW PLUMBING FIXTURE AS NECESSARY AND REPAIR WALL TO MATCH EXISTING CONDITIONS IF NECESSARY.
- 4 APPROXIMATE LOCATION OF EXISTING ISOLATION VALVE. FIELD VERIFY EXACT LOCATION.

| PLUMBING LEGEND | |
|-----------------|-----------------------------|
| | TO BE DEMOLISHED |
| о ф | WALL HYDRANT TO BE REPLACED |

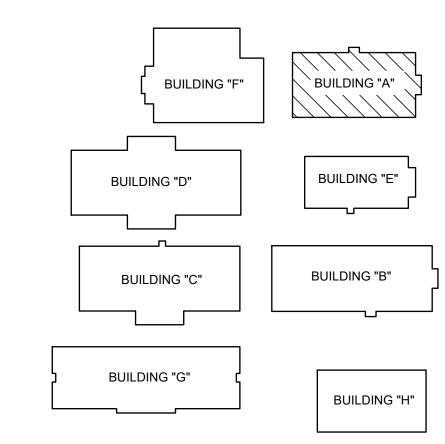

FRONTIER IDEA ACADEMY KEYPLAN



(BUILDING A)

NORTH

1LA

01 DEMOLITION ELECTRICAL AND PLUMBING PLAN

F.E.C.

IDEA FRONTIER

SCALE :3/32" = 1'-0"

NORTH

(BUILDING A)

NO: REVISION: BY

F-15998 APRIL 19, 202 CHECKED BY: C.A.G. DRAWN BY:

PROJECT NO.:

P5.02

DEMOLITION ELECTRICAL KEYED NOTES: 1) APPROXIMATE LOCATION OF EXISTING PANELBOARD SERVING ELECTRIC WATER HEATER.

2) DISCONNECT EXISTING ELECTRIC WATER HEATER FOR INSTALLATION OF NEW


ELECTRIC WATER HEATER. RETAIN AND REUSE EXISTING BRANCH CIRCUIT.

ELECTRICAL NEW KEYED NOTES:

- APPROXIMATE LOCATION OF EXISTING PANELBOARD SERVING ELECTRIC WATER
- 2 CONNECT NEW ELECTRIC WATER HEATER. RETAIN AND REUSE EXISTING BRANCH CIRCUIT. IF EXISTING BRANCH CIRCUIT DOES NOT REACH NEW POINT OF CONNECTION PROVIDE A J-BOX AND EXTEND WIRING AS NECESSARY.


| PLUMBING LEGEND | |
|-----------------|-----------------------------|
| | TO BE DEMOLISHED |
| ○- | WALL HYDRANT TO BE REPLACED |



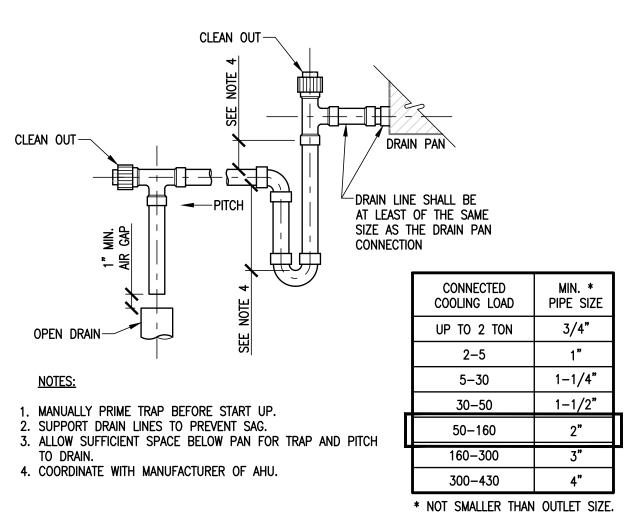

CONDENSATE DRAIN TRAP PIPE

IDEA FRONTIER EXISTING CONDITIONS (BUILDING B - MEZZANINE)

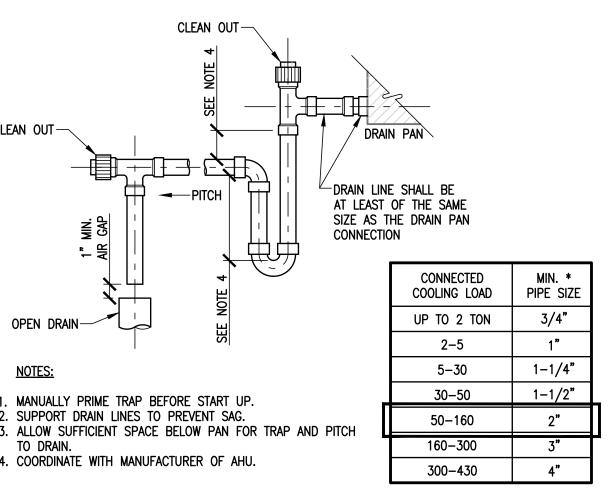

EWH-2 2

- REFER TO 03 EXISTING CONDITIONS

ON THESE SAME SHEET.

REFER TO DETAIL 04 CONDENSATE DRAIN

TRAP PIPE ON THESE SAME SHEET.

1)LB

(BUILDING B)

NORTH

<u>AHU-2</u>

(IN MEZZANINE)

NORTH

IDEA FRONTIER

02 NEW ELECTRICAL AND PLUMBING PLAN

01 DEMOLITION ELECTRICAL AND PLUMBING PLAN

IDEA FRONTIER

(3) PROVIDE NEW 2" SOFT COPPER PIPING FOR CONDENSATE DRAIN LINE OF EXISTING AIR CONDITIONING UNIT AT THIS APPROXIMATE LOCATION. PROVIDE 1" THICK FLEXIBLE ELECTROMETRIC INSULATION FOR NEW CONDENSATE PIPING AND CONNECT INTO EXISTING HUB DRAIN. NEW CONDENSATE PIPE SHALL BE SIZED AS PER AIR CONDITIONING UNIT MANUFACTURER RECOMMENDATIONS, ENSURE TO NOT PROVIDE A SMALLER PIPE SIZE THAN EXISTING.

(4) APPROXIMATE LOCATION OF EXISTING ISOLATION VALVE. FIELD VERIFY EXACT LOCATION.

DEMOLITION GENERAL NOTES:

APPLICABLE CODES INCLUDING THOSE PUBLISHED BY OSHA.

VERIFIED BY THE CONTRACTOR.

THAT OWNER DOES NOT REMAIN.

GENERAL NOTES:

DAMAGE BUILDING FACADE/STRUCTURE.

COORDINATE WITH DEMOLITION.

PLUMBING KEYED NOTES:

HEATER. REFER TO DETAIL ON DETAIL SHEET P5.11.

PLUMBING KEYED NOTES:

DEMOLITION

LOCATION.

EXISTING CONDENSATE

AND REPLACED

PIPING TO BE REMOVED

THE PROJECT.

OTHER TRADES.

1. ALL DEMOLITION WORK SHALL BE DONE IN ACCORDANCE WITH ALL

2. A VISIT TO THE SITE IS REQUIRED TO PROPERLY BID THE DEMOLITION

PLUMBING WORK. ALL INFORMATION SHOWN ON THE EXISTING CONSTRUCTION WILL BE REFERENCE ONLY AND WILL NEED TO BE FIELD

PROVIDE ALL DEMOLITION WORK REQUIRED FOR THE REMOVAL OF EXISTING NON REUSED PLUMBING EQUIPMENT AND ASSOCIATED DEVICES. PROVIDE A COMPLETE AND OPERABLE SYSTEM UPON COMPLETION OF

4. COORDINATE DEMOLITION OF DIVISION 22 SYSTEM AS REQUIRED WITH ALL

5. ALL EXISTING EQUIPMENT AND MATERIALS REMOVED DURING

6. COORDINATE WITH OWNER, AND DISPOSE OF EQUIPMENT AND MATERIALS

TO NEW PLANS AND COORDINATE WITH DEMOLITION WORK.

THE WORKING AREAS PRIOR ANY WORK BEING DONE.

PREPARE AREA FOR INSTALLATION OF NEW PLUMBING SYSTEMS. REFER

PLUMBING CONTRACTOR SHALL ISOLATE DOMESTIC COLD WATER SYSTEM AT

2. FOR ALL WALL HYDRANTS BEING REPLACED, CONTRACTOR SHALL RETAIN

EQUAL/SIMILAR HYDRANT TO FIT INTO EXISTING BOX/ENCLOSURE.

EXISTING BOX/ENCLOSURE AND SHALL REPLACE ALL INTERNAL COMPONENTS. IT WILL BE CONTRACTOR RESPONSIBILITY TO PROVIDE AN

PLUMBING CONTRACTOR SHALL PERFORM ALL WORK CAREFULLY TO NOT

1 DEMOLISH EXISTING ELECTRIC WATER HEATER AT THIS APPROXIMATE

2 DEMOLISH EXISTING CONDENSATE PIPING SERVING HVAC EQUIPMENT AT THIS APPROXIMATE LOCATION.

3 ISOLATE AND DISCONNECT EXISTING COLD AND HOT WATER PIPES SERVING PLUMBING FIXTURE AT THIS APPROXIMATE LOCATION. CONNECT

AFTER REPLACING.


5 PREPARE AREA FOR INSTALLATION OF NEW PLUMBING FIXTURES.

REMOVE AND REPLACE WALL HYDRANT AT THIS APPROXIMATE LOCATION. SEE SCHEDULE ON SHEET P5.11.

2 PROVIDE AND INSTALL NEW ELECTRIC WATER HEATER EWH-2 AS SCHEDULED OR AN APPROVED EQUAL. REFER TO P5.11. ADJUST

PLUMBING LINES AND FITTINGS AS NECESSARY TO RECEIVE NEW WATER

CONSTRUCTION, THAT IS NOT TO BE REUSED, SHALL BE REMOVED FROM THE JOB SITE AND PROPERLY RETURNED TO THE OWNER, IF DESIRED BY

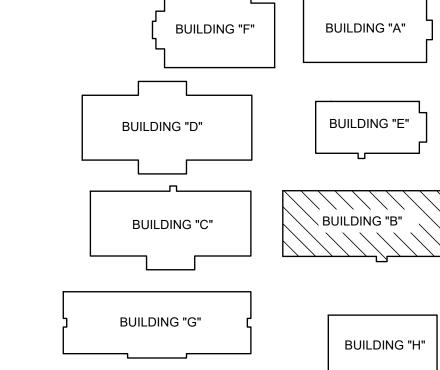

FRONTIER IDEA ACADEMY KEYPLAN



NO: REVISION: BY

APRIL 19, 202 CHECKED BY: DRAWN BY: PROJECT NO.:

P5.03

BUILDING "A"

BUILDING "E"

BUILDING "B"

BUILDING "H"

GENERAL NOTES:

1. PLUMBING CONTRACTOR SHALL ISOLATE DOMESTIC COLD WATER SYSTEM AT THE WORKING AREAS PRIOR ANY WORK BEING DONE.

2. FOR ALL WALL HYDRANTS BEING REPLACED, CONTRACTOR SHALL RETAIN EXISTING BOX/ENCLOSURE AND SHALL REPLACE ALL INTERNAL COMPONENTS. IT WILL BE CONTRACTOR RESPONSIBILITY TO PROVIDE AN EQUAL/SIMILAR HYDRANT TO FIT INTO EXISTING BOX/ENCLOSURE.

3. PLUMBING CONTRACTOR SHALL PERFORM ALL WORK CAREFULLY TO NOT DAMAGE BUILDING FACADE/STRUCTURE.

DEMOLITION ELECTRICAL KEYED NOTES:

- 1 APPROXIMATE LOCATION OF EXISTING PANELBOARD SERVING ELECTRIC WATER
- DISCONNECT EXISTING ELECTRIC WATER HEATER FOR INSTALLATION OF NEW ELECTRIC WATER HEATER. RETAIN AND REUSE EXISTING BRANCH CIRCUIT.

ELECTRICAL NEW KEYED NOTES:

- CONNECTION PROVIDE A J-BOX AND EXTEND WIRING AS NECESSARY.


- APPROXIMATE LOCATION OF EXISTING PANELBOARD SERVING ELECTRIC WATER
- CONNECT NEW ELECTRIC WATER HEATER. RETAIN AND REUSE EXISTING BRANCH CIRCUIT. IF EXISTING BRANCH CIRCUIT DOES NOT REACH NEW POINT OF

2 DEMOLISH EXISTING CONDENSATE PIPING THAT WILL NO LONGER BE USED AT THIS APPROXIMATE LOCATION NEAR THE 2" HUB DRAIN ON 3 ISOLATE AND DISCONNECT EXISTING COLD AND HOT WATER PIPES SERVING PLUMBING FIXTURE AT THIS APPROXIMATE LOCATION. CONNECT AFTER REPLACING. 4 NOT USED. 5 PREPARE AREA FOR INSTALLATION OF NEW PLUMBING FIXTURES. COORDINATE WITH DEMOLITION.



03 EXISTING CONDITIONS AHU-3&4

(BUILDING C - MEZZANINE)

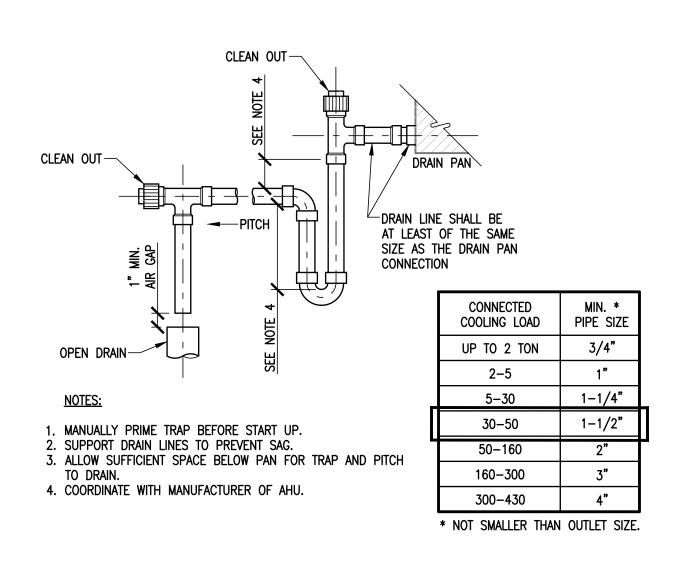

CONDENSATE DRAIN

IDEA FRONTIER

REFER TO 03 EXISTING CONDITIONS

ON THESE SAME SHEET.

(BUILDING C)

REFER TO 04 CONDENSATE DRAIN TRAP

PIPE ON THESE SAME SHEET.

(BUILDING C)

NORTH

(E)BV (E)BV

IDEA FRONTIER

IDEA FRONTIER

02 NEW ELECTRICAL AND PLUMBING PLAN

01 DEMOLITION ELECTRICAL AND PLUMBING PLAN

- REFER TO 03 EXISTING CONDITIONS

ON THESE SAME SHEET.

- REFER TO 04 CONDENSATE DRAIN TRAP

PIPE ON THESE SAME SHEET.

TRAP PIPE

BUILDING "G"

DEMOLITION GENERAL NOTES:

VERIFIED BY THE CONTRACTOR.

THAT OWNER DOES NOT REMAIN.

THE PROJECT.

OTHER TRADES.

DEMOLITION

1. ALL DEMOLITION WORK SHALL BE DONE IN ACCORDANCE WITH ALL APPLICABLE CODES INCLUDING THOSE PUBLISHED BY OSHA.

2. A VISIT TO THE SITE IS REQUIRED TO PROPERLY BID THE DEMOLITION

PLUMBING WORK. ALL INFORMATION SHOWN ON THE EXISTING

CONSTRUCTION WILL BE REFERENCE ONLY AND WILL NEED TO BE FIELD

PROVIDE ALL DEMOLITION WORK REQUIRED FOR THE REMOVAL OF

EXISTING NON REUSED PLUMBING EQUIPMENT AND ASSOCIATED DEVICES.

PROVIDE A COMPLETE AND OPERABLE SYSTEM UPON COMPLETION OF

4. COORDINATE DEMOLITION OF DIVISION 22 SYSTEM AS REQUIRED WITH ALL

5. ALL EXISTING EQUIPMENT AND MATERIALS REMOVED DURING CONSTRUCTION, THAT IS NOT TO BE REUSED, SHALL BE REMOVED FROM THE JOB SITE AND PROPERLY RETURNED TO THE OWNER, IF DESIRED BY

COORDINATE WITH OWNER, AND DISPOSE OF EQUIPMENT AND MATERIALS

PREPARE AREA FOR INSTALLATION OF NEW PLUMBING SYSTEMS. REFER

1 DEMOLISH EXISTING ELECTRIC WATER HEATER AT THIS APPROXIMATE

1 REMOVE AND REPLACE WALL HYDRANT AT THIS APPROXIMATE LOCATION. SEE SCHEDULE ON SHEET P5.11.

2) PROVIDE AND INSTALL NEW ELECTRIC WATER HEATER EWH-3 AS

(3) PROVIDE NEW 1-1/2" SOFT COPPER PIPING FOR CONDENSATE DRAIN LINE OF EXISTING AIR CONDITIONING UNIT AT THIS APPROXIMATE LOCATION. PROVIDE 1" THICK FLEXIBLE ELECTROMETRIC INSULATION FOR

(4) APPROXIMATE LOCATION OF EXISTING ISOLATION VALVE. FIELD VERIFY

PLUMBING LEGEND

○ ◆

TO BE DEMOLISHED

NEW CONDENSATE PIPE

WALL HYDRANT TO BE REPLACED

BUILDING "F"

BUILDING "D"

BUILDING "C"

SCHEDULED OR AN APPROVED EQUAL. REFER TO P5.11. ADJUST PLUMBING LINES AND FITTINGS AS NECESSARY TO RECEIVE NEW WATER

NEW CONDENSATE PIPING AND CONNECT INTO EXISTING HUB DRAIN. NEW CONDENSATE PIPE SHALL BE SIZED AS PER AIR CONDITIONING UNIT MANUFACTURER RECOMMENDATIONS, ENSURE TO NOT PROVIDE A SMALLER PIPE SIZE THAN EXISTING.


TO NEW PLANS AND COORDINATE WITH DEMOLITION WORK.

PLUMBING KEYED NOTES:

PLUMBING KEYED NOTES:

HEATER. REFER TO DETAIL ON DETAIL SHEET P5.11.



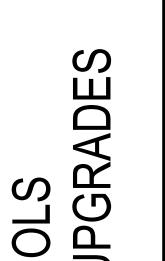

NO: REVISION:

G

 Δ

APRIL 19, 202 CHECKED BY: DRAWN BY:

PROJECT NO.:

P5.04

DEMOLITION GENERAL NOTES: 1. ALL DEMOLITION WORK SHALL BE DONE IN ACCORDANCE WITH ALL

2. A VISIT TO THE SITE IS REQUIRED TO PROPERLY BID THE DEMOLITION PLUMBING WORK. ALL INFORMATION SHOWN ON THE EXISTING CONSTRUCTION WILL BE REFERENCE ONLY AND WILL NEED TO BE FIELD VERIFIED BY THE CONTRACTOR.

APPLICABLE CODES INCLUDING THOSE PUBLISHED BY OSHA.

PROVIDE ALL DEMOLITION WORK REQUIRED FOR THE REMOVAL OF EXISTING NON REUSED PLUMBING EQUIPMENT AND ASSOCIATED DEVICES. PROVIDE A COMPLETE AND OPERABLE SYSTEM UPON COMPLETION OF THE PROJECT.

COORDINATE DEMOLITION OF DIVISION 22 SYSTEM AS REQUIRED WITH ALL OTHER TRADES.

5. ALL EXISTING EQUIPMENT AND MATERIALS REMOVED DURING CONSTRUCTION, THAT IS NOT TO BE REUSED, SHALL BE REMOVED FROM THE JOB SITE AND PROPERLY RETURNED TO THE OWNER, IF DESIRED BY

COORDINATE WITH OWNER, AND DISPOSE OF EQUIPMENT AND MATERIALS THAT OWNER DOES NOT REMAIN.

PREPARE AREA FOR INSTALLATION OF NEW PLUMBING SYSTEMS. REFER

DEMOLITION PLUMBING KEYED NOTES:

1 DEMOLISH EXISTING ELECTRIC WATER HEATER AT THIS APPROXIMATE LOCATION.


TO NEW PLANS AND COORDINATE WITH DEMOLITION WORK.

- 2 DEMOLISH EXISTING CONDENSATE PIPING THAT WILL NO LONGER BE USED AT THIS APPROXIMATE LOCATION NEAR THE 2" HUB DRAIN ON
- 3 ISOLATE AND DISCONNECT EXISTING COLD AND HOT WATER PIPES SERVING PLUMBING FIXTURE AT THIS APPROXIMATE LOCATION. CONNECT AFTER REPLACING.
- 5 PREPARE AREA FOR INSTALLATION OF NEW PLUMBING FIXTURES. COORDINATE WITH DEMOLITION.
 - 6 DEMOLISH EXISTING SANITARY SEWER PIPING SERVING CONDENSATE LINES FROM AIR HANDLER UNITS (AHU-5&6) AS SHOWN ON PLANS. FIELD VERIFY EXACT LOCATION AND EXISTING CONDITIONS PRIOR COMMENCING WORK.
 - 7 REMOVE TEMPORARILY AND STORE EXISTING CEILING TILES AS NECESSARY TO ACCOMMODATE NEW SANITARY SEWER LINES. (TYPICAL)

PLUMBING KEYED NOTES:

- (1) REMOVE AND REPLACE WALL HYDRANT AT THIS APPROXIMATE LOCATION. SEE SCHEDULE ON SHEET P5.11.
- (2) PROVIDE AND INSTALL NEW ELECTRIC WATER HEATER EWH-4 AS SCHEDULED OR AN APPROVED EQUAL. REFER TO P5.11. ADJUST PLUMBING LINES AND FITTINGS AS NECESSARY TO RECEIVE NEW WATER HEATER. REFER TO DETAIL ON DETAIL SHEET P5.11.
- 3 PROVIDE NEW 1-1/2" SOFT COPPER PIPING FOR CONDENSATE DRAIN LINE OF EXISTING AIR CONDITIONING UNIT AT THIS APPROXIMATE LOCATION. PROVIDE 1" THICK FLEXIBLE ELECTROMETRIC INSULATION FOR NEW CONDENSATE PIPING AND CONNECT INTO EXISTING HUB DRAIN. NEW CONDENSATE PIPE SHALL BE SIZED AS PER AIR CONDITIONING UNIT MANUFACTURER RECOMMENDATIONS, ENSURE TO NOT PROVIDE A SMALLER PIPE SIZE THAN EXISTING.
- (4) APPROXIMATE LOCATION OF EXISTING ISOLATION VALVE. FIELD VERIFY EXACT LOCATION.
- (5) PROVIDE NEW 3" WASTE PIPING TO SERVE CONDENSATE PIPING FROM EXISTING AIR HANDLER UNITS (AHU 5&6). ROUTE PIPING ABOVE MEZZANINE FLOOR LEVEL.
- (6) 3" SANITARY SEWER PIPE DOWN TO DISCHARGE INTO NEW DRYWELL AT THIS APPROXIMATE LOCATION. REUSE EXISTING WALL PENETRATION.
 REPAIR AND SEAL WALL AS PER SPECS AND MATCH EXISTING
- 7 PROVIDE DRYWELL TO SERVE CONDENSATE DRAIN LINE AT THIS APPROXIMATE LOCATION, SEE ASSOCIATED DETAIL ON DETAIL SHEET.

| PLUMBING LEGEND | | |
|-----------------|-----------------------------|--|
| | TO BE DEMOLISHED | |
| | NEW CONDENSATE PIPE | |
| ○ | WALL HYDRANT TO BE REPLACED | |

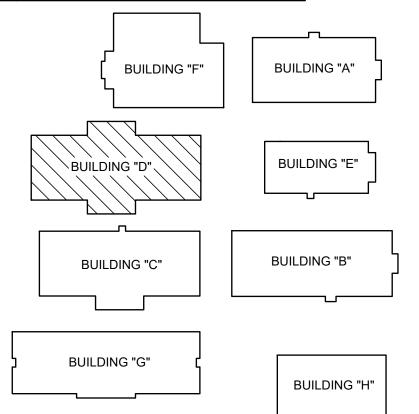

FRONTIER IDEA ACADEMY KEYPLAN

DEMOLITION ELECTRICAL KEYED NOTES:

1. PLUMBING CONTRACTOR SHALL ISOLATE DOMESTIC COLD WATER SYSTEM AT THE

2. FOR ALL WALL HYDRANTS BEING REPLACED, CONTRACTOR SHALL RETAIN EXISTING

BOX/ENCLOSURE AND SHALL REPLACE ALL INTERNAL COMPONENTS. IT WILL BE

CONTRACTOR RESPONSIBILITY TO PROVIDE AN EQUAL/SIMILAR HYDRANT TO FIT INTO

- 1 APPROXIMATE LOCATION OF EXISTING PANELBOARD SERVING ELECTRIC WATER
- 2) DISCONNECT EXISTING ELECTRIC WATER HEATER FOR INSTALLATION OF NEW ELECTRIC WATER HEATER. RETAIN AND REUSE EXISTING BRANCH CIRCUIT.

ELECTRICAL NEW KEYED NOTES:

- APPROXIMATE LOCATION OF EXISTING PANELBOARD SERVING ELECTRIC WATER
- 2 CONNECT NEW ELECTRIC WATER HEATER. RETAIN AND REUSE EXISTING BRANCH CIRCUIT. IF EXISTING BRANCH CIRCUIT DOES NOT REACH NEW POINT OF CONNECTION PROVIDE A J-BOX AND EXTEND WIRING AS NECESSARY.



EXISTING WASTE PIPING TO BE REMOVED AND REPLACED AS SHOWN ON

(BUILDING D - MEZZANINE) CLEAN OUT

PIPE SIZE

3/4"

1-1/4"

1-1/2"

2-5

5-30


30-50

50-160

160-300

300-430

* NOT SMALLER THAN OUTLET SIZE.

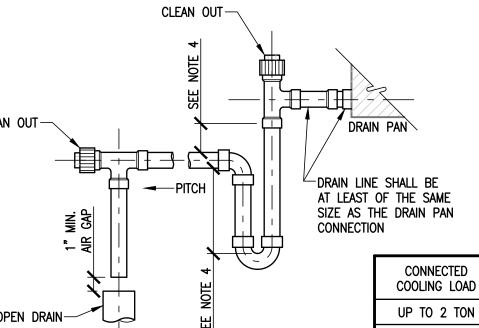


OPEN DRAIN-

MANUALLY PRIME TRAP BEFORE START UP. . SUPPORT DRAIN LINES TO PREVENT SAG. 3. ALLOW SUFFICIENT SPACE BELOW PAN FOR TRAP AND PITCH

4. COORDINATE WITH MANUFACTURER OF AHU.

CONDENSATE DRAIN

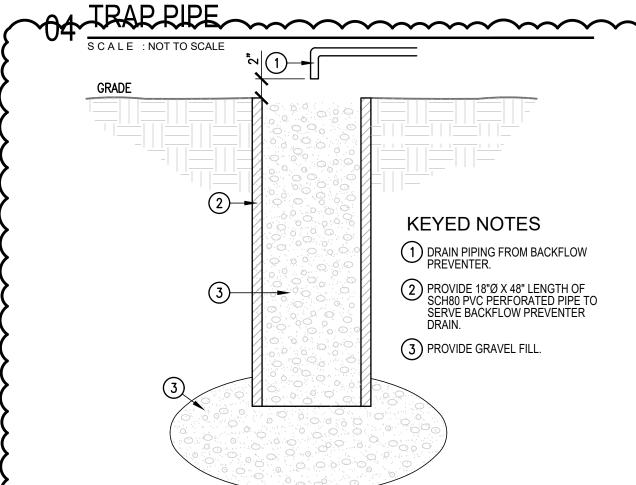

IDEA FRONTIER

IDEA FRONTIER

01 DEMOLITION ELECTRICAL AND PLUMBING PLAN

02 NEW ELECTRICAL AND PLUMBING PLAN

(BUILDING D)

 $\langle 1 \rangle$

REFER TO 03 EXISTING CONDITIONS

ON THESE SAME SHEET.

(BUILDING D)

PIPE ON THESE SAME SHEET.

NORTH

NORTH

3. PLUMBING CONTRACTOR SHALL PERFORM ALL WORK CAREFULLY TO NOT DAMAGE BUILDING FACADE/STRUCTURE.

WORKING AREAS PRIOR ANY WORK BEING DONE.

GENERAL NOTES:

EXISTING BOX/ENCLOSURE.

TO 03 EXISTING CONDITIONS

ON THESE SAME SHEET.

<u>3"HD</u>

TO 04 CONDENSATE DRAIN TRAP

PE ON THESE SAME SHEET.

NO: REVISION: BY:

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COPY NO:

CSP # 27-LRPU-0424

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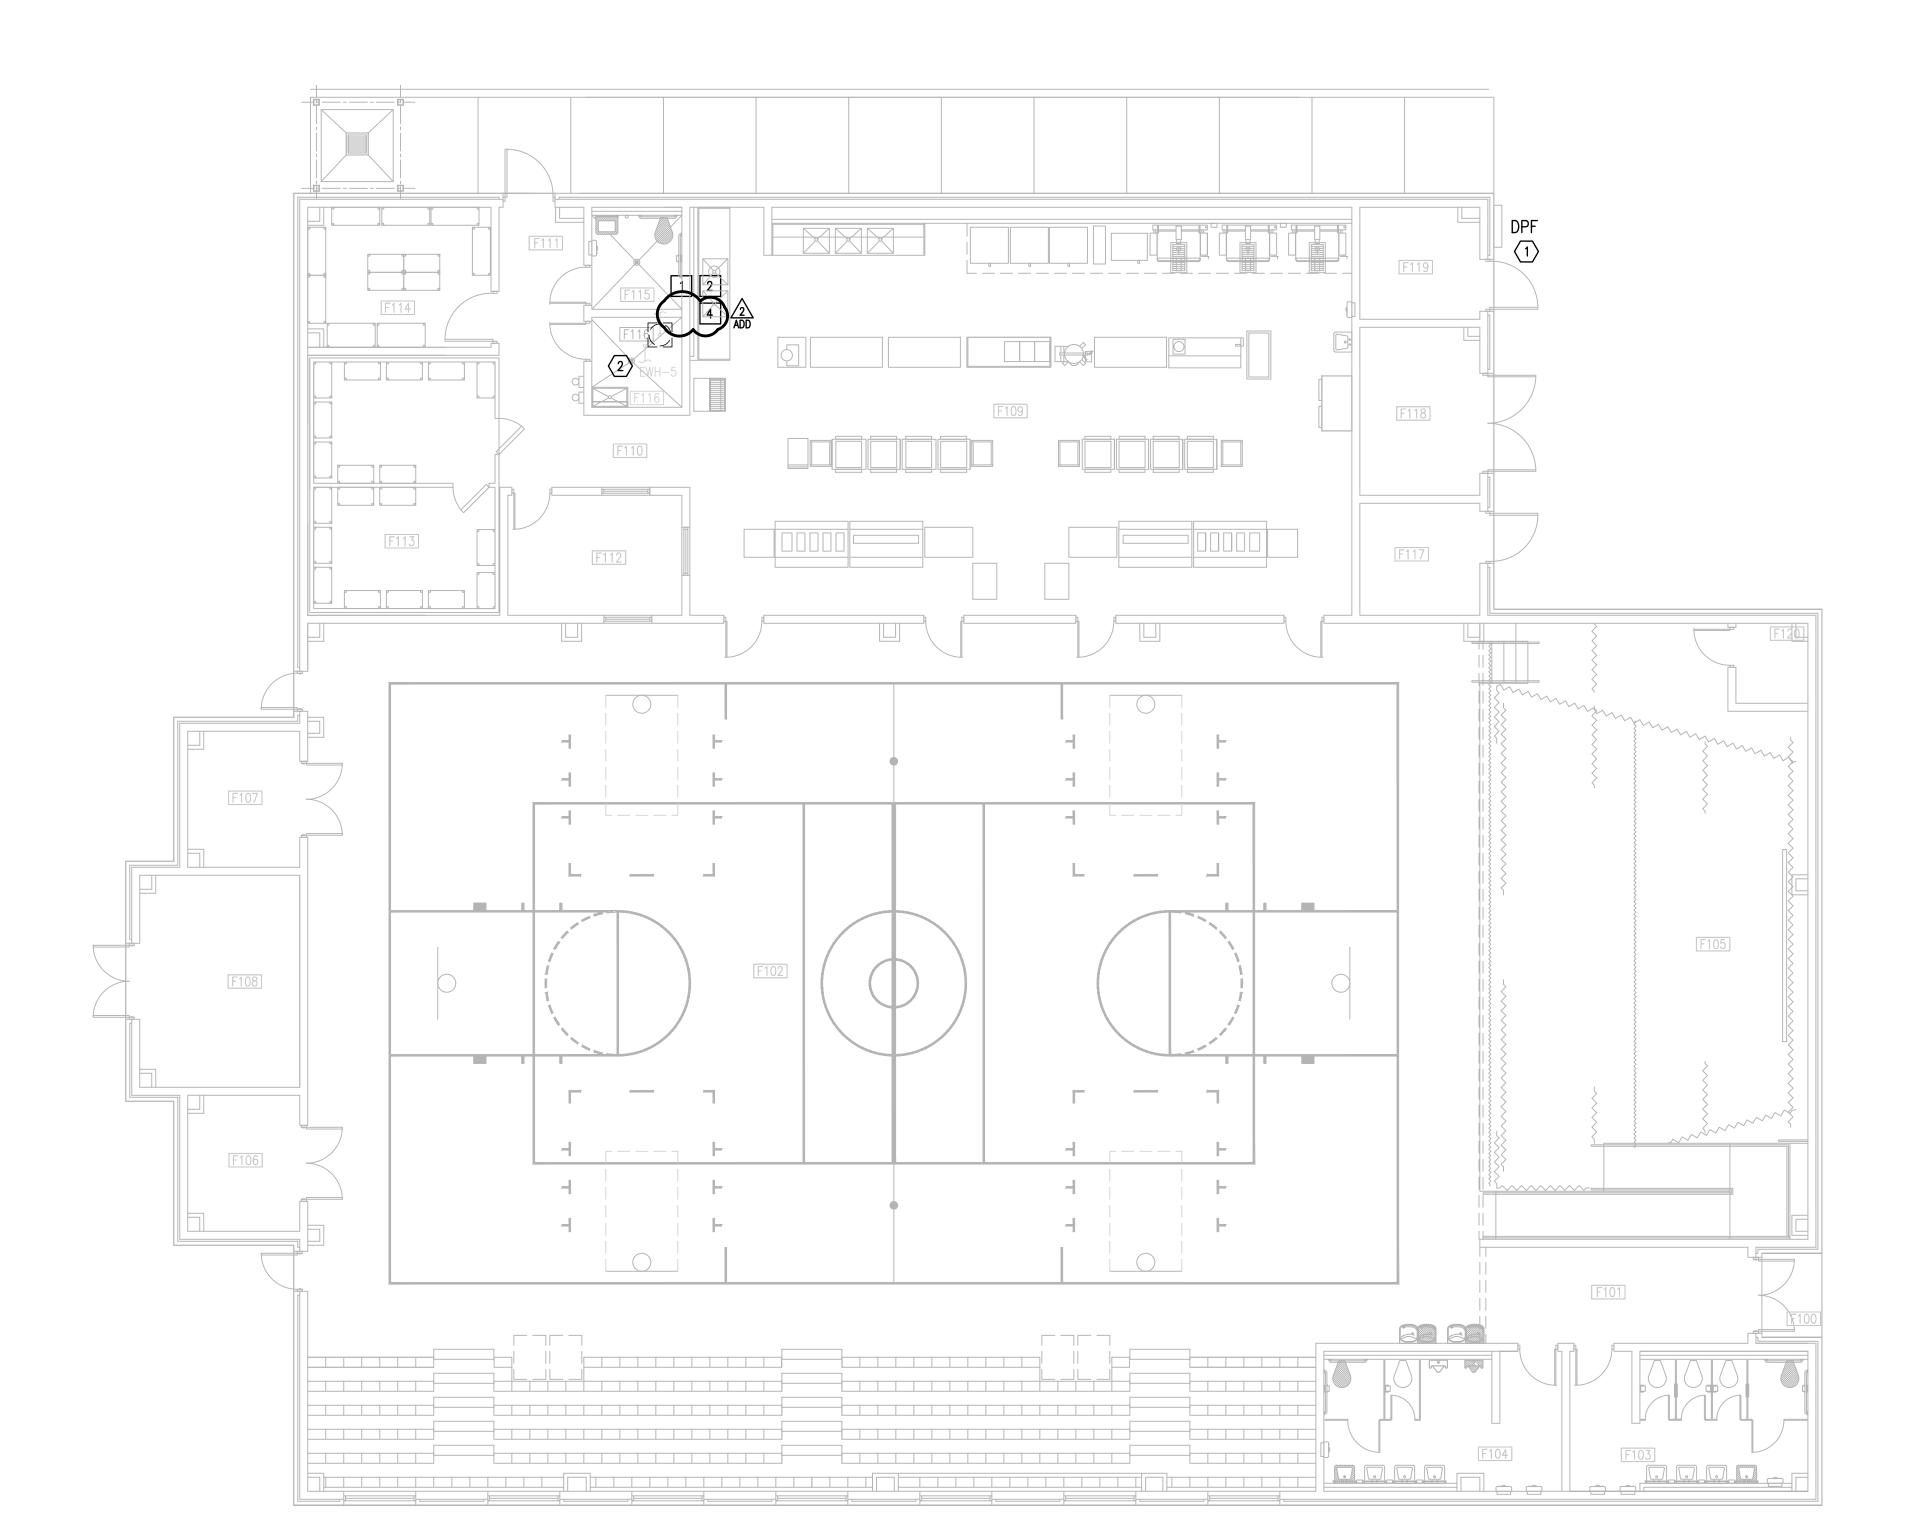
CESAR A. GONZALEZ

04.19.2023

CHECKED BY: DRAWN BY: PROJECT NO.:

P5.06 KEYPLAN

BUILDING "H"



IDEA FRONTIER

01 DEMOLITION ELECTRICAL AND PLUMBING PLAN
SCALE: 1/8" = 1'-0"

(BUILDING F)




DEMOLITION GENERAL NOTES:

- 1. ALL DEMOLITION WORK SHALL BE DONE IN ACCORDANCE WITH ALL APPLICABLE CODES INCLUDING THOSE PUBLISHED BY OSHA.
- 2. THE EXTENT AND REQUIREMENTS OF DEMOLITION WORK IS INDICATED ON THE ARCHITECTURAL DRAWINGS AND BY THE REQUIREMENTS OF THIS SECTION. A VISIT TO THE SITE IS REQUIRED TO PROPERLY BID THE DEMOLITION WORK. ALL INFORMATION SHOWN ON THE EXISTING CONSTRUCTION WILL BE REFERENCE ONLY AND WILL NEED TO BE FIELD VERIFIED BY THE CONTRACTOR.
- 3. PROVIDE ALL DEMOLITION WORK REQUIRED FOR THE REMOVAL OF EXISTING NON REUSED PLUMBING EQUIPMENT AND ASSOCIATED DEVICES. PROVIDE A COMPLETE AND OPERABLE SYSTEM UPON COMPLETION OF THE PROJECT.
- 4. COORDINATE DEMOLITION OF DIVISION 22 SYSTEM AS REQUIRED WITH ALL OTHER TRADES.
- 5. ALL EXISTING EQUIPMENT AND MATERIALS REMOVED DURING CONSTRUCTION, THAT IS NOT TO BE REUSED, SHALL BE REMOVED FROM THE JOB SITE AND PROPERLY RETURNED TO THE OWNER, IF DESIRED BY
- 6. IT IS INTENDED THAT DEMOLITION WORK LEAVE THE ENTIRE AREA FREE OF ABOVE-GRADE ITEMS. INCLUDING PIPING, STRUCTURAL SUPPORTS MATERIALS AND MISCELLANEOUS ITEMS. ALL SUCH ITEMS ARE TO BE REMOVED UNLESS SPECIFICALLY INDICATED OTHERWISE.
- OWNER MAY WISH TO KEEP DEMOLISHED EQUIPMENT AND MATERIALS. COORDINATE WITH OWNER, AND DISPOSE OF EQUIPMENT AND MATERIALS THAT OWNER DOES NOT REMAIN.
- 8. PREPARE AREA FOR INSTALLATION OF NEW PLUMBING SYSTEMS. REFER TO NEW PLANS AND COORDINATE WITH DEMOLITION WORK.


DEMOLITION PLUMBING KEYED NOTES:

- 1 DEMOLISH EXISTING ELECTRIC WATER HEATER AT THIS APPROXIMATE LOCATION.
- 2 ISOLATE AND DISCONNECT EXISTING COLD AND HOT WATER PIPES SERVING PLUMBING FIXTURE AT THIS APPROXIMATE LOCATION. CONNECT AFTER REPLACING.
- 3 NOT USED.
- 4 PREPARE AREA FOR INSTALLATION OF NEW PLUMBING EQUIPMENT. COORDINATE WITH DEMOLITION.

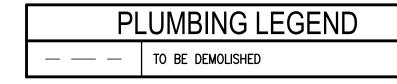

DEMOLITION **ELECTRICAL KEYED NOTES:**

- 1) APPROXIMATE LOCATION OF EXISTING PANELBOARD SERVING ELECTRIC WATER HEATER.
- DISCONNECT EXISTING ELECTRIC WATER HEATER FOR INSTALLATION OF NEW ELECTRIC WATER HEATER. RETAIN AND REUSE EXISTING BRANCH

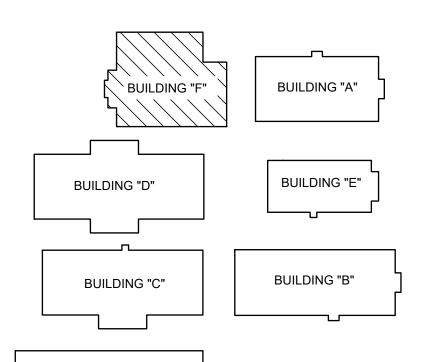

FRONTIER IDEA ACADEMY

BUILDING "G"

PLUMBING KEYED NOTES:

1 REMOVE, STORE AND RE-INSTALL FLOOR SINK GRATE AFTER COMPLETING WORK.

PROVIDE NEW TRAP SEAL FOR EXISTING FLOOR SINK AT THIS APPROXIMATE LOCATION. ENSURE TO PROVIDE APPROPRIATE SIZE TO FIT INTO EXISTING PIPING. REFER TO SCHEDULE ON SHEET P6.05.

NO: REVISION: BY:

ADD 05/02/2024 ETHOS

CSP # 27-LRPU-04

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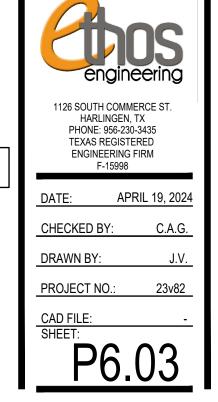
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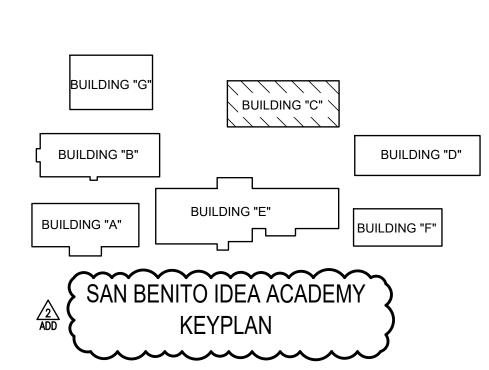
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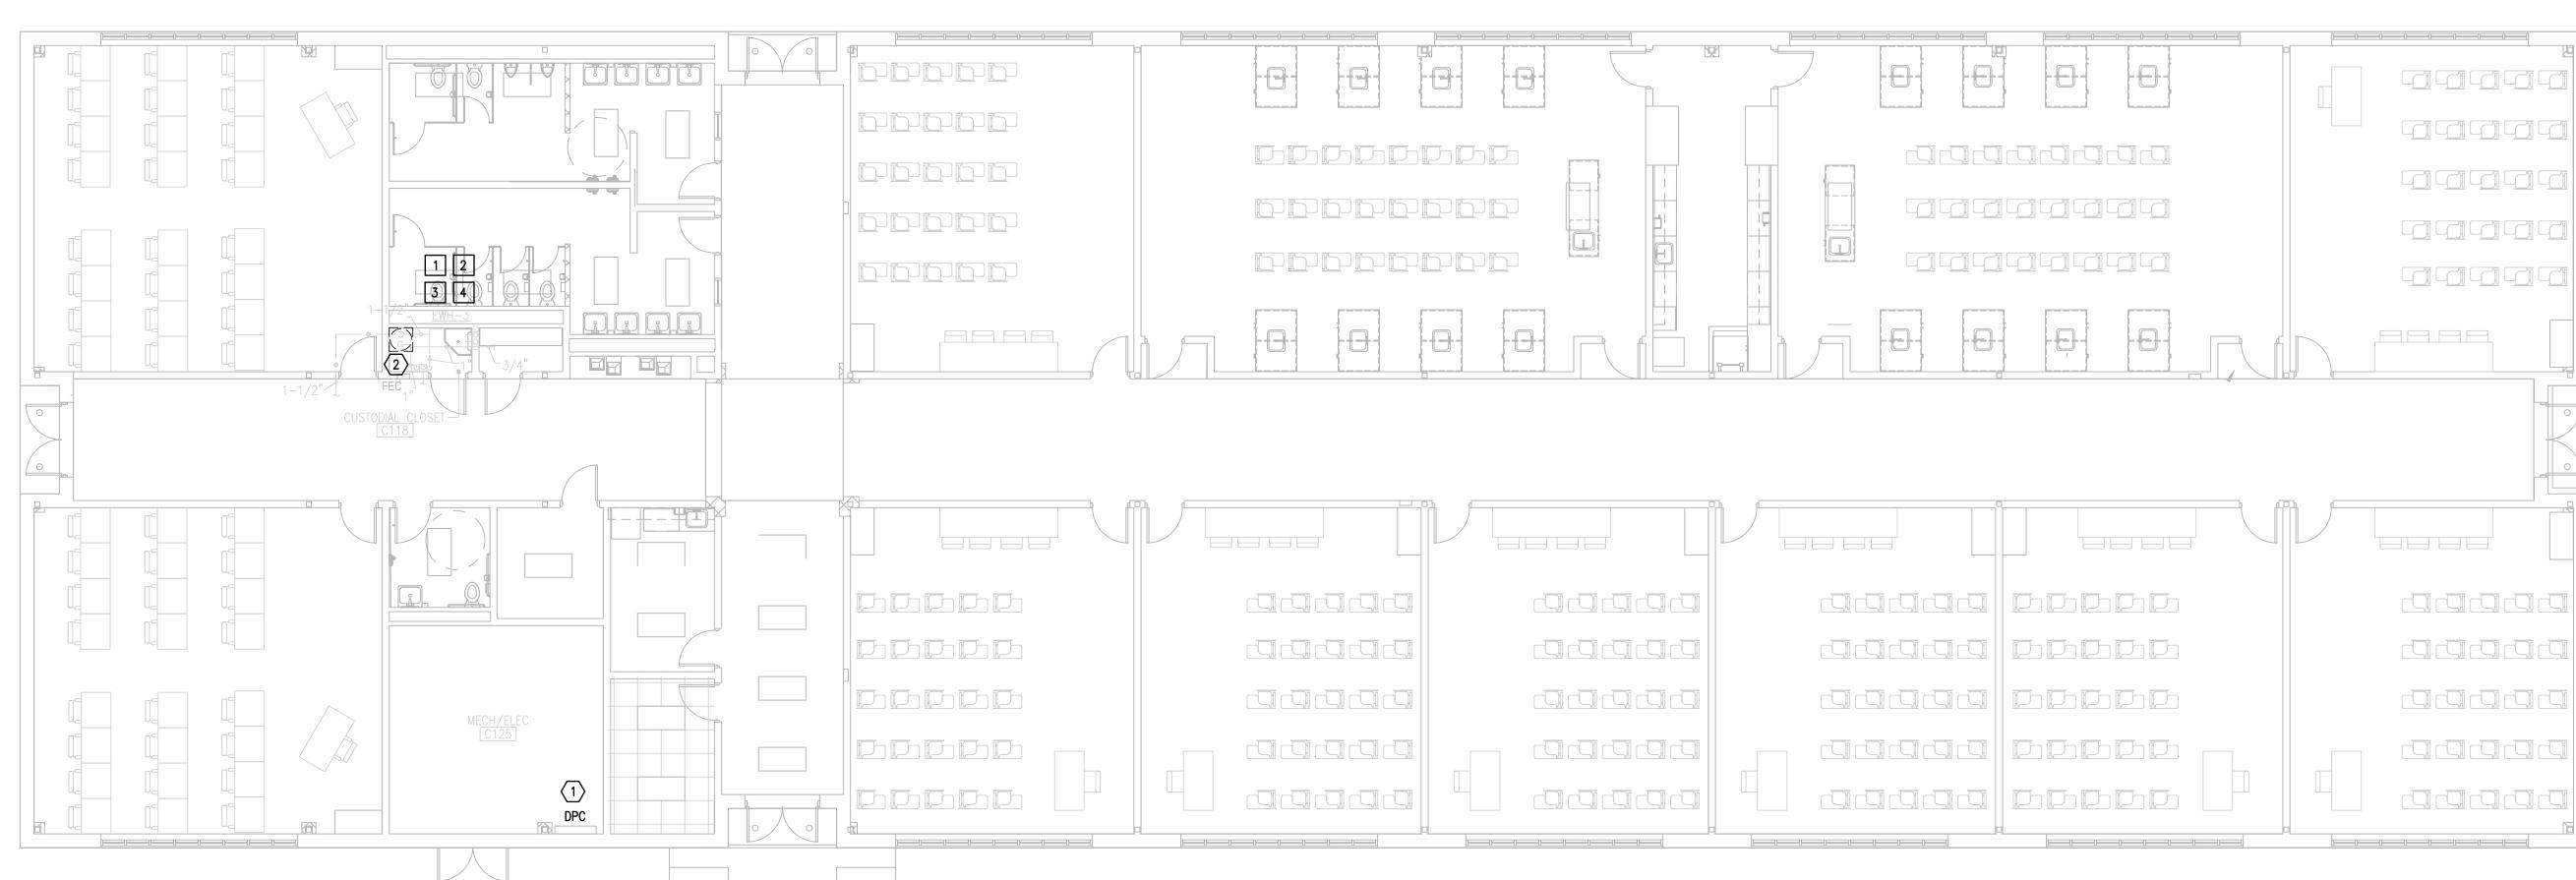
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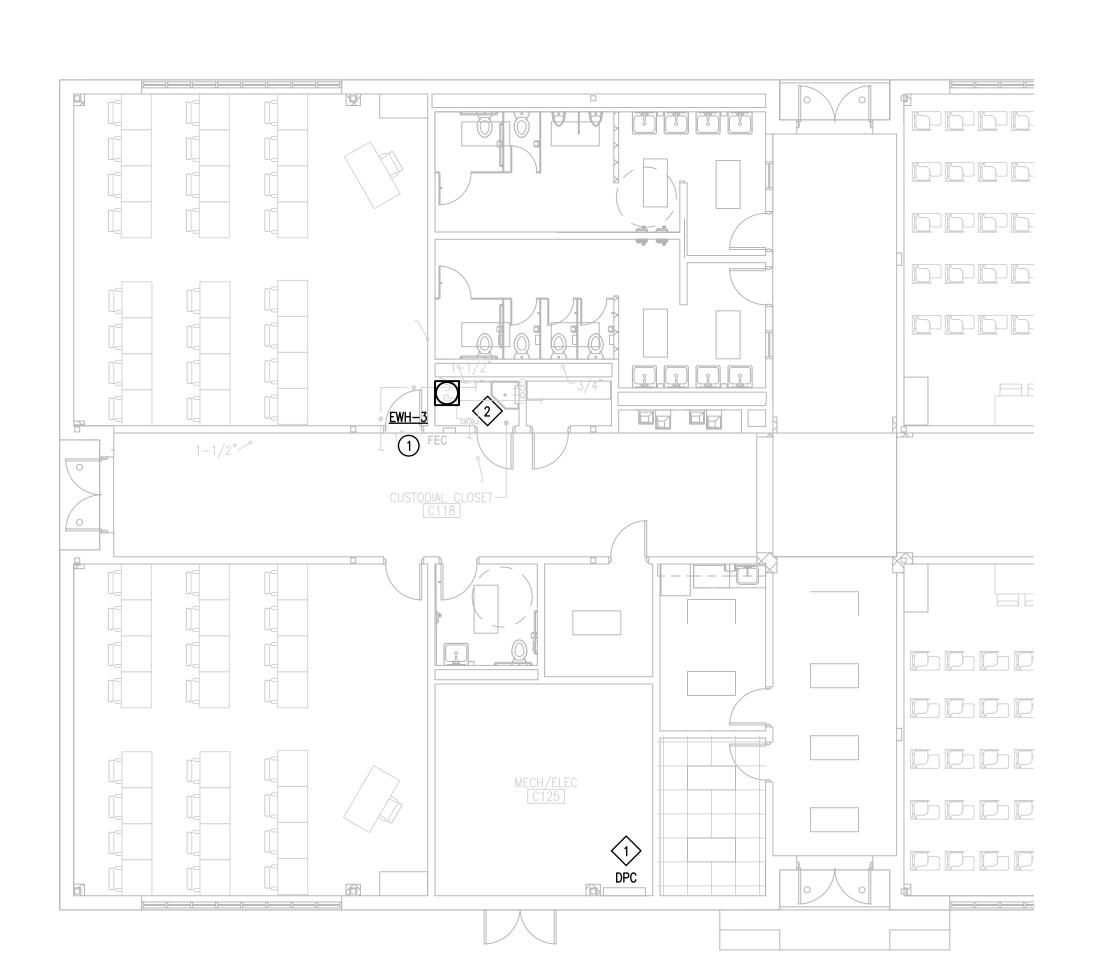
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IDEA SAN BENITO

01 DEMOLITION ELECTRICAL AND PLUMBING PLAN





IDEA SAN BENITO 02 NEW ELECTRICAL AND PLUMBING PLAN





DEMOLITION GENERAL NOTES:

- ALL DEMOLITION WORK SHALL BE DONE IN ACCORDANCE WITH ALL APPLICABLE CODES INCLUDING THOSE PUBLISHED BY OSHA.
- 2. A VISIT TO THE SITE IS REQUIRED TO PROPERLY BID THE DEMOLITION PLUMBING WORK. ALL INFORMATION SHOWN ON THE EXISTING CONSTRUCTION WILL BE REFERENCE ONLY AND WILL NEED TO BE FIELD VERIFIED BY THE CONTRACTOR.
- PROVIDE ALL DEMOLITION WORK REQUIRED FOR THE REMOVAL OF EXISTING NON REUSED PLUMBING EQUIPMENT AND ASSOCIATED DEVICES. PROVIDE A COMPLETE AND OPERABLE SYSTEM UPON COMPLETION OF THE PROJECT.
- COORDINATE DEMOLITION OF DIVISION 22 SYSTEM AS REQUIRED WITH ALL OTHER TRADES.
- ALL EXISTING EQUIPMENT AND MATERIALS REMOVED DURING CONSTRUCTION, THAT IS NOT TO BE REUSED, SHALL BE REMOVED FROM THE JOB SITE AND PROPERLY RETURNED TO THE OWNER, IF DESIRED BY
- COORDINATE WITH OWNER, AND DISPOSE OF EQUIPMENT AND MATERIALS THAT OWNER DOES NOT REMAIN.
- PREPARE AREA FOR INSTALLATION OF NEW PLUMBING SYSTEMS. REFER TO NEW PLANS AND COORDINATE WITH DEMOLITION WORK.
- PLUMBING CONTRACTOR SHALL ISOLATE DOMESTIC COLD AND HOT WATER SYSTEM AT THE WORKING AREAS PRIOR ANY WORK BEING DONE.

GENERAL NOTES:

- PLUMBING CONTRACTOR SHALL ISOLATE DOMESTIC COLD WATER SYSTEM AT THE WORKING AREAS PRIOR ANY WORK BEING DONE.
- 2. PLUMBING CONTRACTOR SHALL PERFORM ALL WORK CAREFULLY TO NOT DAMAGE BUILDING FACADE/STRUCTURE.

DEMOLITION PLUMBING KEYED NOTES:

- 1 DEMOLISH EXISTING ELECTRIC WATER HEATER AT THIS APPROXIMATE LOCATION.
- 2 ISOLATE AND DISCONNECT EXISTING COLD AND HOT WATER PIPES SERVING PLUMBING FIXTURE AT THIS APPROXIMATE LOCATION. CONNECT AFTER REPLACING.
- 3 DEMOLISH EXISTING PLUMBING FIXTURES MARKED ON PLANS.
- 4 PREPARE AREA FOR INSTALLATION OF NEW PLUMBING FIXTURES. COORDINATE WITH DEMOLITION.

PLUMBING KEYED NOTES:

1) PROVIDE AND INSTALL NEW ELECTRIC WATER HEATER EWH-3 AS SCHEDULED OR AN APPROVED EQUAL. REFER TO P6.05. ADJUST PLUMBING LINES AND FITTINGS AS NECESSARY TO RECEIVE NEW WATER HEATER. REFER TO DETAIL ON DETAIL SHEET P6.05.



DEMOLITION ELECTRICAL KEYED NOTES:

- 1 APPROXIMATE LOCATION OF EXISTING PANELBOARD SERVING ELECTRIC WATER HEATER.
- DISCONNECT EXISTING ELECTRIC WATER HEATER FOR INSTALLATION OF NEW ELECTRIC WATER HEATER. RETAIN AND REUSE EXISTING BRANCH

ELECTRICAL NEW KEYED NOTES:

- 1) APPROXIMATE LOCATION OF EXISTING PANELBOARD SERVING ELECTRIC ✓ WATER HEATER.
- 2 CONNECT NEW ELECTRIC WATER HEATER. RETAIN AND REUSE EXISTING BRANCH CIRCUIT. IF EXISTING BRANCH CIRCUIT DOES NOT REACH NEW POINT OF CONNECTION PROVIDE A J-BOX AND EXTEND WIRING AS NECESSARY.

