

1126 South Commerce St. Harlingen, TX 78550 Off: (956) 230-3435 Fax: (956) 720-0830 www.ethoseng.net



April 29, 2024

IDEA PS - Plumbing Upgrades at Lower RGV Campuses CSP#27-LRPU-0424

ADDENDUM NO. 1

A. PURPOSE AND INTENT

This addendum is issued for the purpose of modifying the plans for the project referenced above. This addendum shall become part of the contract and all contractors shall be bound by its content. All aspects of the specifications and drawings not covered herein shall remain the same. The General Conditions and the Special Conditions of the specifications shall govern all parts of the work and apply in full force to this addendum.

B. SCOPE

I. Drawings

- 1. Sheet P3.01 See attached.
 - a) Revised Plumbing Schedules.
- 2. Sheet P4.03 see attached.
 - a) Revised plumbing schedules.
- 3. Sheet P5.01 See attached.
 - a) Revised Plumbing Keyed notes.
- 4. Sheet P5.02 See attached.
 - a) Revised Plumbing Keyed notes.
 - b) Revised Condensate Drain Trap Pipe Detail.
- 5. Sheet P5.03 See attached.
 - a) Revised Plumbing Keyed notes.
 - b) Revised Condensate Drain Trap Pipe Detail.
- 6. Sheet P5.04 See attached.
 - a) Revised Plumbing Keyed notes.
 - b) Revised Condensate Drain Trap Pipe Detail.
- 7. Sheet P5.07 See attached.
 - a) Revised Plumbing Keyed notes.
- 8. Sheet P5.11 See attached.
 - a) Revised Plumbing Schedules.
 - b) Revised Plumbing Details.

ADDENDUM NO. 1 1 | Page

- 9. Sheet P6.01 See attached.
 - a) Revised Plumbing Keyed notes.
- 10. Sheet P6.02 See attached.
 - a) Revised Plumbing Keyed notes.
- 11. Sheet P6.04 See attached.
 - a) Revised Plumbing Keyed notes.
- 12. Sheet P6.05- See attached.
 - a) Revised Plumbing Schedules.
 - b) Revised Plumbing Details.
- 13. Sheet P7.03 See attached.
 - a) Revised Plumbing Keyed notes.
- 14. Sheet P7.04 See attached.
 - a) Revised Plumbing Keyed notes.
- 15. Sheet P7.05 See attached.
 - a) Revised Plumbing Schedules.
 - b) Revised Plumbing Details.



04/29/2024

ADDENDUM NO. 1 2 | Page

PHONE: 956 TEXAS REG ENGINEERI	HARLINGEN, TX PHONE: 956-230-3435 TEXAS REGISTERED ENGINEERING FIRM F-15998						
DATE:	APRIL 19, 2024						
CHECKED BY:	C.A.G.						
DRAWN BY:	J.V.						
PROJECT NO.:	23v82						
CAD FILE:							
P3	.01						



WH-2



	SING TIXTORE GOIT	LDOLL						
Project: IDE	A PS PLUMBING UPGRADES AT	LOWER RGV CAMPUSES						
	MANUFACTURER &			CO	NNECTIC	NS		
MARK	MODEL NUMBER	DESCRIPTION	WASTE	VENT	CW	HW	NOTES	REMARKS
	ZURN	REPLACEMENT PART P1300 #1-3/4 WALLL						
WH-1	P1300-#1-3/4	HYDRANT BRONZE HEAD AND REPAIR KIT.	-	-	3/4"	-	-	
	HYD-RK-Z1300-10							
	ZURN	WALL HYDRANT ASSEMBLY WITHOUT BOX AND						
WH-2	# 013500019	REPAIR KIT	-	=	3/4"	-	-	
	HYD-RK-Z1350							

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HARLIN PHONE: 95 TEXAS RE ENGINEER	OMMERCE ST. GEN, TX 6-230-3435 GISTERED RING FIRM 5998
ATE:	APRIL 19, 2024
HECKED BY	C.A.G.

HARLINGEN, TX PHONE: 956-230-3435 TEXAS REGISTERED ENGINEERING FIRM F-15998					
DATE:	APRIL 19, 2024				
CHECKED BY	: C.A.G.				
DRAWN BY:	J.V.				
PROJECT NO	.: 23v82				
CAD FILE: SHEET:	1.03				









REPAIR KIT

DESCRIPTION

WALL HYDRANT ASSEMBLY WITHOUT BOX AND

REPLACEMENT PART P1300 #1-3/4 WALLL

HYDRANT BRONZE HEAD AND REPAIR KIT.

CONNECTIONS

WASTE VENT CW HW NOTES

3/4"

3/4"

REMARKS

PLUMBING FIXTURE SCHEDULE

MANUFACTURER &

MODEL NUMBER

ZURN

P1300-#1-3/4 HYD-RK-Z1300-10

ZURN

013500019 HYD-RK-Z1350

MARK

WH-1

WH-2

Project: IDEA PS PLUMBING UPGRADES AT LOWER RGV CAMPUSES

NO: REVISION: BY:

CESAR A. GONZALEZ

O

CHECKED BY: DRAWN BY: PROJECT NO.:

P5.01

GENERAL NOTES: 1. PLUMBING CONTRACTOR SHALL ISOLATE DOMESTIC COLD WATER SYSTEM AT THE WORKING AREAS PRIOR ANY WORK BEING DONE. 2. FOR ALL WALL HYDRANTS BEING REPLACED, CONTRACTOR SHALL RETAIN EXISTING BOX/ENCLOSURE AND SHALL REPLACE ALL INTERNAL COMPONENTS. IT WILL BE CONTRACTOR RESPONSIBILITY TO PROVIDE AN EQUAL/SIMILAR HYDRANT TO FIT INTO EXISTING BOX/ENCLOSURE. 3. PLUMBING CONTRACTOR SHALL PERFORM ALL WORK CAREFULLY TO NOT DAMAGE BUILDING FACADE/STRUCTURE.

DEMOLITION ELECTRICAL KEYED NOTES:

- APPROXIMATE LOCATION OF EXISTING PANELBOARD SERVING ELECTRIC WATER HEATER.
- 2) DISCONNECT EXISTING ELECTRIC WATER HEATER FOR INSTALLATION OF NEW

ELECTRICAL NEW KEYED NOTES:

- APPROXIMATE LOCATION OF EXISTING PANELBOARD SERVING ELECTRIC WATER
- 2 CONNECT NEW ELECTRIC WATER HEATER. RETAIN AND REUSE EXISTING BRANCH CIRCUIT. IF EXISTING BRANCH CIRCUIT DOES NOT REACH NEW POINT OF CONNECTION PROVIDE A J-BOX AND EXTEND WIRING AS NECESSARY.

- ELECTRIC WATER HEATER. RETAIN AND REUSE EXISTING BRANCH CIRCUIT.

DEMOLITION GENERAL NOTES:

- 1. ALL DEMOLITION WORK SHALL BE DONE IN ACCORDANCE WITH ALL APPLICABLE CODES INCLUDING THOSE PUBLISHED BY OSHA.
- 2. A VISIT TO THE SITE IS REQUIRED TO PROPERLY BID THE DEMOLITION PLUMBING WORK. ALL INFORMATION SHOWN ON THE EXISTING CONSTRUCTION WILL BE REFERENCE ONLY AND WILL NEED TO BE FIELD VERIFIED BY THE CONTRACTOR.
- 3. PROVIDE ALL DEMOLITION WORK REQUIRED FOR THE REMOVAL OF EXISTING NON REUSED PLUMBING EQUIPMENT AND ASSOCIATED DEVICES. PROVIDE A COMPLETE AND OPERABLE SYSTEM UPON COMPLETION OF THE PROJECT.
- 4. COORDINATE DEMOLITION OF DIVISION 22 SYSTEM AS REQUIRED WITH ALL OTHER TRADES.
- 5. ALL EXISTING EQUIPMENT AND MATERIALS REMOVED DURING CONSTRUCTION, THAT IS NOT TO BE REUSED, SHALL BE REMOVED FROM THE JOB SITE AND PROPERLY RETURNED TO THE OWNER, IF DESIRED BY
- COORDINATE WITH OWNER, AND DISPOSE OF EQUIPMENT AND MATERIALS THAT OWNER DOES NOT REMAIN.
- PREPARE AREA FOR INSTALLATION OF NEW PLUMBING SYSTEMS. REFER TO NEW PLANS AND COORDINATE WITH DEMOLITION WORK.

DEMOLITION PLUMBING KEYED NOTES:

- 1 DEMOLISH EXISTING ELECTRIC WATER HEATER AT THIS APPROXIMATE LOCATION.
- 2 DEMOLISH EXISTING DRINKING FOUNTAINS AT THIS APPROXIMATE LOCATION.
- 3 ISOLATE AND DISCONNECT EXISTING COLD AND HOT WATER PIPES SERVING PLUMBING FIXTURE AT THIS APPROXIMATE LOCATION. CONNECT AFTER REPLACING.
- 4 DEMOLISH EXISTING PLUMBING FIXTURES MARKED ON PLANS.
- 5 PREPARE AREA FOR INSTALLATION OF NEW PLUMBING FIXTURES. COORDINATE WITH DEMOLITION.


PLUMBING KEYED NOTES:


- 1 REMOVE AND REPLACE WALL HYDRANT AT THIS APPROXIMATE LOCATION. SEE SCHEDULE ON SHEET P5.11. 2) PROVIDE AND INSTALL NEW ELECTRIC WATER HEATER EWH-1 AS
- SCHEDULED OR AN APPROVED EQUAL. REFER TO P5.11. ADJUST PLUMBING LINES AND FITTINGS AS NECESSARY TO RECEIVE NEW WATER HEATER. REFER TO DETAIL ON DETAIL SHEET P5.11. 3 PROVIDE NEW DRINKING FOUNTAINS EDF-1&2 WITH NEW ONES
- P5.11. ADJUST PLUMBING LINES AND FITTINGS TO THE NEW PLUMBING FIXTURE AS NECESSARY AND REPAIR WALL TO MATCH EXISTING CONDITIONS IF NECESSARY.

INDICATED ON THE SCHEDULES OR AN APPROVED EQUAL. REFER TO

4 APPROXIMATE LOCATION OF EXISTING ISOLATION VALVE. FIELD VERIFY EXACT LOCATION.

EXACT LOCATION.					
PLUMBING LEGEND					
— — TO BE DEMOLISHED					
○	WALL HYDRANT TO BE REPLACED				

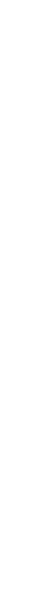

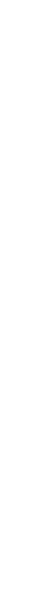



FRONTIER IDEA ACADEMY **KEYPLAN**

BUILDING "A"

BUILDING "H"



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01 DEMOLITION ELECTRICAL AND PLUMBING PLAN

F.E.C.

IDEA FRONTIER

SCALE :3/32" = 1'-0"

1LA

NORTH

(BUILDING A)

NO: REVISION: BY

F-15998 APRIL 19, 202

CHECKED BY: C.A.G. DRAWN BY: PROJECT NO.:

P5.02

DEMOLITION ELECTRICAL KEYED NOTES:

1) APPROXIMATE LOCATION OF EXISTING PANELBOARD SERVING ELECTRIC WATER HEATER.

2) DISCONNECT EXISTING ELECTRIC WATER HEATER FOR INSTALLATION OF NEW ELECTRIC WATER HEATER. RETAIN AND REUSE EXISTING BRANCH CIRCUIT.


ELECTRICAL NEW KEYED NOTES:

- APPROXIMATE LOCATION OF EXISTING PANELBOARD SERVING ELECTRIC WATER
- 2 CONNECT NEW ELECTRIC WATER HEATER. RETAIN AND REUSE EXISTING BRANCH CIRCUIT. IF EXISTING BRANCH CIRCUIT DOES NOT REACH NEW POINT OF CONNECTION PROVIDE A J-BOX AND EXTEND WIRING AS NECESSARY.

PL	PLUMBING LEGEND				
	TO BE DEMOLISHED				
o 	WALL HYDRANT TO BE REPLACED				



IDEA FRONTIER EXISTING CONDITIONS (BUILDING B - MEZZANINE)

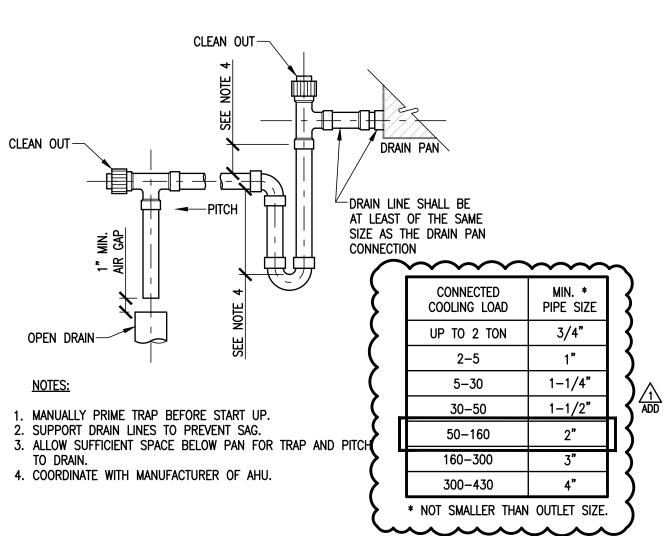

IDEA FRONTIER 02 NEW ELECTRICAL AND PLUMBING PLAN

IDEA FRONTIER

01 DEMOLITION ELECTRICAL AND PLUMBING PLAN

REFER TO 03 EXISTING CONDITIONS

1)LB

(BUILDING B)

NORTH

ON THESE SAME SHEET.

REFER TO DETAIL 04 CONDENSATE DRAIN


TRAP PIPE ON THESE SAME SHEET.

<u>AHU-2</u>

(IN MEZZANINE)

(BUILDING B) NORTH

EXISTING CONDENSATE PIPING TO BE REMOVED AND REPLACED

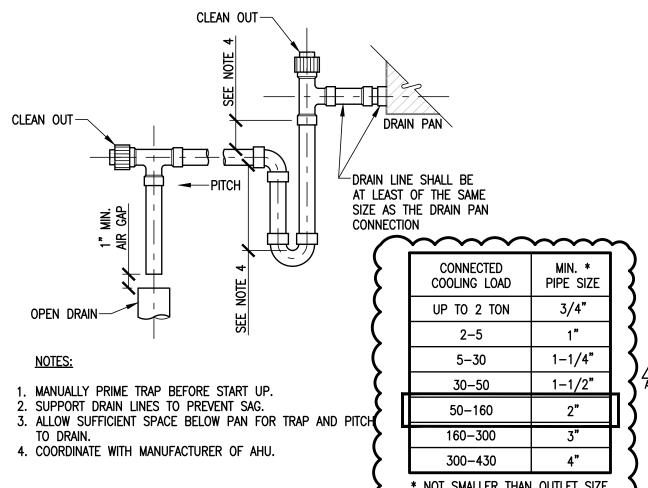

CONDENSATE DRAIN

TRAP PIPE

PLUMBING WORK. ALL INFORMATION SHOWN ON THE EXISTING CONSTRUCTION WILL BE REFERENCE ONLY AND WILL NEED TO BE FIELD VERIFIED BY THE CONTRACTOR.

APPLICABLE CODES INCLUDING THOSE PUBLISHED BY OSHA.

1. ALL DEMOLITION WORK SHALL BE DONE IN ACCORDANCE WITH ALL

2. A VISIT TO THE SITE IS REQUIRED TO PROPERLY BID THE DEMOLITION

PROVIDE ALL DEMOLITION WORK REQUIRED FOR THE REMOVAL OF EXISTING NON REUSED PLUMBING EQUIPMENT AND ASSOCIATED DEVICES. PROVIDE A COMPLETE AND OPERABLE SYSTEM UPON COMPLETION OF THE PROJECT.

4. COORDINATE DEMOLITION OF DIVISION 22 SYSTEM AS REQUIRED WITH ALL OTHER TRADES.

5. ALL EXISTING EQUIPMENT AND MATERIALS REMOVED DURING CONSTRUCTION, THAT IS NOT TO BE REUSED, SHALL BE REMOVED FROM THE JOB SITE AND PROPERLY RETURNED TO THE OWNER, IF DESIRED BY

6. COORDINATE WITH OWNER, AND DISPOSE OF EQUIPMENT AND MATERIALS THAT OWNER DOES NOT REMAIN.

PREPARE AREA FOR INSTALLATION OF NEW PLUMBING SYSTEMS. REFER TO NEW PLANS AND COORDINATE WITH DEMOLITION WORK.

GENERAL NOTES:

- PLUMBING CONTRACTOR SHALL ISOLATE DOMESTIC COLD WATER SYSTEM AT THE WORKING AREAS PRIOR ANY WORK BEING DONE.
- 2. FOR ALL WALL HYDRANTS BEING REPLACED, CONTRACTOR SHALL RETAIN EXISTING BOX/ENCLOSURE AND SHALL REPLACE ALL INTERNAL COMPONENTS. IT WILL BE CONTRACTOR RESPONSIBILITY TO PROVIDE AN EQUAL/SIMILAR HYDRANT TO FIT INTO EXISTING BOX/ENCLOSURE.
- PLUMBING CONTRACTOR SHALL PERFORM ALL WORK CAREFULLY TO NOT DAMAGE BUILDING FACADE/STRUCTURE.

DEMOLITION PLUMBING KEYED NOTES:

- 1 DEMOLISH EXISTING ELECTRIC WATER HEATER AT THIS APPROXIMATE LOCATION.
- 2 DEMOLISH EXISTING CONDENSATE PIPING SERVING HVAC EQUIPMENT AT THIS APPROXIMATE LOCATION.
- 3 ISOLATE AND DISCONNECT EXISTING COLD AND HOT WATER PIPES SERVING PLUMBING FIXTURE AT THIS APPROXIMATE LOCATION. CONNECT AFTER REPLACING.
- 4 DEMOLISH EXISTING PLUMBING FIXTURES MARKED ON PLANS.
- 5 PREPARE AREA FOR INSTALLATION OF NEW PLUMBING FIXTURES. COORDINATE WITH DEMOLITION.

PLUMBING KEYED NOTES:

1) REMOVE AND REPLACE WALL HYDRANT AT THIS APPROXIMATE LOCATION. SEE SCHEDULE ON SHEET P5.11. 2) PROVIDE AND INSTALL NEW ELECTRIC WATER HEATER EWH-2 AS

SCHEDULED OR AN APPROVED EQUAL. REFER TO P5.11. ADJUST PLUMBING LINES AND FITTINGS AS NECESSARY TO RECEIVE NEW WATER HEATER. REFER TO DETAIL ON DETAIL SHEET P5.11.

(3) PROVIDE NEW 2" SOFT COPPER PIPING FOR CONDENSATE DRAIN LINE OF EXISTING AIR CONDITIONING UNIT AT THIS APPROXIMATE LOCATION. PROVIDE 1" THICK FLEXIBLE ELECTROMETRIC INSULATION FOR NEW CONDENSATE PIPING AND CONNECT INTO EXISTING HUB DRAIN. NEW CONDENSATE PIPE SHALL BE SIZED AS PER AIR CONDITIONING UNIT MANUFACTURER RECOMMENDATIONS, ENSURE TO NOT PROVIDE A SMALLER PIPE SIZE THAN EXISTING.

(4) APPROXIMATE LOCATION OF EXISTING ISOLATION VALVE. FIELD VERIFY EXACT LOCATION.


> FRONTIER IDEA ACADEMY KEYPLAN

BUILDING "F"

BUILDING "D"

BUILDING "C"

BUILDING "G"

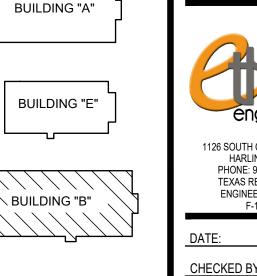

BUILDING "H"



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N N

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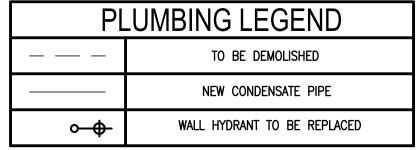
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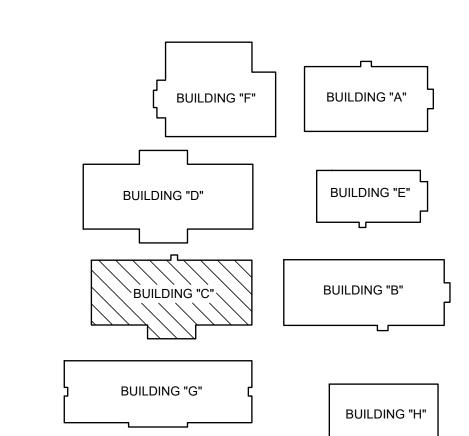
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PLUMBING KEYED NOTES:

1) REMOVE AND REPLACE WALL HYDRANT AT THIS APPROXIMATE 2) PROVIDE AND INSTALL NEW ELECTRIC WATER HEATER EWH-3 AS SCHEDULED OR AN APPROVED EQUAL. REFER TO P5.11. ADJUST PLUMBING LINES AND FITTINGS AS NECESSARY TO RECEIVE NEW WATER HEATER. REFER TO DETAIL ON DETAIL SHEET P5.11.

(3) PROVIDE NEW 1-1/2" SOFT COPPER PIPING FOR CONDENSATE DRAIN LINE OF EXISTING AIR CONDITIONING UNIT AT THIS APPROXIMATE LOCATION. PROVIDE 1" THICK FLEXIBLE ELECTROMETRIC INSULATION FOR NEW CONDENSATE PIPING AND CONNECT INTO EXISTING HUB DRAIN. NEW CONDENSATE PIPE SHALL BE SIZED AS PER AIR CONDITIONING UNIT MANUFACTURER RECOMMENDATIONS, ENSURE TO NOT PROVIDE A SMALLER PIPE SIZE THAN EXISTING.





FRONTIER IDEA ACADEMY **KEYPLAN**

GENERAL NOTES:

1. PLUMBING CONTRACTOR SHALL ISOLATE DOMESTIC COLD WATER SYSTEM AT THE WORKING AREAS PRIOR ANY WORK BEING DONE.

2. FOR ALL WALL HYDRANTS BEING REPLACED, CONTRACTOR SHALL RETAIN EXISTING BOX/ENCLOSURE AND SHALL REPLACE ALL INTERNAL COMPONENTS. IT WILL BE CONTRACTOR RESPONSIBILITY TO PROVIDE AN EQUAL/SIMILAR HYDRANT TO FIT INTO EXISTING BOX/ENCLOSURE.

3. PLUMBING CONTRACTOR SHALL PERFORM ALL WORK CAREFULLY TO NOT DAMAGE BUILDING FACADE/STRUCTURE.

DEMOLITION ELECTRICAL KEYED NOTES:

1 APPROXIMATE LOCATION OF EXISTING PANELBOARD SERVING ELECTRIC WATER

DISCONNECT EXISTING ELECTRIC WATER HEATER FOR INSTALLATION OF NEW ELECTRIC WATER HEATER. RETAIN AND REUSE EXISTING BRANCH CIRCUIT.

ELECTRICAL NEW KEYED NOTES:


APPROXIMATE LOCATION OF EXISTING PANELBOARD SERVING ELECTRIC WATER

CONNECT NEW ELECTRIC WATER HEATER. RETAIN AND REUSE EXISTING BRANCH CIRCUIT. IF EXISTING BRANCH CIRCUIT DOES NOT REACH NEW POINT OF CONNECTION PROVIDE A J-BOX AND EXTEND WIRING AS NECESSARY.



IDEA FRONTIER 03 EXISTING CONDITIONS AHU-3&4

(BUILDING C - MEZZANINE)

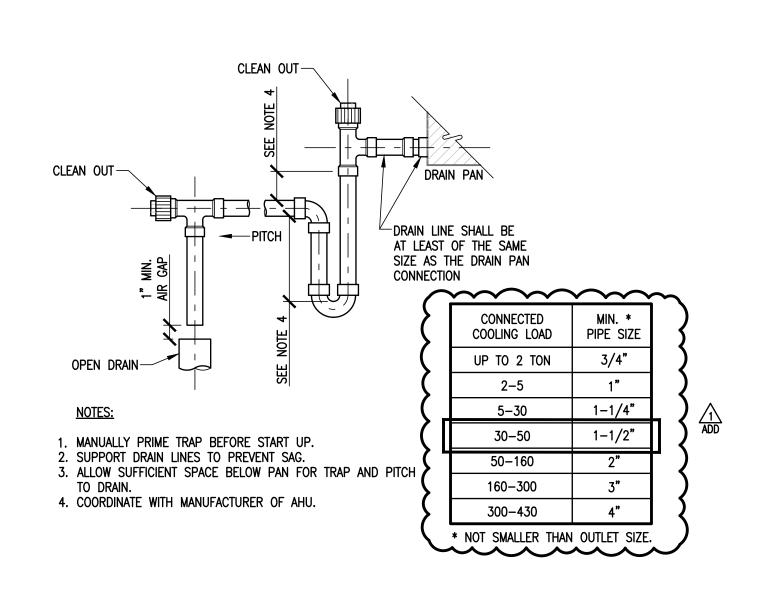

CONDENSATE DRAIN

TRAP PIPE

(E)BV (E)BV REFER TO 04 CONDENSATE DRAIN TRAP <u>ahu-3</u> (in mezzanine) REFER TO 04 CONDENSATE DRAIN TRAP PIPE ON THESE SAME SHEET. PIPE ON THESE SAME SHEET.

(BUILDING C)

NORTH

REFER TO 03 EXISTING CONDITIONS

ON THESE SAME SHEET.

REFER TO 03 EXISTING CONDITIONS

ON THESE SAME SHEET.

IDEA FRONTIER

IDEA FRONTIER

01 DEMOLITION ELECTRICAL AND PLUMBING PLAN

02 NEW ELECTRICAL AND PLUMBING PLAN

(BUILDING C)



APPLICABLE CODES INCLUDING THOSE PUBLISHED BY OSHA. 2. A VISIT TO THE SITE IS REQUIRED TO PROPERLY BID THE DEMOLITION PLUMBING WORK. ALL INFORMATION SHOWN ON THE EXISTING

OTHER TRADES.

CONSTRUCTION WILL BE REFERENCE ONLY AND WILL NEED TO BE FIELD VERIFIED BY THE CONTRACTOR. PROVIDE ALL DEMOLITION WORK REQUIRED FOR THE REMOVAL OF EXISTING NON REUSED PLUMBING EQUIPMENT AND ASSOCIATED DEVICES. PROVIDE A COMPLETE AND OPERABLE SYSTEM UPON COMPLETION OF

THE PROJECT. 4. COORDINATE DEMOLITION OF DIVISION 22 SYSTEM AS REQUIRED WITH ALL

5. ALL EXISTING EQUIPMENT AND MATERIALS REMOVED DURING CONSTRUCTION, THAT IS NOT TO BE REUSED, SHALL BE REMOVED FROM THE JOB SITE AND PROPERLY RETURNED TO THE OWNER, IF DESIRED BY

COORDINATE WITH OWNER, AND DISPOSE OF EQUIPMENT AND MATERIALS THAT OWNER DOES NOT REMAIN.

PREPARE AREA FOR INSTALLATION OF NEW PLUMBING SYSTEMS. REFER TO NEW PLANS AND COORDINATE WITH DEMOLITION WORK.

DEMOLITION PLUMBING KEYED NOTES:

1 DEMOLISH EXISTING ELECTRIC WATER HEATER AT THIS APPROXIMATE

2 DEMOLISH EXISTING CONDENSATE PIPING THAT WILL NO LONGER BE USED AT THIS APPROXIMATE LOCATION NEAR THE 2" HUB DRAIN ON


3 ISOLATE AND DISCONNECT EXISTING COLD AND HOT WATER PIPES SERVING PLUMBING FIXTURE AT THIS APPROXIMATE LOCATION. CONNECT AFTER REPLACING.

4 DEMOLISH EXISTING PLUMBING FIXTURES MARKED ON PLANS.

5 PREPARE AREA FOR INSTALLATION OF NEW PLUMBING FIXTURES. COORDINATE WITH DEMOLITION.

(4) APPROXIMATE LOCATION OF EXISTING ISOLATION VALVE. FIELD VERIFY

PLUMBING LEGEND						
	TO BE DEMOLISHED					
	NEW CONDENSATE PIPE					
○	WALL HYDRANT TO BE REPLACED					

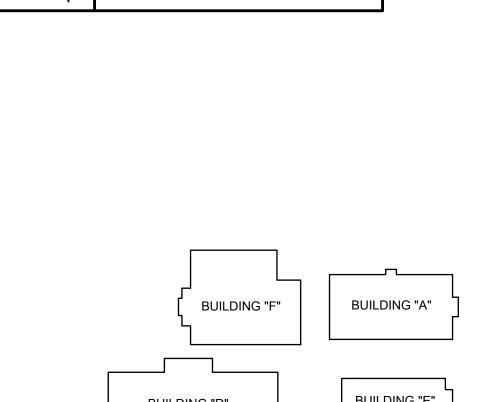

1126 SOUTH COMMERCE ST. HARLINGEN, TX PHONE: 956-230-3435 TEXAS REGISTERED **ENGINEERING FIRM** F-15998 APRIL 19, 202

CHECKED BY: DRAWN BY: PROJECT NO.:

P5.03

APRIL 19, 202 CHECKED BY: DRAWN BY:

PROJECT NO.:

P5.04

BUILDING "A"

BUILDING "E"

BUILDING "B"

BUILDING "H"

PROVIDE ALL DEMOLITION WORK REQUIRED FOR THE REMOVAL OF EXISTING NON REUSED PLUMBING EQUIPMENT AND ASSOCIATED DEVICES. PROVIDE A COMPLETE AND OPERABLE SYSTEM UPON COMPLETION OF

THE PROJECT.

OTHER TRADES.

COORDINATE WITH OWNER, AND DISPOSE OF EQUIPMENT AND MATERIALS THAT OWNER DOES NOT REMAIN.

PREPARE AREA FOR INSTALLATION OF NEW PLUMBING SYSTEMS. REFER

DEMOLITION

- 1 DEMOLISH EXISTING ELECTRIC WATER HEATER AT THIS APPROXIMATE
- 2 DEMOLISH EXISTING CONDENSATE PIPING THAT WILL NO LONGER BE USED AT THIS APPROXIMATE LOCATION NEAR THE 2" HUB DRAIN ON
- 3 ISOLATE AND DISCONNECT EXISTING COLD AND HOT WATER PIPES SERVING PLUMBING FIXTURE AT THIS APPROXIMATE LOCATION. CONNECT AFTER REPLACING.
- 4 DEMOLISH EXISTING PLUMBING FIXTURES MARKED ON PLANS.
- 5 PREPARE AREA FOR INSTALLATION OF NEW PLUMBING FIXTURES. COORDINATE WITH DEMOLITION.

2) PROVIDE AND INSTALL NEW ELECTRIC WATER HEATER EWH-4 AS

SCHEDULED OR AN APPROVED EQUAL. REFER TO P5.11. ADJUST PLUMBING LINES AND FITTINGS AS NECESSARY TO RECEIVE NEW WATER HEATER. REFER TO DETAIL ON DETAIL SHEET P5.11. 3) PROVIDE NEW 1-1/2" SOFT COPPER PIPING FOR CONDENSATE DRAIN

LINE OF EXISTING AIR CONDITIONING UNIT AT THIS APPROXIMATE LOCATION. PROVIDE 1" THICK FLEXIBLE ELECTROMETRIC INSULATION FOR NEW CONDENSATE PIPING AND CONNECT INTO EXISTING HUB DRAIN. NEW CONDENSATE PIPE SHALL BE SIZED AS PER AIR CONDITIONING UNIT MANUFACTURER RECOMMENDATIONS, ENSURE TO NOT PROVIDE A SMALLER PIPE SIZE THAN EXISTING.

4 APPROXIMATE LOCATION OF EXISTING ISOLATION VALVE. FIELD VERIFY EXACT LOCATION.

PLUMBING LEGEND					
— — TO BE DEMOLISHED					
WALL HYDRANT TO BE REPLACED					

BUILDING "F"

 ackslash BUILDING "D"

BUILDING "C"

BUILDING "G"

DEMOLITION GENERAL NOTES:

1. ALL DEMOLITION WORK SHALL BE DONE IN ACCORDANCE WITH ALL APPLICABLE CODES INCLUDING THOSE PUBLISHED BY OSHA.

2. A VISIT TO THE SITE IS REQUIRED TO PROPERLY BID THE DEMOLITION PLUMBING WORK. ALL INFORMATION SHOWN ON THE EXISTING CONSTRUCTION WILL BE REFERENCE ONLY AND WILL NEED TO BE FIELD VERIFIED BY THE CONTRACTOR.

COORDINATE DEMOLITION OF DIVISION 22 SYSTEM AS REQUIRED WITH ALL

5. ALL EXISTING EQUIPMENT AND MATERIALS REMOVED DURING CONSTRUCTION, THAT IS NOT TO BE REUSED, SHALL BE REMOVED FROM THE JOB SITE AND PROPERLY RETURNED TO THE OWNER, IF DESIRED BY

TO NEW PLANS AND COORDINATE WITH DEMOLITION WORK.


PLUMBING KEYED NOTES:

- LOCATION.

PLUMBING KEYED NOTES:

1) REMOVE AND REPLACE WALL HYDRANT AT THIS APPROXIMATE LOCATION. SEE SCHEDULE ON SHEET P5.11.

PL	PLUMBING LEGEND						
	TO BE DEMOLISHED						
	NEW CONDENSATE PIPE						
	WALL HYDRANT TO BE REPLACED						

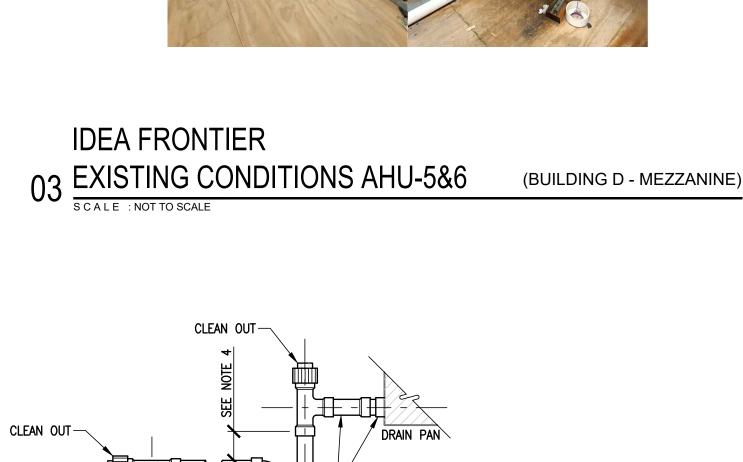

GENERAL NOTES:

EXISTING BOX/ENCLOSURE.

BUILDING FACADE/STRUCTURE.

WORKING AREAS PRIOR ANY WORK BEING DONE.

1. PLUMBING CONTRACTOR SHALL ISOLATE DOMESTIC COLD WATER SYSTEM AT THE

2. FOR ALL WALL HYDRANTS BEING REPLACED, CONTRACTOR SHALL RETAIN EXISTING

3. PLUMBING CONTRACTOR SHALL PERFORM ALL WORK CAREFULLY TO NOT DAMAGE

DEMOLITION ELECTRICAL KEYED NOTES:

1 APPROXIMATE LOCATION OF EXISTING PANELBOARD SERVING ELECTRIC WATER

2) DISCONNECT EXISTING ELECTRIC WATER HEATER FOR INSTALLATION OF NEW

APPROXIMATE LOCATION OF EXISTING PANELBOARD SERVING ELECTRIC WATER

CONNECT NEW ELECTRIC WATER HEATER. RETAIN AND REUSE EXISTING BRANCH CIRCUIT. IF EXISTING BRANCH CIRCUIT DOES NOT REACH NEW POINT OF


CONNECTION PROVIDE A J-BOX AND EXTEND WIRING AS NECESSARY.

ELECTRIC WATER HEATER. RETAIN AND REUSE EXISTING BRANCH CIRCUIT.

ELECTRICAL NEW KEYED NOTES:

BOX/ENCLOSURE AND SHALL REPLACE ALL INTERNAL COMPONENTS. IT WILL BE

CONTRACTOR RESPONSIBILITY TO PROVIDE AN EQUAL/SIMILAR HYDRANT TO FIT INTO

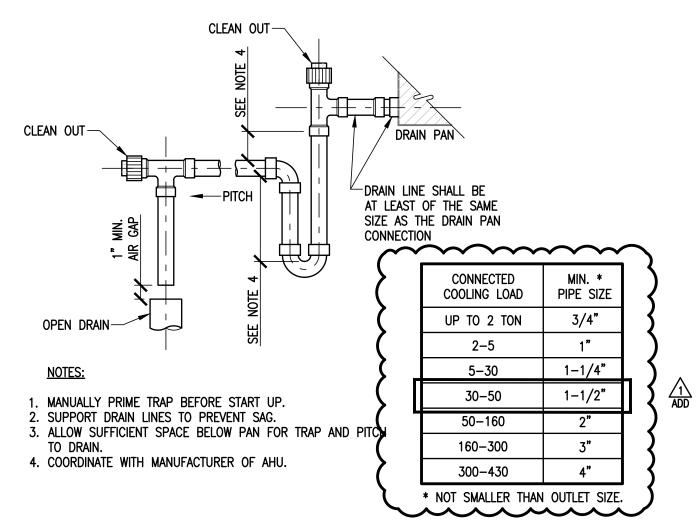

CONDENSATE DRAIN

TRAP PIPE

EXISTING CONDENSATE PIPING TO BE REMOVED

AND REPLACED

IDEA FRONTIER

02 NEW ELECTRICAL AND PLUMBING PLAN

01 DEMOLITION ELECTRICAL AND PLUMBING PLAN

IDEA FRONTIER

 $\langle 1 \rangle$

REFER TO 03 EXISTING CONDITIONS

ON THESE SAME SHEET.

(BUILDING D)

REFER TO 04 CONDENSATE DRAIN TRAP PIPE ON THESE SAME SHEET.

<u>ahu-5</u> (in mezzanine)

NORTH

NORTH

5

REFER TO 03 EXISTING CONDITIONS

REFER TO 04 CONDENSATE DRAIN TRAP

PIPE ON THESE SAME SHEET.

ON THESE SAME SHEET.

FRONTIER IDEA ACADEMY **KEYPLAN**

NO: REVISION: BY:

 $\frac{1}{ADD}$ 04/29/2024 ETHOS

COPY NO:

CSP # 27-LRPU-0424

*

CESAR A. GONZALEZ

04.19.2023

CHECKED BY: DRAWN BY: PROJECT NO.:

FRONTIER IDEA ACADEMY P5.07 KEYPLAN

BUILDING "A"

BUILDING "E"

BUILDING "B"

BUILDING "H"



EXACT LOCATION.

1. PLUMBING CONTRACTOR SHALL ISOLATE DOMESTIC COLD WATER SYSTEM AT THE WORKING AREAS PRIOR ANY WORK BEING DONE.

2. FOR ALL WALL HYDRANTS BEING REPLACED, CONTRACTOR SHALL RETAIN EXISTING BOX/ENCLOSURE AND SHALL REPLACE ALL INTERNAL COMPONENTS. IT WILL BE CONTRACTOR RESPONSIBILITY TO PROVIDE AN EQUAL/SIMILAR HYDRANT TO FIT INTO EXISTING BOX/ENCLOSURE.

3. PLUMBING CONTRACTOR SHALL PERFORM ALL WORK CAREFULLY TO NOT DAMAGE BUILDING FACADE/STRUCTURE.

PLUMBING KEYED NOTES:

REMOVE AND REPLACE WALL HYDRANT AT THIS APPROXIMATE LOCATION. SEE SCHEDULE ON SHEET P5.11. 2 PROVIDE AND INSTALL NEW ELECTRIC WATER HEATER EWH-5 AS SCHEDULED OR AN APPROVED EQUAL. REFER TO P5.11. ADJUST PLUMBING LINES AND FITTINGS AS NECESSARY TO RECEIVE NEW WATER HEATER. REFER TO DETAIL ON DETAIL SHEET P5.11. 3 APPROXIMATE LOCATION OF EXISTING ISOLATION VALVE. FIELD VERIFY

ELECTRICAL NEW KEYED NOTES:

APPROXIMATE LOCATION OF EXISTING PANELBOARD SERVING ELECTRIC WATER HEATER.

2 CONNECT NEW ELECTRIC WATER HEATER. RETAIN AND REUSE EXISTING BRANCH CIRCUIT. IF EXISTING BRANCH CIRCUIT DOES NOT REACH NEW AND EXTEND WIRING AS POINT OF CONNECTION PROVIDE A J-BOX AND EXTEND WIRING AS NECESSARY.


PL	PLUMBING LEGEND					
	— — TO BE DEMOLISHED					
○	WALL HYDRANT TO BE REPLACED					

BUILDING "F"

BUILDING "D"

BUILDING "C"

BUILDING "G"

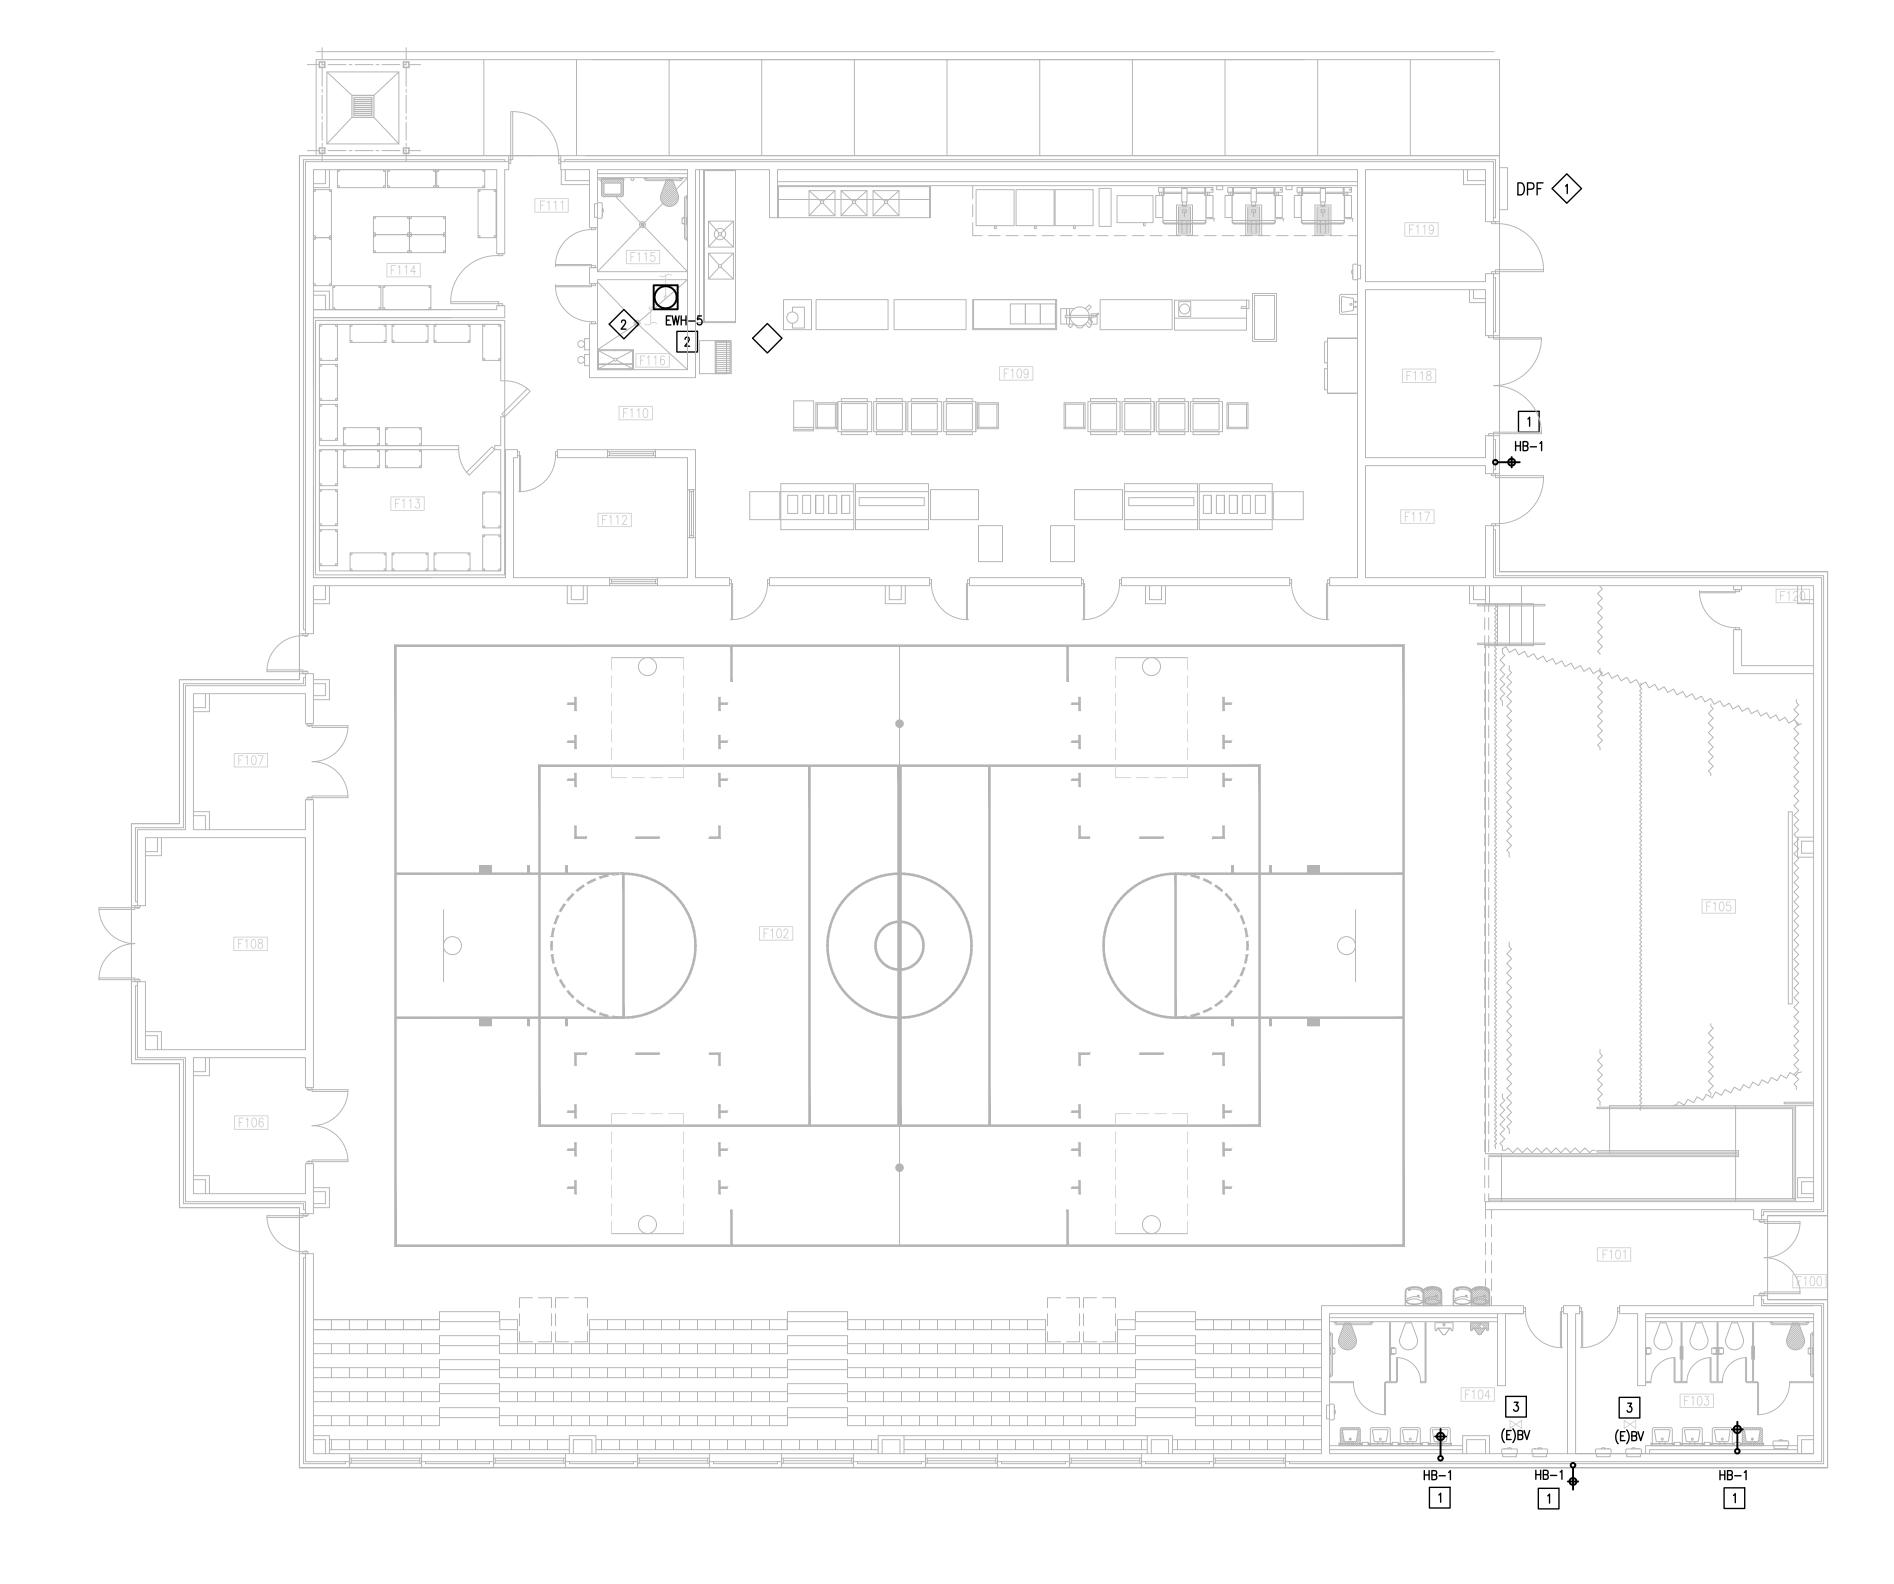







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eng		S
1126 SOUTH C HARLING PHONE: 95 TEXAS REC ENGINEER F-15	GEN, TX 6-230-3435 GISTERED RING FIRM	
DATE:	APRIL 1	19, 20

CHECKED BY: DRAWN BY: PROJECT NO.:

P5.11

	A PS PLUMBING UPGRADES MANUFACTURER &	CONNECTIONS						
MARK	MODEL NUMBER	DESCRIPTION	WASTE	VENT	CW	HW	NOTES	REMARKS
EDF-1	ELKAY LVRCTL8SC APRON 98324C CARRIER ELKAY MLP200	WALL MOUNTED ADA VANDAL-RESISTANT FILTERED, 8.0 GPH STAINLESS STEEL, BI-LEVEL ELECTRIC DRINKING FOUNTAIN. VANDAL- RESISTANT BUBBLERS WITH CHROME PLATED INTEGRAL HOOD GUARD, PVC P-TRAP, INDOOR RATED, APRON AND CARRIER. ADULT STANDARD & ADULT ADA MOUNTING.	2"	2"	1/2"	-	-	-
EDF-2	ELKAY LVRCTL8WSK APRON 98324C CARRIER ELKAY MLP200	WALL MOUNTED ADA VANDAL-RESISTANT FILTERED, 8.0 GPH STAINLESS STEEL, BOTTLE FILLING STATION & BI-LEVEL ELECTRIC DRINKING FOUNTAIN. VANDAL-RESISTANT BUBBLERS WITH CHROME PLATED INTEGRAL HOOD GUARD, PVC P-TRAP, INDOOR RATED, APRON AND CARRIER. ADULT STANDARD & ADULT ADA MOUNTING.	2"	2"	1/2"	-	-	-
WH-1&2	WOODFORD MODEL 65	THE MODEL 65 ARE AUTOMATIC DRAINING, FREEZELESS WALL HYDRANTS WITH SINGLE CHECK HOSE CONNECTION ANTI-SIPHON VACUUM BREAKERS. HYDRANTS DRAIN AS HANDLE IS SHUT OFF, EVEN IF HOSE IS ATTACHED. ALL MODELS ARE DESIGNED FOR IRRIGATION PURPOSES TO BLEND IN WITH MODERN ARCHITECTURE FOR INSTALLATION ON RESTAURANTS, SCHOOLS, OFFICE BUILDINGS, CHURCHES, APARTMENTS, MOTELS, STORES, SHOPPING CENTERS AND INDUSTRIAL BUILDINGS.	-	-	3/4"	-	-	
HB-1	WOODFORD MODEL 26	THE MODEL 26 ARE FIELD TESTABLE, BACKFLOW PROTECTED WALL FAUCETS INTENDED FOR IRRIGATION PURPOSES IN MILD CLIMATE AREAS. THE MODELS ARE DESIGNED TO BLEND WITH MODERN ARCHITECTURE FOR INSTALLATION ON OR IN HOMES, SERVICE STATIONS, CHURCHES, MOTELS, DRIVEIN RESTAURANTS, ETC.	-	-	3/4"	-	-	

ELE(ELECTRIC WATER HEATER SCHEDULE													
Project:	Project: IDEA PS PLUMBING UPGRADES AT LOWER RGV CAMPUSES													
MARK	LOCATION	SERVING	GALLON	KW	NUMBER	RECOVERY IN GPH	ELECT.	MANUFACTURER	NOTES					
IVIARK	LOCATION	SERVING	CAPACITY	r\vv	OF ELEMENTS	AT 120°F RISE	V/P/H	& MODEL	NOTES					
EWH-1	SEE PLANS	SEE PLANS	6	3	1	10	208/1/60	A.O. SMITH DEL-6	ALL					
EWH-2	SEE PLANS	SEE PLANS	6	3	1	10	208/1/60	A.O. SMITH DEL-6	ALL					
EWH-3	SEE PLANS	SEE PLANS	6	3	1	10	208/1/60	A.O. SMITH DEL-6	ALL					
EWH-4	SEE PLANS	SEE PLANS	6	3	1	10	208/1/60	A.O. SMITH DEL-6	ALL					
EWH-5	SEE PLANS	SEE PLANS	120	54	3	185	480/3/60	A.O. SMITH DSE-120A	ALL					

NOTES:

- 1. MANUFACTURER & MODEL NUMBER ARE "OR APPROVED EQUAL".
- 2. PROVIDE INMERSION TYPE THERMOSTAT.








WH-1&2 05 SCALE: NOT TO SCALE




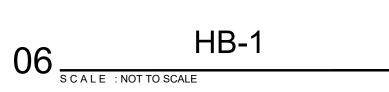




EWH-1,2,3&4 SCALE: NOT TO SCALE



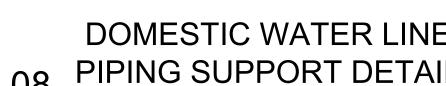

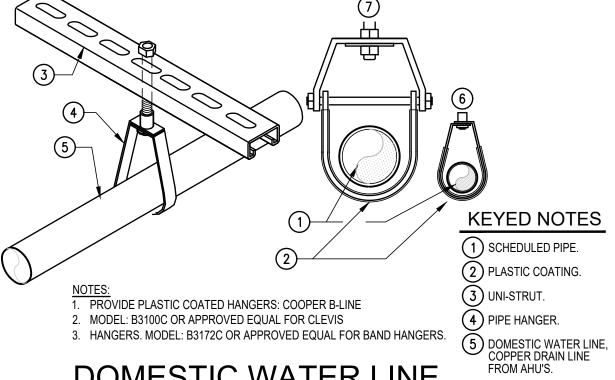

PROVIDE HEAT TRAP DEVICE OR AN ARRANGEMENT OF TUBING AS PER IEEC. INSULATE THE FIRST 8' OF OUTLET PIPING AND THE INLET PIPING BETWEEN

COLD WATER SUPPLY

FINISHED FLOOR

ELECTRIC WATER HEATER DETAIL

KEYED NOTES

3 PAN WITH DRAIN.

4 3/4" MIN. MOISTURE RESISTANT PLYWD.

5 SECURE TO WALL AS REQUIRED.

1) POP-OFF VALVE/ANTI-SIPHON DEVICE.

2 ELECTRIC WATER HEATER AS SCHEDULED.

6 (2) 3/8"ø RODS, SECURE TO STRUCTURE.

7 RELIEF VALVE WITH 3/4"MIN. COPPER DRAIN LINE TO MOP SINK OR OPEN DRAIN.

8 HEATING ELEMENT AS SPEC'D.

9 SINK OR OPEN DRAIN.

(2) KNEE BRACES, L 10 1.25X1.25X.25 GALV.. @ 8" O.C. WITH WELDED JOINTS.

11 MOP SERVICE BASIN

THE STORAGE TANK AND A HEAT TRAP (INCLUDE THE HEAT TRAP).

EXISTING

SUPPLY

6

HOT WATER

EWH-1,2,3&4 WALL MOUNTED

DOMESTIC WATER LINE

OB PIPING SUPPORT DETAIL

SCALE : NOT TO SCALE

DOMESTIC WAT. COPPER DRAIN I FROM AHU'S.


6 BAND HANGER.

7 CLEVIS HANGER.



EDF-1

EWH-5

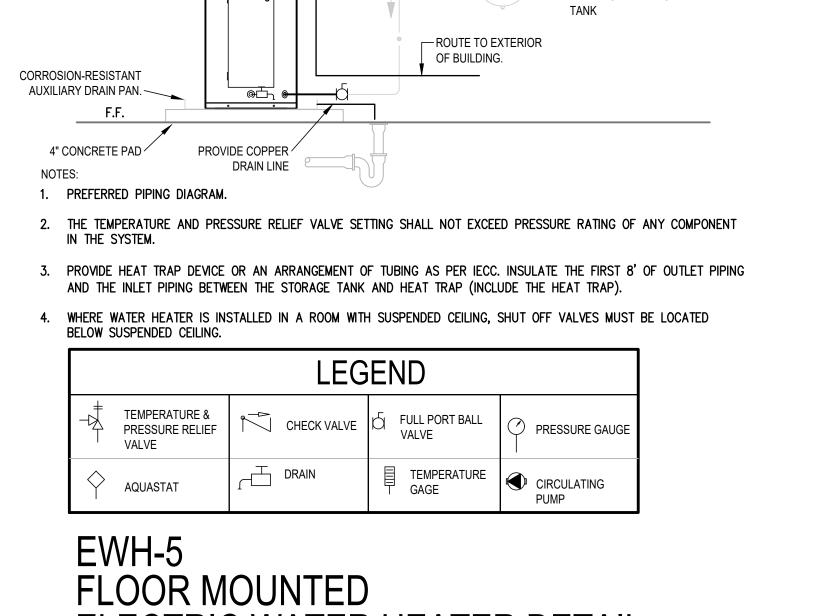

- PROVIDE COPPER RELIEF LINE AND

PIPE T&P RUN TO

EXTERIOR OF BUILDING.

AQUASTAT

—HOT WATER

RETURN

COLD WATER







EXISTING
HOT WATER

POINT OF ELECTRICAL CONNECTION. MEANS OF

DISCONNECT TO BE PROVIDED BY DIV. 16. COORDINATE WITH

ELECTRICAL CONTRACTOR.

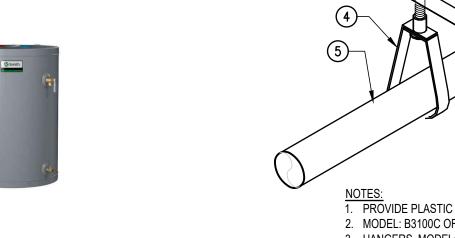

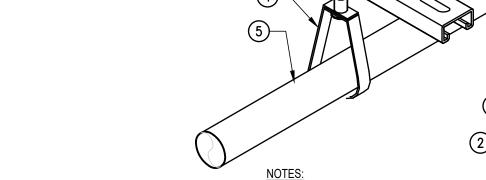




NO: REVISION:

F-15998 APRIL 19, 202 CHECKED BY: C.A.G. DRAWN BY:

PROJECT NO.: P6.01

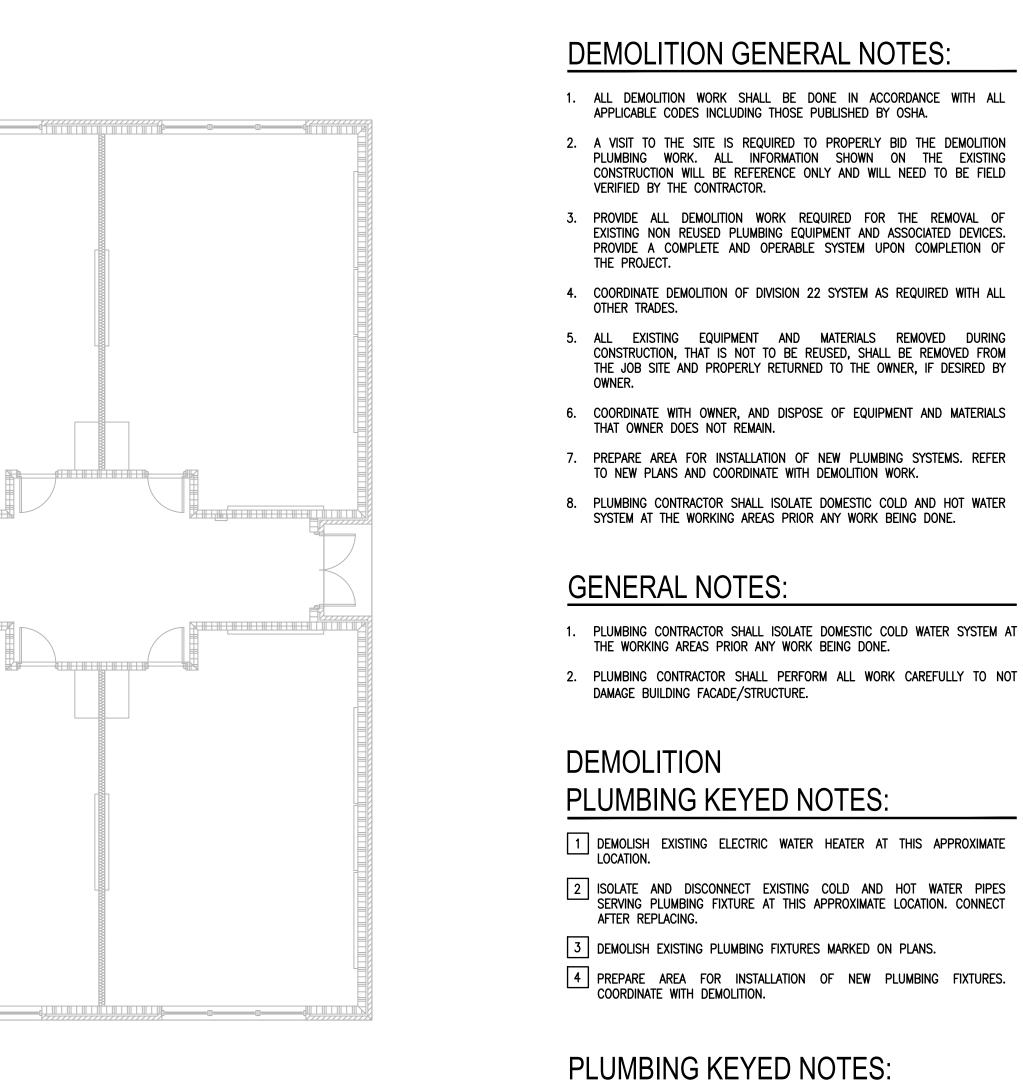

PLUMBING KEYED NOTES:

COORDINATE WITH DEMOLITION.

1) PROVIDE AND INSTALL NEW ELECTRIC WATER HEATER EWH-1 AS SCHEDULED OR AN APPROVED EQUAL. REFER TO P6.05. ADJUST PLUMBING LINES AND FITTINGS AS NECESSARY TO RECEIVE NEW WATER HEATER. REFER TO DETAIL ON DETAIL SHEET P6.05.

APPLICABLE CODES INCLUDING THOSE PUBLISHED BY OSHA.

VERIFIED BY THE CONTRACTOR.

THAT OWNER DOES NOT REMAIN.

THE PROJECT.

OTHER TRADES.

PLUMBING WORK. ALL INFORMATION SHOWN ON THE EXISTING CONSTRUCTION WILL BE REFERENCE ONLY AND WILL NEED TO BE FIELD

EXISTING NON REUSED PLUMBING EQUIPMENT AND ASSOCIATED DEVICES. PROVIDE A COMPLETE AND OPERABLE SYSTEM UPON COMPLETION OF

CONSTRUCTION, THAT IS NOT TO BE REUSED, SHALL BE REMOVED FROM THE JOB SITE AND PROPERLY RETURNED TO THE OWNER, IF DESIRED BY

TO NEW PLANS AND COORDINATE WITH DEMOLITION WORK.

THE WORKING AREAS PRIOR ANY WORK BEING DONE.

DAMAGE BUILDING FACADE/STRUCTURE.

LOCATION.

AFTER REPLACING.

SYSTEM AT THE WORKING AREAS PRIOR ANY WORK BEING DONE.




DEMOLITION ELECTRICAL KEYED NOTES:


- 1) APPROXIMATE LOCATION OF EXISTING PANELBOARD SERVING ELECTRIC WATER HEATER.
- DISCONNECT EXISTING ELECTRIC WATER HEATER FOR INSTALLATION OF NEW ELECTRIC WATER HEATER. RETAIN AND REUSE EXISTING BRANCH CIRCUIT.

ELECTRICAL NEW KEYED NOTES:

- APPROXIMATE LOCATION OF EXISTING PANELBOARD SERVING ELECTRIC WATER HEATER.
- 2 CONNECT NEW ELECTRIC WATER HEATER. RETAIN AND REUSE EXISTING BRANCH CIRCUIT. IF EXISTING BRANCH CIRCUIT DOES NOT REACH NEW POINT OF CONNECTION PROVIDE A J-BOX AND EXTEND WIRING AS

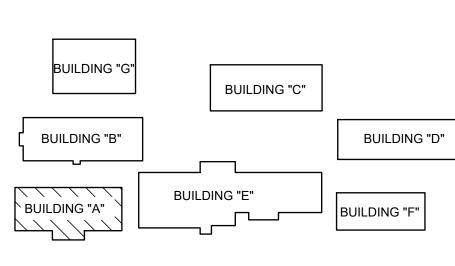

SAN BENITO IDEA ACADEMY KEYPLAN

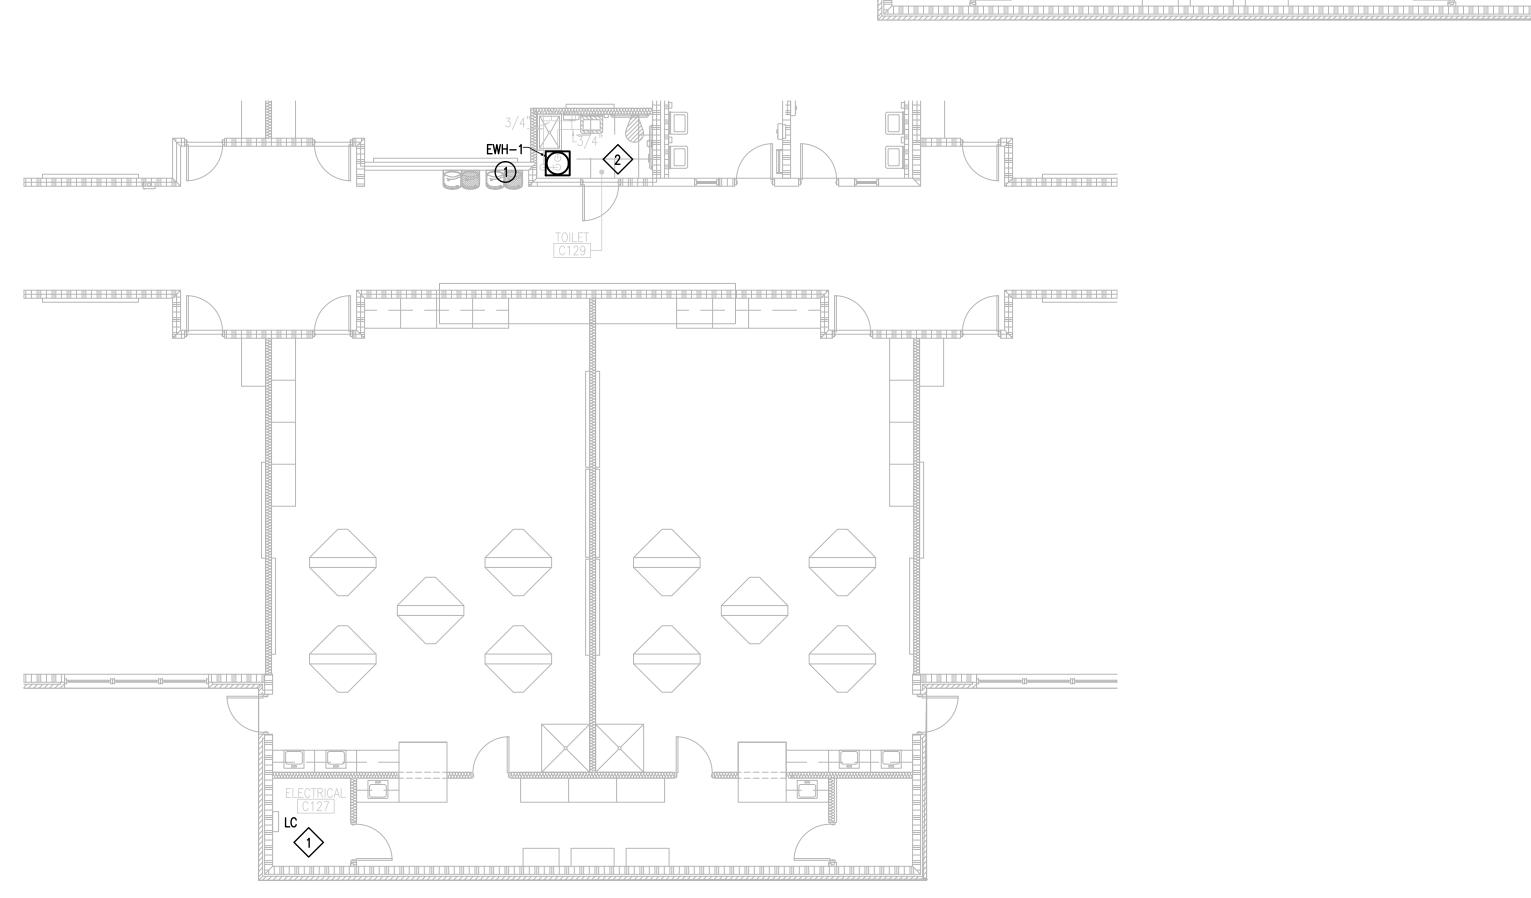

01 DEMOLITION ELECTRICAL AND PLUMBING PLAN
SCALE: 1/8" = 1'-0"

IDEA SAN BENITO



(BUILDING A)

(BUILDING A)

NORTH

NORTH

3 4

NORTH

(BUILDING B)

DEMOLITION GENERAL NOTES:

- 1. ALL DEMOLITION WORK SHALL BE DONE IN ACCORDANCE WITH ALL APPLICABLE CODES INCLUDING THOSE PUBLISHED BY OSHA.
- 2. A VISIT TO THE SITE IS REQUIRED TO PROPERLY BID THE DEMOLITION PLUMBING WORK. ALL INFORMATION SHOWN ON THE EXISTING CONSTRUCTION WILL BE REFERENCE ONLY AND WILL NEED TO BE FIELD VERIFIED BY THE CONTRACTOR.
- 3. PROVIDE ALL DEMOLITION WORK REQUIRED FOR THE REMOVAL OF EXISTING NON REUSED PLUMBING EQUIPMENT AND ASSOCIATED DEVICES. PROVIDE A COMPLETE AND OPERABLE SYSTEM UPON COMPLETION OF THE PROJECT.
- 4. COORDINATE DEMOLITION OF DIVISION 22 SYSTEM AS REQUIRED WITH ALL OTHER TRADES.
- 5. ALL EXISTING EQUIPMENT AND MATERIALS REMOVED DURING CONSTRUCTION, THAT IS NOT TO BE REUSED, SHALL BE REMOVED FROM THE JOB SITE AND PROPERLY RETURNED TO THE OWNER, IF DESIRED BY
- 6. COORDINATE WITH OWNER, AND DISPOSE OF EQUIPMENT AND MATERIALS THAT OWNER DOES NOT REMAIN.
- 7. PREPARE AREA FOR INSTALLATION OF NEW PLUMBING SYSTEMS. REFER TO NEW PLANS AND COORDINATE WITH DEMOLITION WORK.
- 8. PLUMBING CONTRACTOR SHALL ISOLATE DOMESTIC COLD AND HOT WATER SYSTEM AT THE WORKING AREAS PRIOR ANY WORK BEING DONE.

GENERAL NOTES:

- 1. PLUMBING CONTRACTOR SHALL ISOLATE DOMESTIC COLD WATER SYSTEM AT THE WORKING AREAS PRIOR ANY WORK BEING DONE.
- 2. PLUMBING CONTRACTOR SHALL PERFORM ALL WORK CAREFULLY TO NOT DAMAGE BUILDING FACADE/STRUCTURE.

DEMOLITION PLUMBING KEYED NOTES:

- 1 DEMOLISH EXISTING ELECTRIC WATER HEATER AT THIS APPROXIMATE LOCATION.
- 2 ISOLATE AND DISCONNECT EXISTING COLD AND HOT WATER PIPES SERVING PLUMBING FIXTURE AT THIS APPROXIMATE LOCATION. CONNECT AFTER REPLACING.
- 3 DEMOLISH EXISTING PLUMBING FIXTURES MARKED ON PLANS.
- 4 PREPARE AREA FOR INSTALLATION OF NEW PLUMBING FIXTURES. COORDINATE WITH DEMOLITION.

(1) PROVIDE AND INSTALL NEW ELECTRIC WATER HEATER EWH-2 AS SCHEDULED OR AN APPROVED EQUAL. REFER TO P6.05. ADJUST PLUMBING LINES AND FITTINGS AS NECESSARY TO RECEIVE NEW WATER HEATER. REFER TO DETAIL ON DETAIL SHEET P6.05.

PLUMBING LEGEND


TO BE DEMOLISHED

DEMOLITION **ELECTRICAL KEYED NOTES:**

- APPROXIMATE LOCATION OF EXISTING PANELBOARD SERVING ELECTRIC WATER HEATER.
- DISCONNECT EXISTING ELECTRIC WATER HEATER FOR INSTALLATION OF NEW ELECTRIC WATER HEATER. RETAIN AND REUSE EXISTING BRANCH

ELECTRICAL NEW KEYED NOTES:

- APPROXIMATE LOCATION OF EXISTING PANELBOARD SERVING ELECTRIC WATER HEATER.
- 2 CONNECT NEW ELECTRIC WATER HEATER. RETAIN AND REUSE EXISTING BRANCH CIRCUIT. IF EXISTING BRANCH CIRCUIT DOES NOT REACH NEW POINT OF CONNECTION PROVIDE A J-BOX AND EXTEND WIRING AS

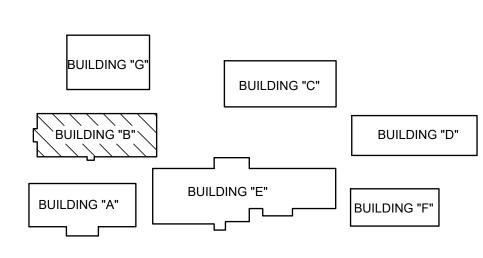

SAN BENITO IDEA ACADEMY KEYPLAN

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04.19.2023

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1126 SOUTH COMMERCE ST. HARLINGEN, TX

PHONE: 956-230-3435 TEXAS REGISTERED ENGINEERING FIRM

F-15998

P6.04

CHECKED BY:

PROJECT NO.:

DRAWN BY:

APRIL 19, 202


PLUMBING LEGEND

DEMOLITION


DISCONNECT EXISTING ELECTRIC WATER HEATER FOR INSTALLATION OF NEW ELECTRIC WATER HEATER. RETAIN AND REUSE EXISTING BRANCH

ELECTRICAL NEW KEYED NOTES:

- APPROXIMATE LOCATION OF EXISTING PANELBOARD SERVING ELECTRIC WATER HEATER.
- 2 CONNECT NEW ELECTRIC WATER HEATER. RETAIN AND REUSE EXISTING POINT OF CONNECTION PROVIDE A J-BOX AND EXTEND WIRING AS NECESSARY.

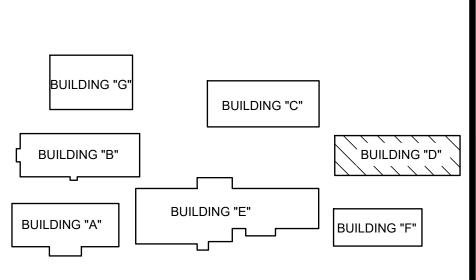


KEYPLAN

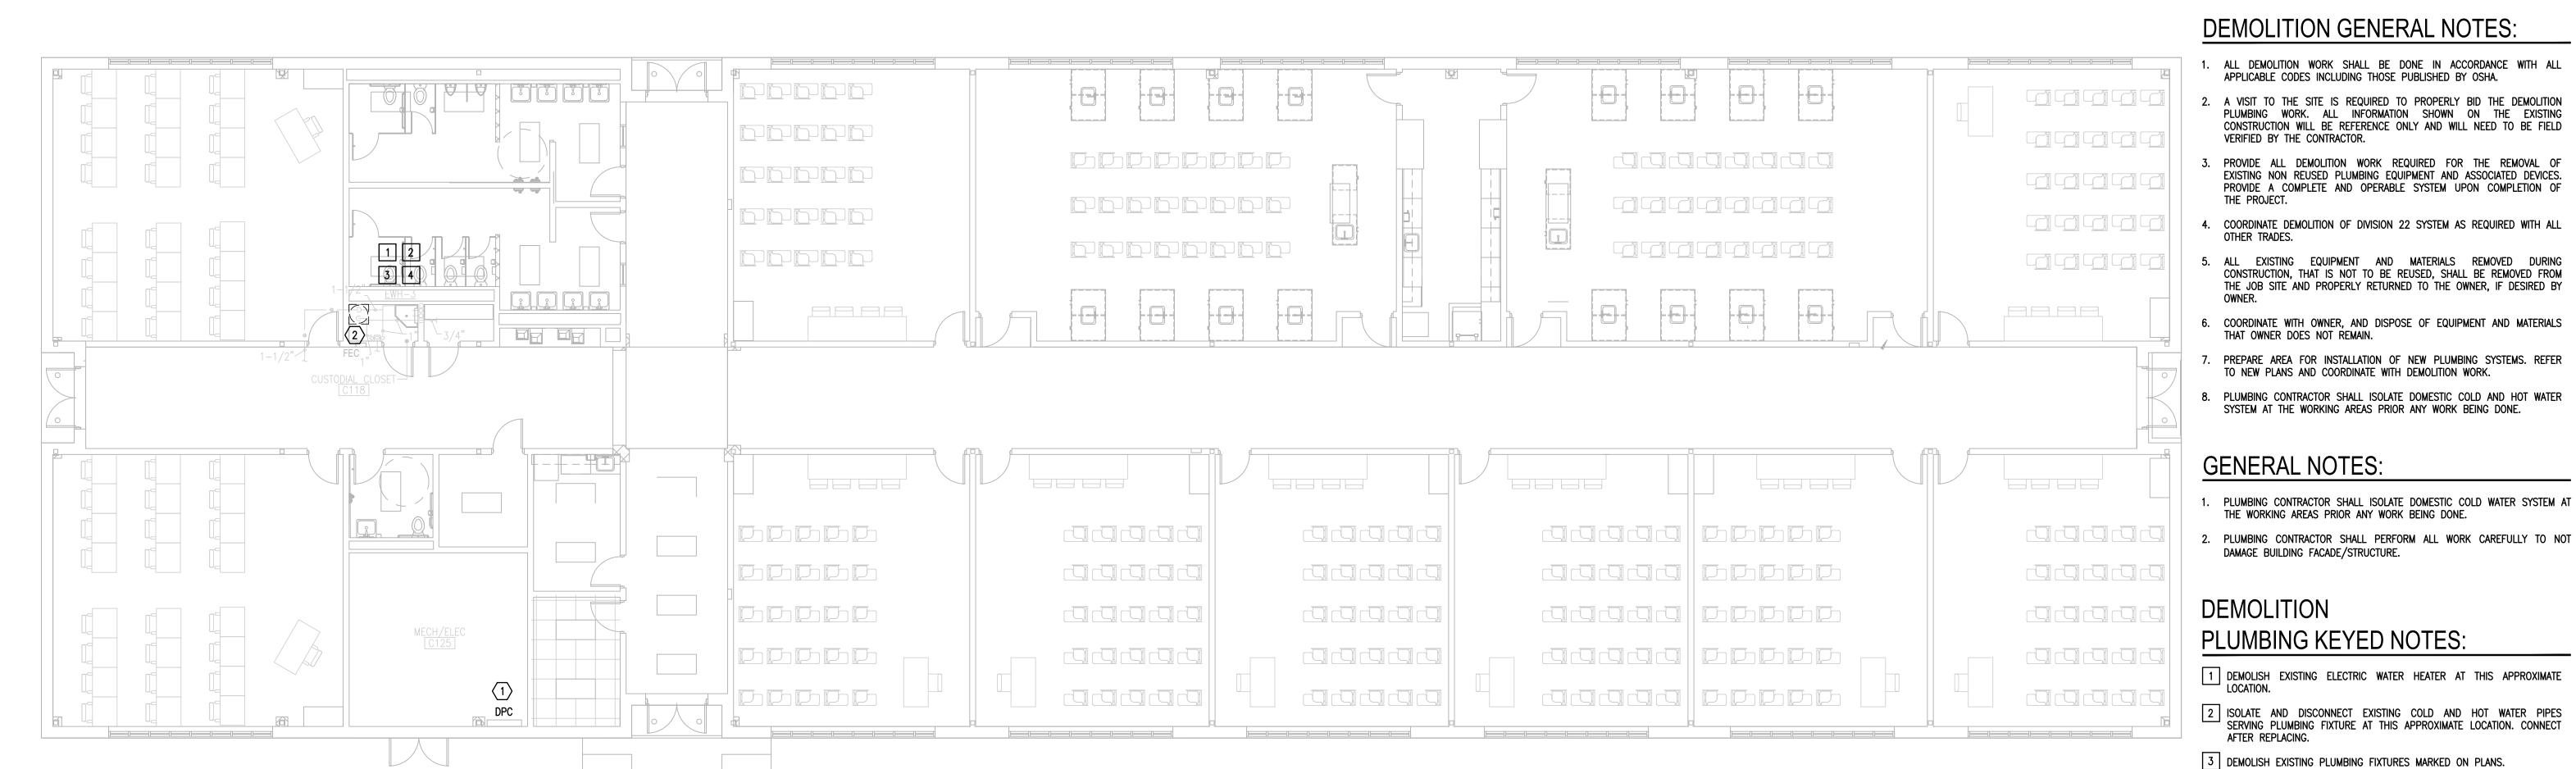

IDEA SAN BENITO

01 DEMOLITION ELECTRICAL AND PLUMBING PLAN

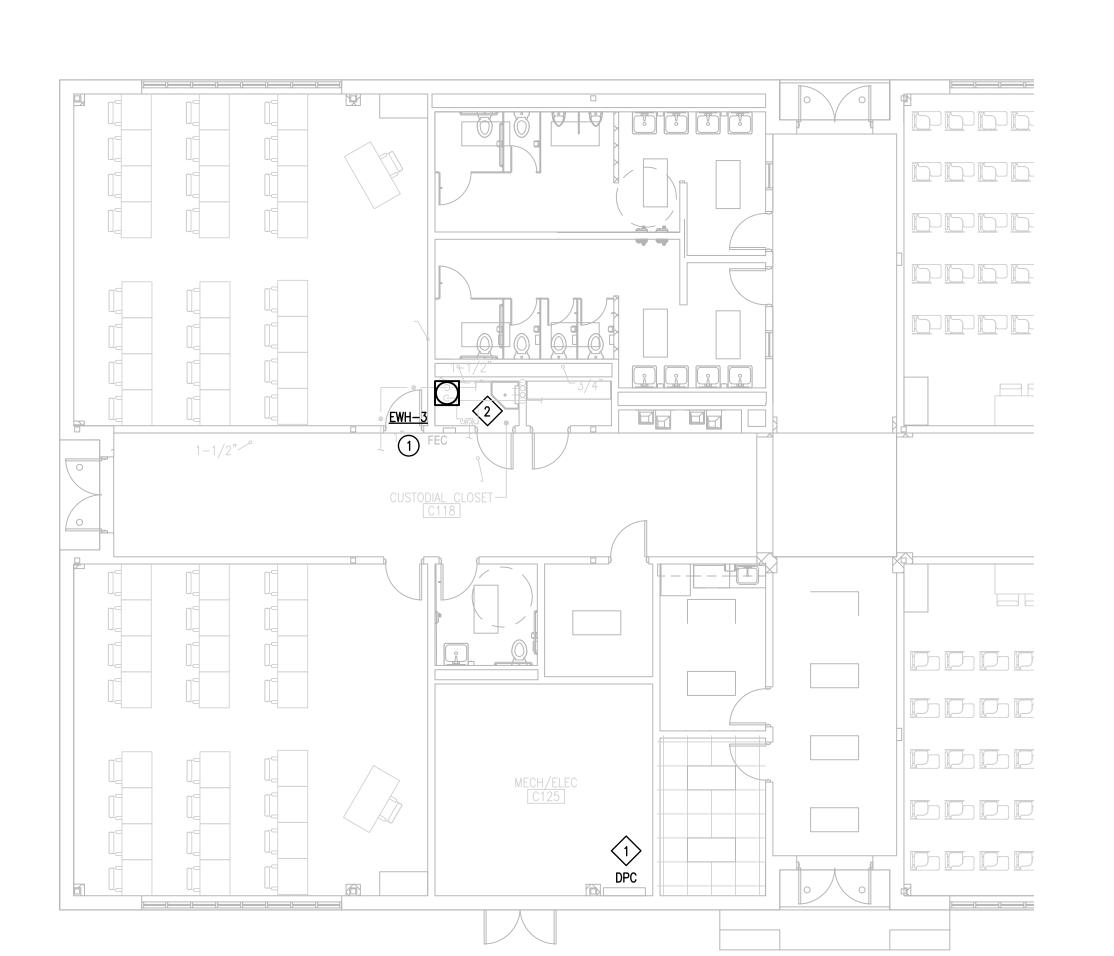

IDEA SAN BENITO 02 NEW ELECTRICAL AND PLUMBING PLAN

(BUILDING D)

NORTH

4 PREPARE AREA FOR INSTALLATION OF NEW PLUMBING FIXTURES. COORDINATE WITH DEMOLITION.

PLUMBING KEYED NOTES: (1) PROVIDE AND INSTALL NEW ELECTRIC WATER HEATER EWH—3 AS SCHEDULED OR AN APPROVED EQUAL. REFER TO P6.05. ADJUST

PLUMBING LINES AND FITTINGS AS NECESSARY TO RECEIVE NEW WATER HEATER. REFER TO DETAIL ON DETAIL SHEET P6.05.



ELECTRICAL KEYED NOTES:

- 1 APPROXIMATE LOCATION OF EXISTING PANELBOARD SERVING ELECTRIC WATER HEATER.
- BRANCH CIRCUIT. IF EXISTING BRANCH CIRCUIT DOES NOT REACH NEW

FRONTIER IDEA ACADEMY

ELEC	ELECTRIC WATER HEATER SCHEDULE											
Project:	Project: IDEA PS PLUMBING UPGRADES AT LOWER RGV CAMPUSES											
MARK	LOCATION	SERVING	GALLON	KW	NUMBER	RECOVERY IN GPH	ELECT.	MANUFACTURER	NOTE			
IVIZALXIX	LOCATION	OLIVINO	CAPACITY	IVV	OF ELEMENTS	AT 120°F RISE	V/P/H	& MODEL	INOTE			
EWH-1	SEE PLANS	SEE PLANS	6	3	1	10	208/1/60	A.O. SMITH DEL-6	ALL			
EWH-2	SEE PLANS	SEE PLANS	6	3	1	10	208/1/60	A.O. SMITH DEL-6	ALL			
EWH-3	SEE PLANS	SEE PLANS	6	3	1	10	208/1/60	A.O. SMITH DEL-6	ALL			
-			-		<u> </u>	<u> </u>	•	<u> </u>				

NOTES:

1. MANUFACTURER & MODEL NUMBER ARE "OR APPROVED EQUAL".


2. PROVIDE INMERSION TYPE THERMOSTAT.






01_____EWH-1,2&3

 $02\frac{TS-1}{\text{SCALE:NOTTO SCALE}}$

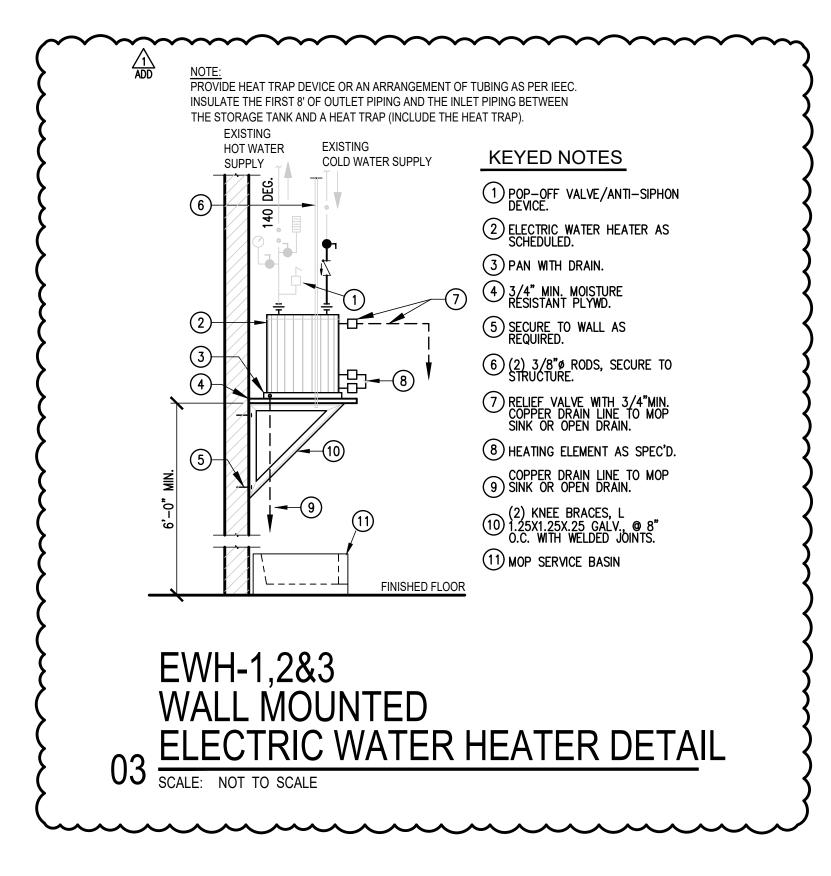

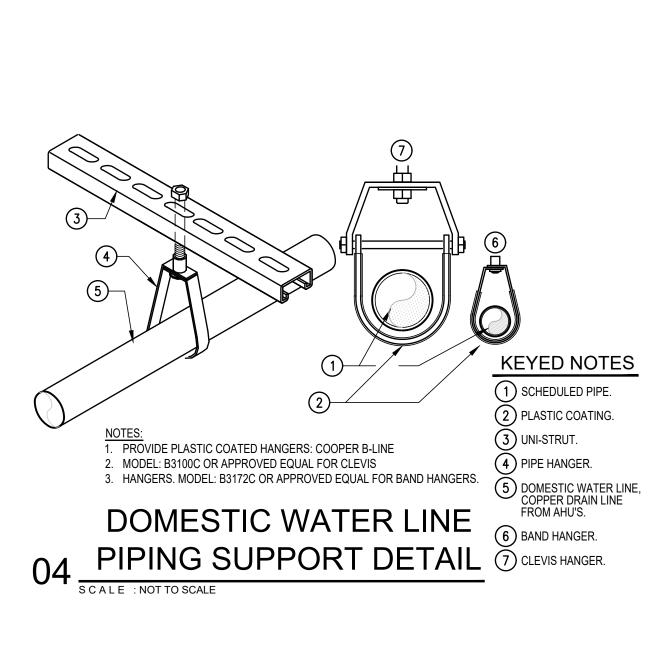

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COPY NO:

CSP # 27-LRPU-0424

CESAR A. GONZALEZ

04.19.2023



PROJECT NO.:

CAD FILE:
SHEET:
P6.05


NORTH


NO: REVISION: BY:

1 04/29/2024 ETHOS


COPY NO:

P7.03

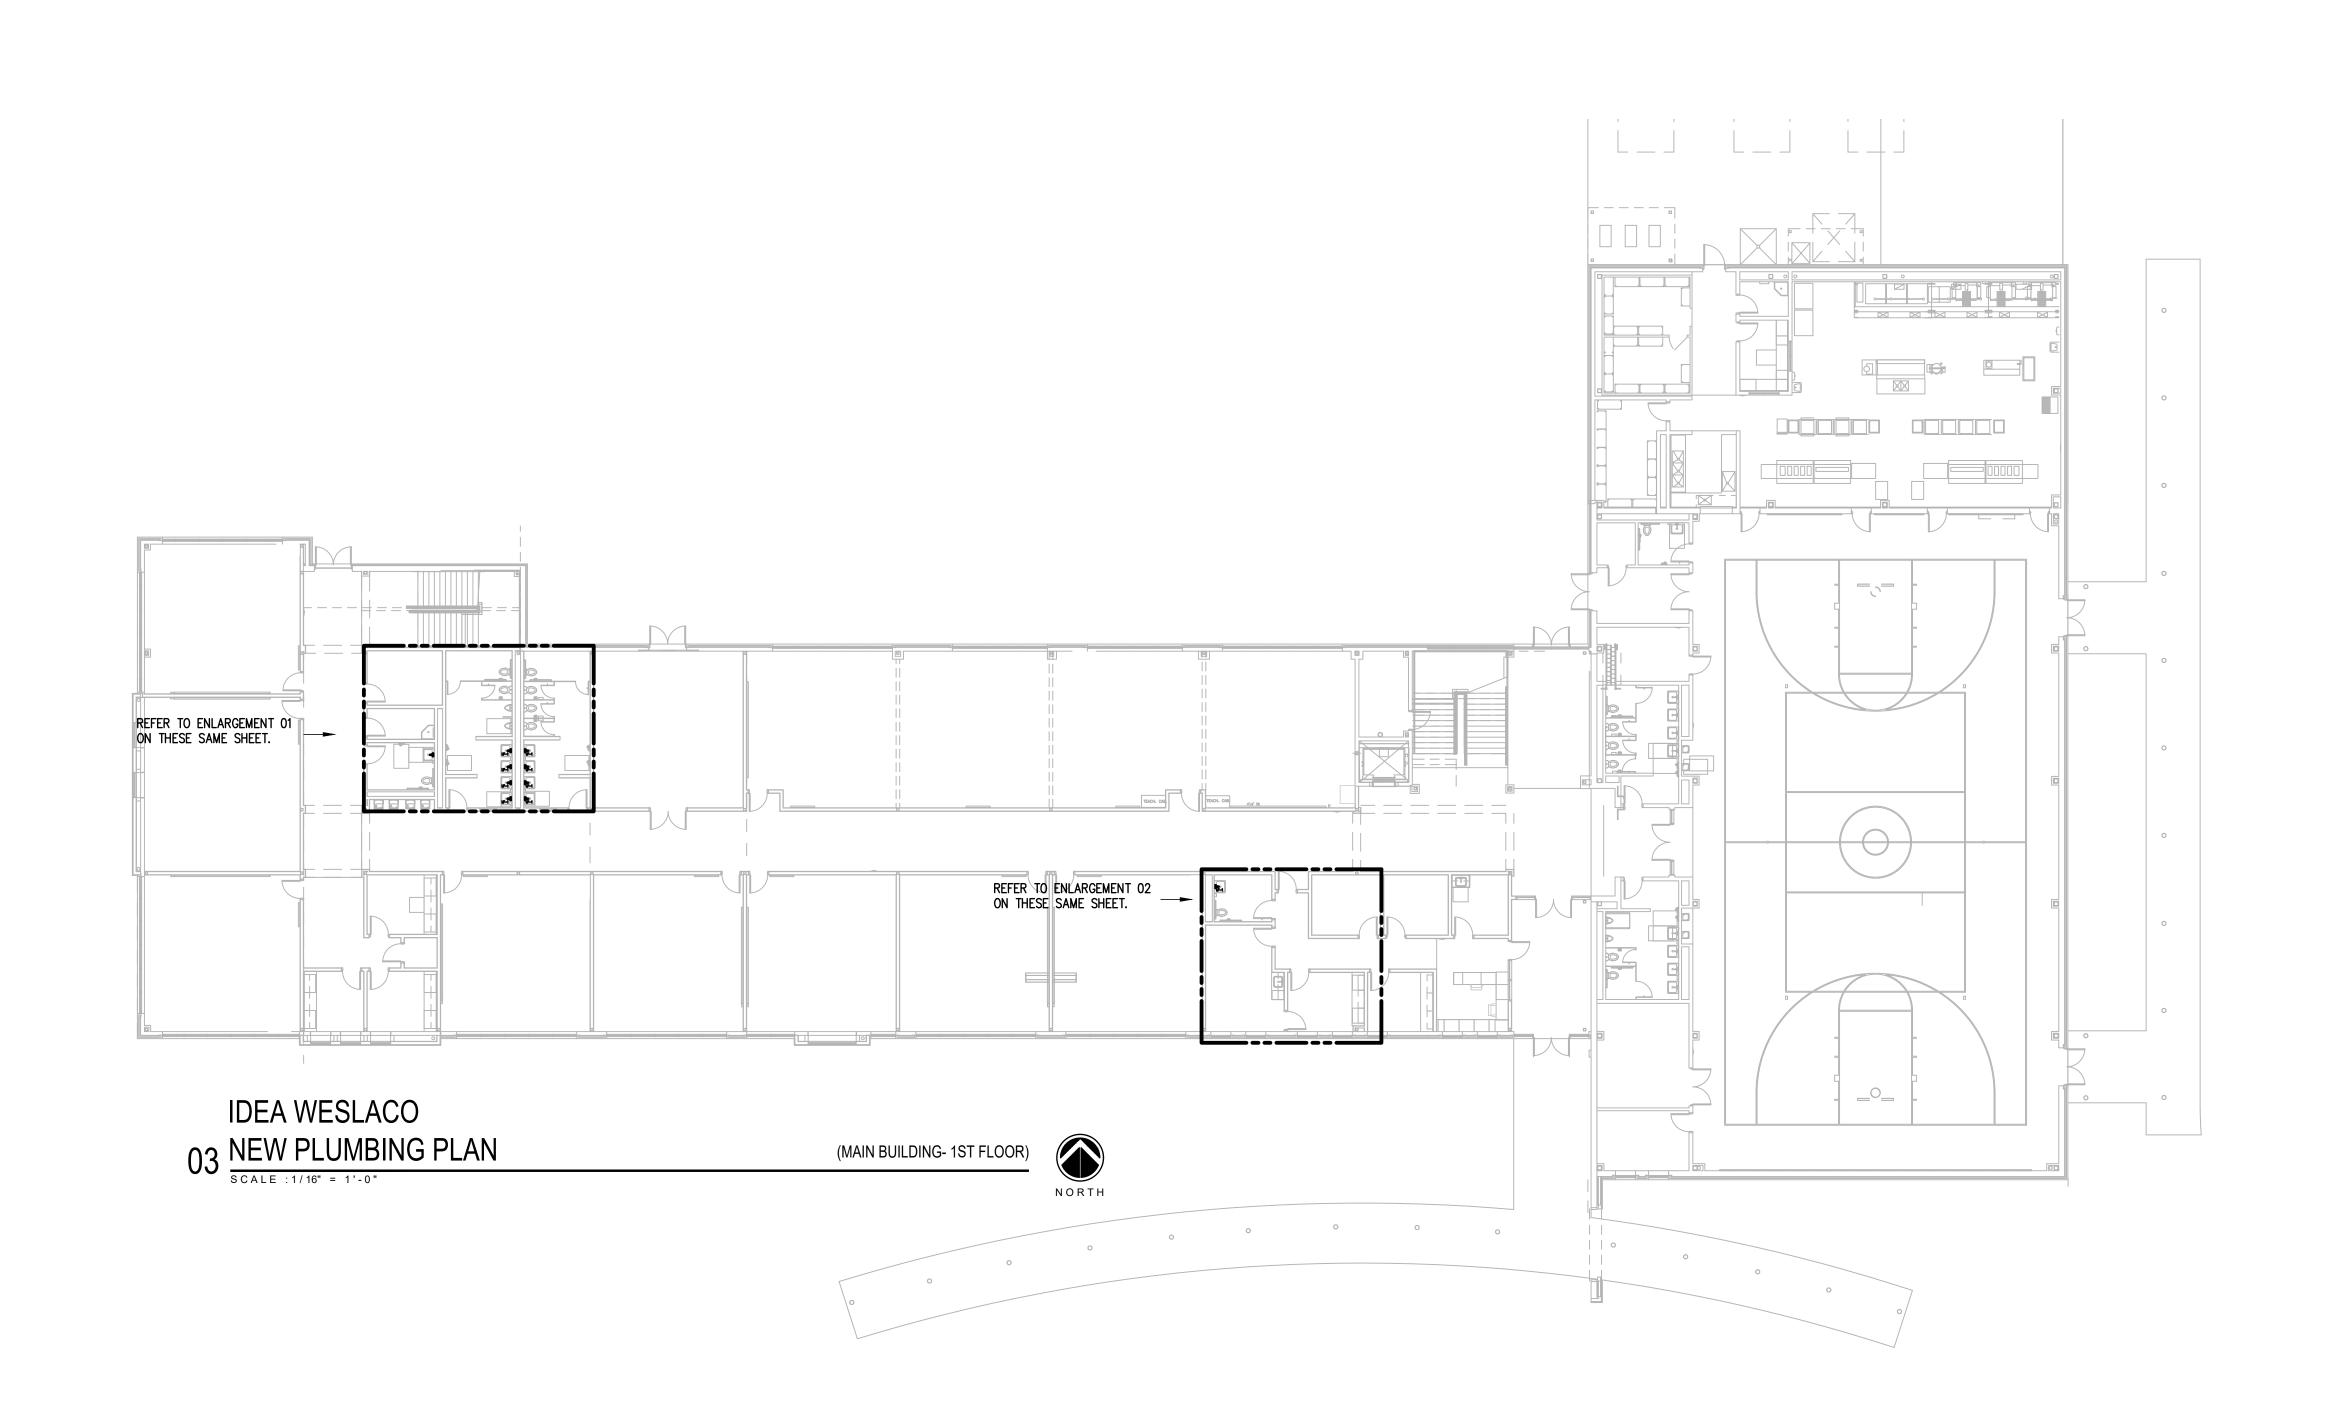

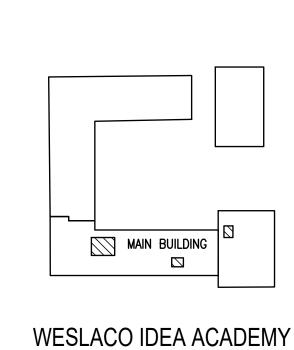

KEYPLAN

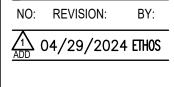

COPY NO: CSP # 27-LRPU-0424



FIXTURE AS NECESSARY. PROVIDE NEW CHECK 1 1/2" CHECK VALVE AS PER SPECIFICATIONS AND INSTALL AT THIS APPROXIMATE LOCATION.

PLUMBING CONTRACTOR SHALL TURN ON TEMPERED WATER SYSTEM SERVING RESTROOMS AFTER REPLACING THERMOSTATIC MIXING VALVE.

SPECIFICATIONS TO THE AREAS WHERE WORK IS BEING PERFORMED.

CIRCULATING PUMPS AND VALVES. CONTRACTOR SHALL PROVIDE INSULATION TO ALL HOT WATER AND TEMPERED WATER PIPING AS PER

1 PROVIDE NEW CIRCULATING PUMP (CP-1), AS SCHEDULED OR AN APPROVED EQUAL. SEE ASSOCIATED DETAIL ON SHEET P7.05 ADJUST PLUMBING LINES AND FITTINGS TO THE NEW PLUMBING FIXTURE AS

2 PROVIDE THERMOSTATIC MIXING VALVE (TMV-1) NAVIGATOR BRADLEY MODEL: S59-2025 OR APPROVED EQUAL. ADJUST PLUMBING LINES AND FITTINGS TO NEW THERMOSTATIC MIXING VALVE AND SET TEMPERATURE TO 100 F. SEE SCHEDULE ON SHEET P7.05.

REPLACE EXISTING FAUCET WITH NEW ONE AS SCHEDULED ON SHEET P7.05. ADJUST PLUMBING LINES AND FITTINGS TO THE NEW PLUMBING

PLUMBING KEYED NOTES:

ELECTRICAL NEW KEYED NOTES:

GENERAL NOTES:

1 APPROXIMATE LOCATION OF EXISTING PANELBOARD AT FIRST FLOOR SERVING ELECTRIC CIRCULATING PUMP.

2 CONNECT NEW ELECTRIC WATER HEATER. RETAIN AND REUSE EXISTING BRANCH CIRCUIT. IF EXISTING BRANCH CIRCUIT DOES NOT REACH NEW POINT OF CONNECTION PROVIDE A J-BOX AND EXTEND WIRING AS

EXISTING THERMOSTATIC MIXING VALVE TO BE REMOVED AND REPLACE. **-**<u>TMV-1</u> CHECK TO BE REPLACED EXISTING CIRCULATING PUMP TO BE REMOVED AND REPLACED.

IDEA WESLACO

(MAIN BUILDING- 2ND FLOOR)

NORTH


ENLARGEMENT IDEA WESLACO


01 DEMOLITION PLUMBING PLAN

(MAIN BUILDING- 1ST FLOOR)

NORTH

03 EXISTING CONDITIONS S C A L E : NOT TO SCALE

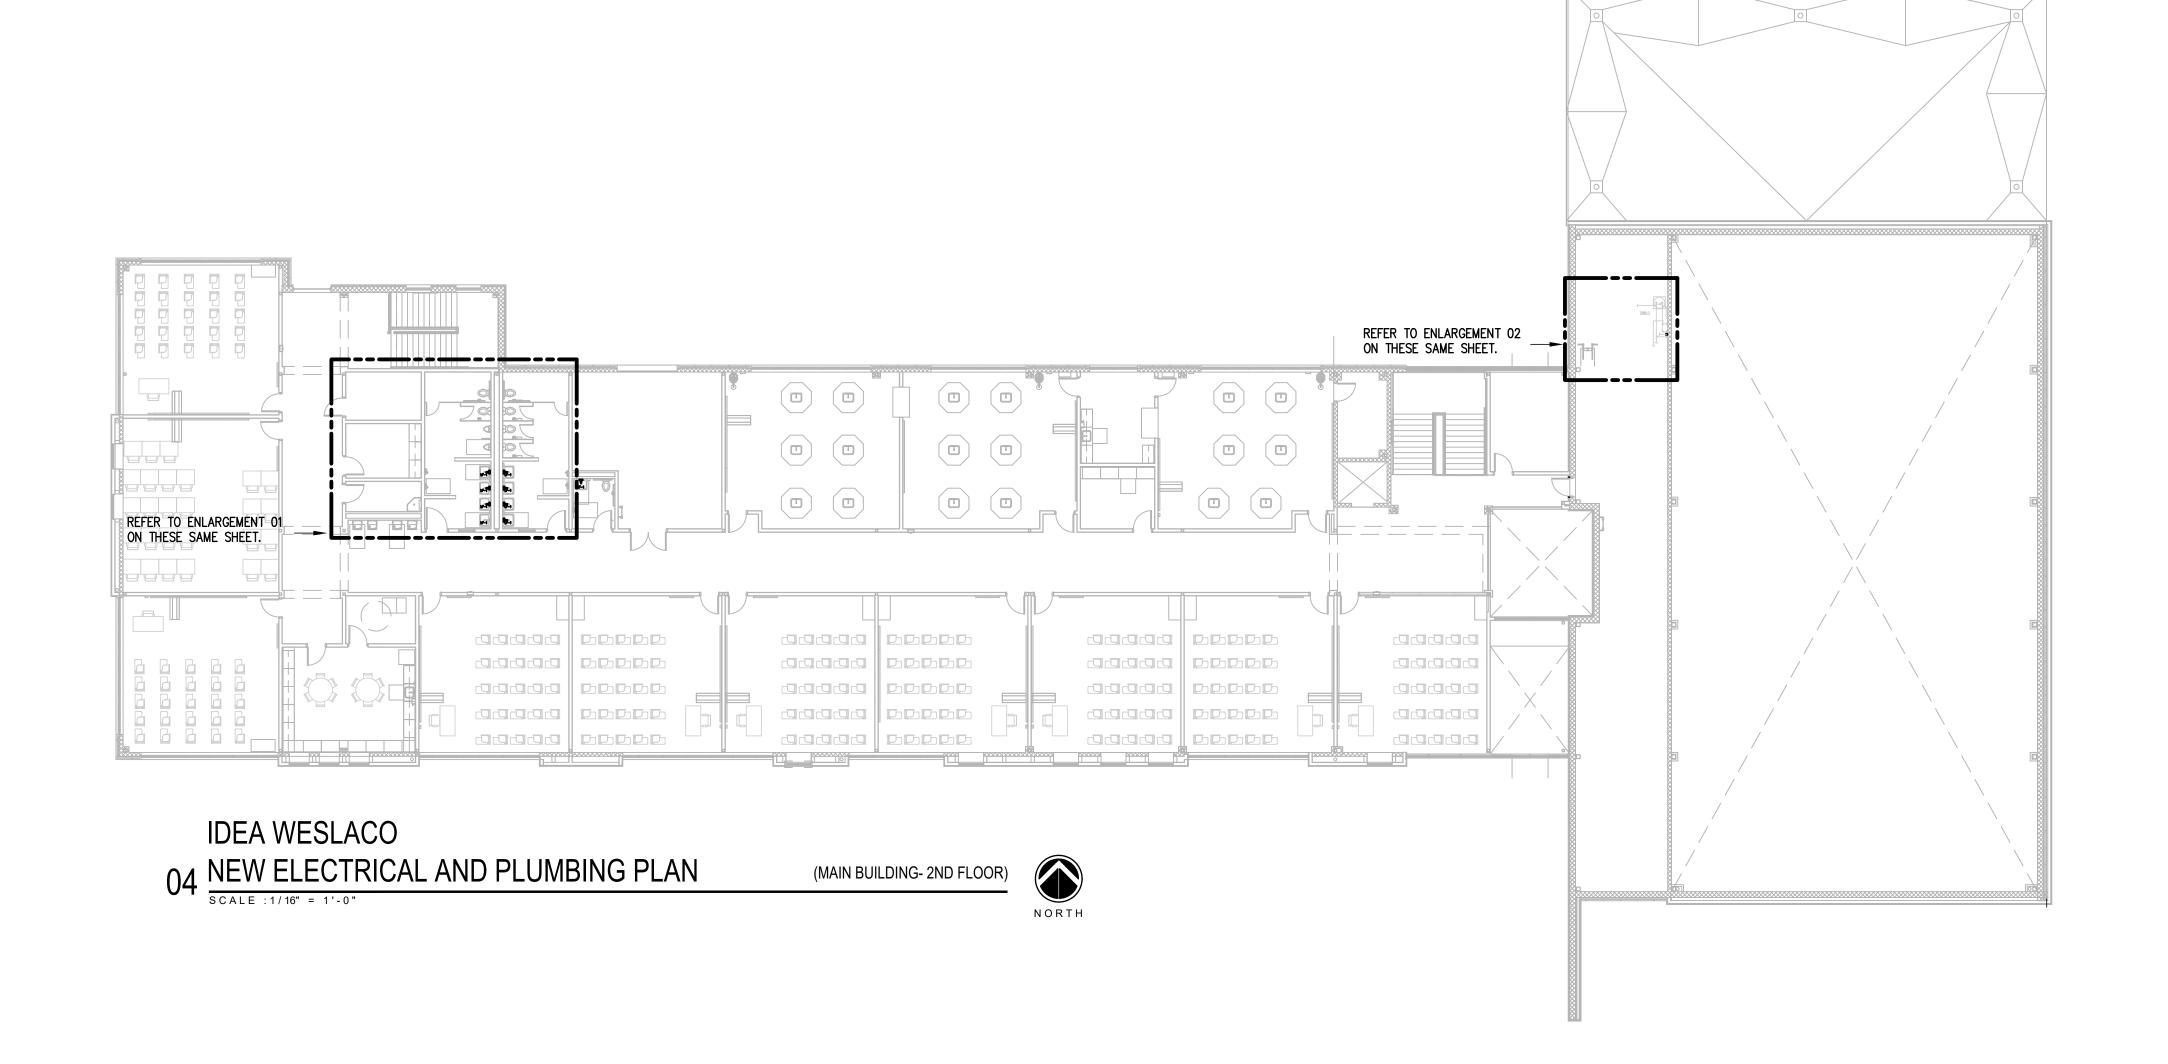

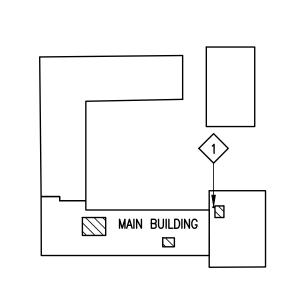

WESLACO IDEA ACADEMY **KEYPLAN**



1126 SOUTH COMMERCE ST. HARLINGEN, TX PHONE: 956-230-3435 TEXAS REGISTERED ENGINEERING FIRM F-15998 APRIL 19, 20 CHECKED BY: DRAWN BY:

PROJECT NO.: P7.04

eng	OS gineering
HARLIN PHONE: 9 TEXAS RE ENGINEE	COMMERCE ST. NGEN, TX 56-230-3435 EGISTERED ERING FIRM 5998
DATE:	APRIL 19, 20
CHECKED BY	′: C.A.(

DATE:	APRIL 19, 2024
CHECKED BY	<u>': C.A.G.</u>
DRAWN BY:	J.V.
PROJECT NO	.: 23v82
CAD FILE:	_

SHEET: P7.05

Project: IDEA PS PLUMBING UPGRADES AT LOWER RGV CAMPUSES										
	MANUFACTURER &			CO						
MARK	MODEL NUMBER	DESCRIPTION	WASTE	VENT	CW	HW	NOTES	REMARKS		
LF-1	#EBF-615-4-BAT-BDM-CP-0.50GPM- MLM-FCT	SINGLE HOLE, BATTERY POWER SUPPLY, 0.35 GPM, MULTI-LAMINAR SPRAY, INFRA RED SENSOR, POLISHED CHROME FAUCET WITH 4" TRIM PLATE.	-	-	1/2"	1/2"	-	-		
TMV-1	BRADLEY S59-2025 (TMV25)	LEAD-FREE BRASS DESIGN , RELIABLE LIQUID-FILLED THERMOSTAT, INTEGRAL STRAINER CHECKSTOPS ON INLETS STANDARD MIXING VALVES. SET AT 100 FAHRENHET DEGREES.		-	3/4"	3/4"	-	-		

CIRCULATIN	CIRCULATING PUMP SCHEDULE												
Project: IDEA PS PLU	oject: IDEA PS PLUMBING UPGRADES AT LOWER RGV CAMPUSES												
MARK	ТҮРЕ	SERVES	LOCATION	GPM	HEAD	MIN.	RPM	SUCTION	IMPELLER	ELEC.	WEIGHT	NOTES	MANUFACTURER
WALKIX				OI IVI	FT WG	HP		DIA. (IN.)	DIA. (IN.)	V-PH-HZ	(LBS)	NOTES	AND MODEL
CP-1	CIRCULATING	E\\/\L_1	SEE PLAN	-	20	1/12	3300	15	2	115-1-60	13	ALL	BELL & GOSSETT
CF-1	PUMP EWH-1 SE	SEE PLAIN 5		20 1/1	1/12	3300	1.5		113-1-00	13	ALL	PL-30B	

NOTES: PROVIDE BRONZE BOOSTER BODY.

NOT USED

REFER TO DETAIL SHEET FOR MORE INFORMATION.

