
## TEXAS REGISTERED **ENGINEERING FIRM** F-15998 APRIL 19, 20 PROJECT NO.:

COVER

# IDEA PUBLIC SCHOOLS

# PLUMBING UPGRADES AT LOWER RGV CAMPUSES RFP# 27-LRPU-0424

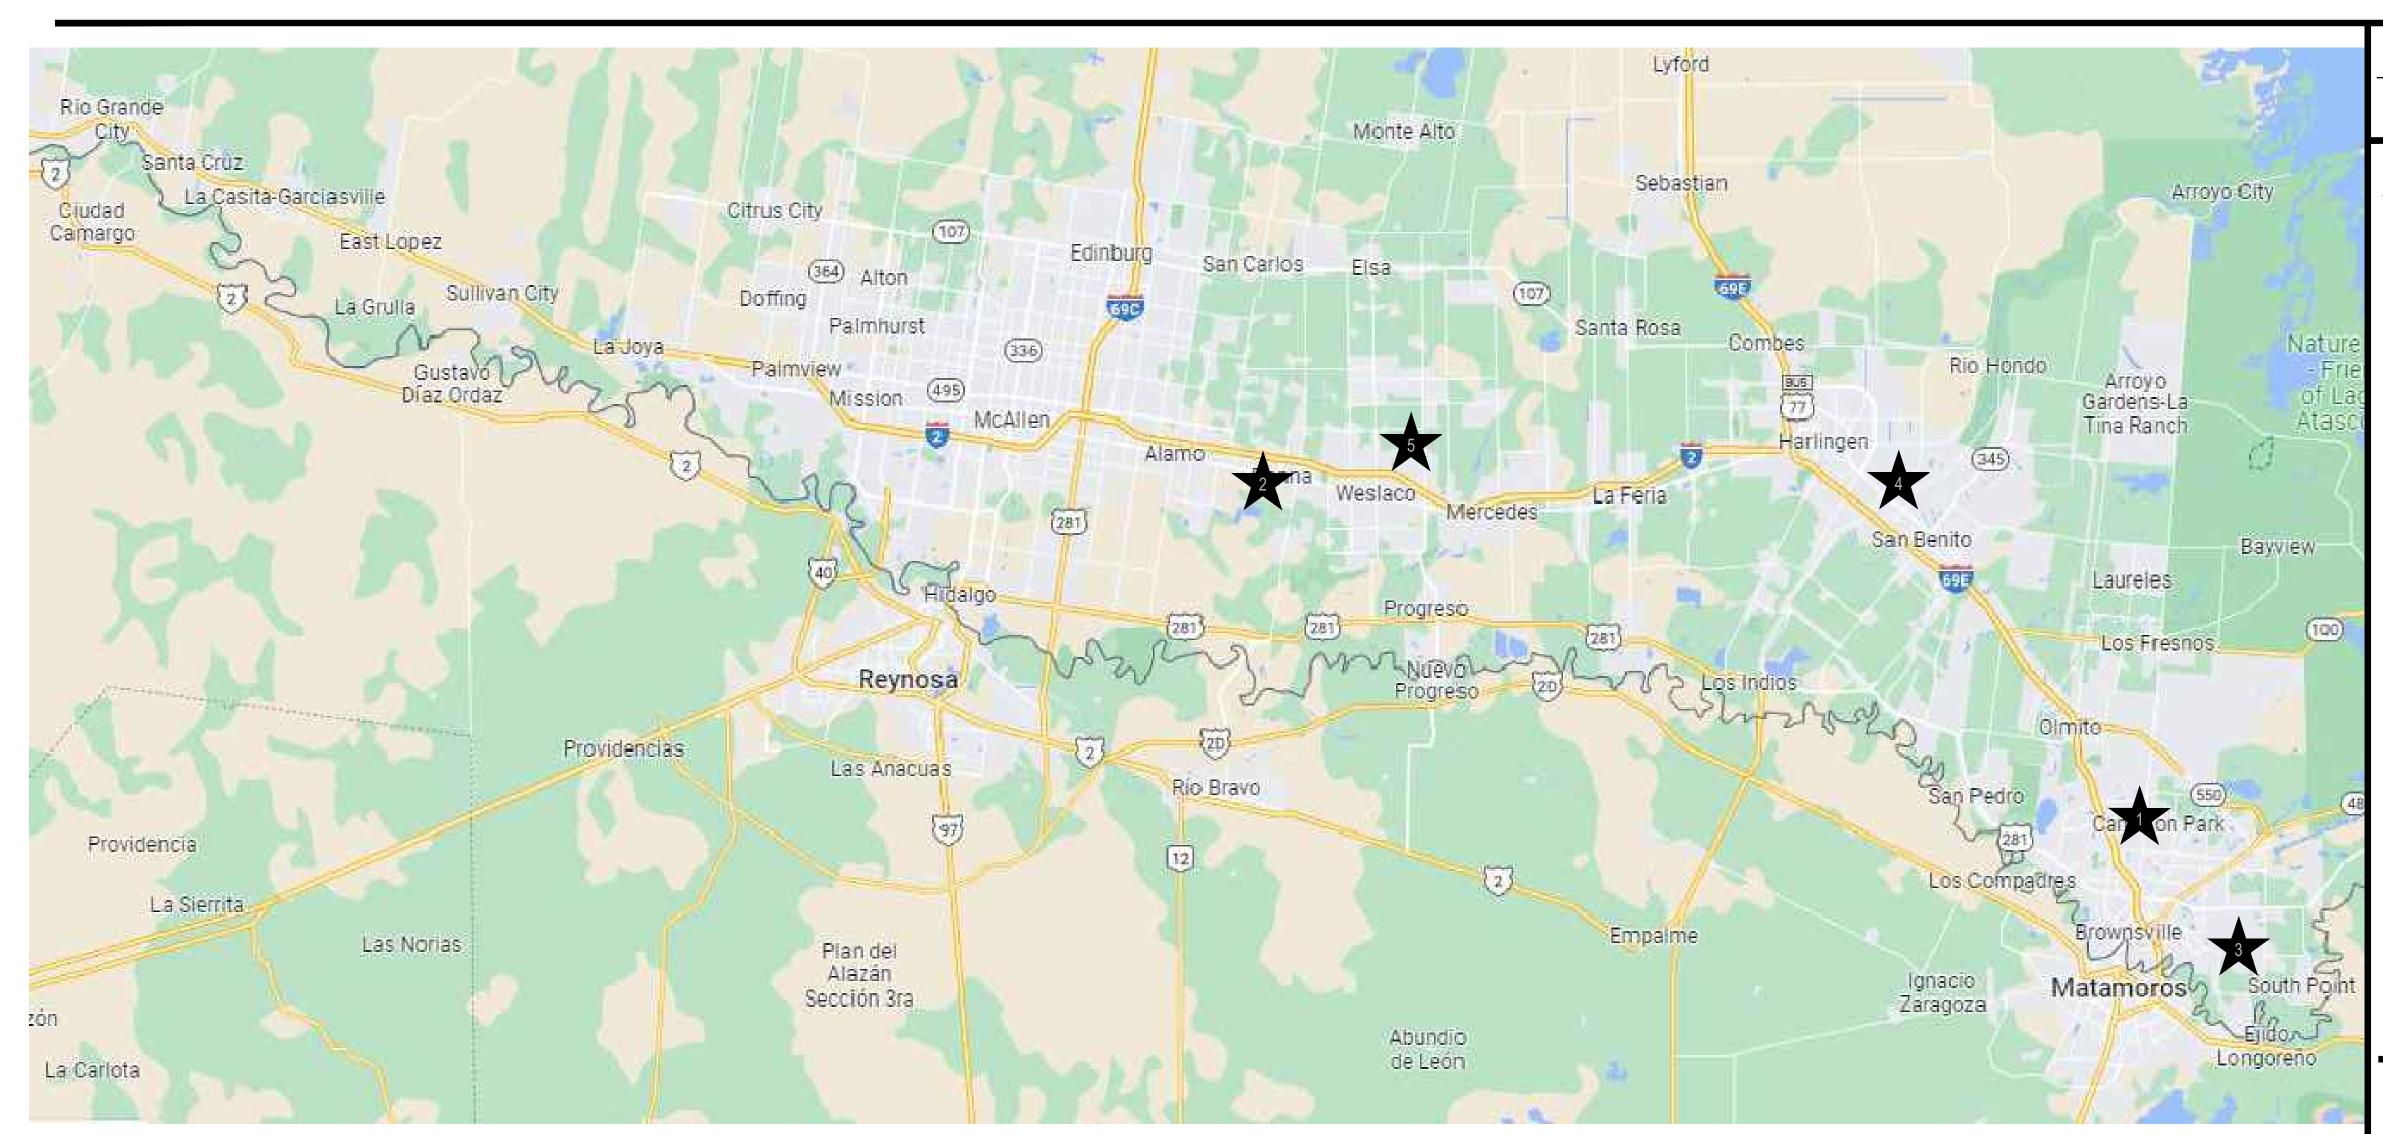

## VICINITY MAP - RIO GRANDE VALLEY



## SCHOOL LIST:

- IDEA BROWNSVILLE 4395 PAREDES LINE RD., BROWNSVILLE, TX
- 2. IDEA DONNA 401 S. 1ST, DONNA, TX
- 5. IDEA FRONTIER 2800 DAKOTA AVE., BROWNSVILLE, TX
- 2151 RUSSELL LN, SAN BENITO, TX
- 5. IDEA WESLACO E SUGARCANE DR. WESLACO, TX

## RIO GRANDE VALLEY REGIONAL BOARD

MARIA ANTONIA CHAPA ANDREA RODRIGUEZ CERISE R. DE GARDUNO ALYSSA L. ROMERO, BOARD CHAIR **BOBBY SAENZ** SARAH GARZA ZULIEDA LOPEZ-HABBOUCHE CJ SANCHEZ

JESUS (JESSE) ZEPEDA

## EXECUTIVE COMMITTEE

| COLLIN SEWELL  | CHAIR      |
|----------------|------------|
| ED RIVERA      | VICE-CHAIR |
| ERICH HOLMSTEN | TREASURER  |
| RYAN VAUGHAN   | SECRETARY  |

## DATE OF ISSUE APRIL 19, 2024

## LIST OF DRAWINGS

| •  |   |        |  |
|----|---|--------|--|
| R. | COVER SHEET                                 | P5.10  | RENOVATION PLUMBING PLAN "FRONTIER PORTABLE BUILDING".           |
| 1  | RENOVATION PLUMBING PLAN "BROWNSVILLE       |        | TOTAL BOLDING .  |
|    | BUILDING A - 1ST AND 2ND FLOOR".            | P5.11  | PLUMBING FIXTURES SCHEDULES AND FIXTURES IMAGES.                 |
| 2  | RENOVATION PLUMBING PLAN "BROWNSVILLE       |        |  |
|    | BUILDING B - 1ST AND 2ND FLOOR".            | P6.01  | DEMOLITION AND RENOVATION PLUMBING PLAN "SAN BENITO BUILDING A". |
| 3  | RENOVATION PLUMBING PLAN "BROWNSVILLE       | P6.02  | DEMOLITION AND RENOVATION PLUMBING PLAN                          |
|    | BUILDING C".                                | 1 0.02 | "SAN BENITO BUILDING B".   |
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|    | BUILDING D — 1ST AND 2ND FLOOR".            | P6.03  | RENOVATION PLUMBING PLAN "SAN BENITO CAFETORIUM BUILDING".       |
| 1  | PLUMBING FIXTURES SCHEDULES AND FIXTURES    |        | of a Electronic Bollbarto .                                      |
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| 4  | DENOVATION DILIMBING DIAN "DONNA CITE       |        | BUILDING D".   |
| ı  | RENOVATION PLUMBING PLAN "DONNA SITE PLAN". | P6.05  | PLUMBING FIXTURES SCHEDULES AND FIXTURES IMAGES.                 |
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| _  | PLAN".                                      | P7.01  | DEMOLITION PLUMBING PLAN "WESLACO MAIN BUILDING 1ST FLOOR".      |

- "FRONTIER BUILDING D".
- P5.05 RENOVATION PLUMBING PLAN "FRONTIER BUILDING E".
- P5.06 DEMOLITION PLUMBING PLAN "FRONTIER BUILDING F". P5.07 RENOVATION PLUMBING PLAN "FRONTIER
- P5.08 RENOVATION PLUMBING PLAN "FRONTIER BUILDING G".

P5.09 RENOVATION PLUMBING PLAN "FRONTIER

BUILDING H".

# SCOPE OF WORK

- WORK INCLUDES REPLACEMENT OF PLUMBING PIPING, WATER HEATERS, DRINKING FOUNTAINS, CONDENSATE DRAIN LINES, HOSE BIBS, ETC. COORDINATE WITH NEW WORK AND RETAIN EXISTING PLUMBING LINES THAT ARE TO BE REUSED.
  SEAL UNUSED OPENINGS IN FLOORS, ROOFS, AND WALLS, AS INDICATED IN THE DRAWINGS.

  - INSULATED, COPPER, CONDENSATE DRAIN PIPING.

## BOARD OF DIRECTORS

| DOTTIND OF DITTED TOTTO |  |
|-------------------------|--|
| MICHAEL ADAMS           |  |
| GARY LINDGREN           | MEMBER                                 |
| THERESA BARRERA -SHAW   | ······································ |
| NANETTE COCERO          | MEMBER                                 |
| DR. JEFF COTTRILL       | CEO AND SUPERINTENDENT                 |
| CODY GRINDLE            | PRESIDENT                              |
| DR. ERNIE CANTU         | CHIEF SCHOOLS OFFICER                  |

COPY NO:

CSP # 27-LRPU-0424

CESAR A. GONZALEZ

04.19.2023



NORTH STAIR

CLASSROOM

NORTH STAIR
A106

CLASSROOM
A214

CLASSROOM A212

CLASSROOM
A215

<u>₩H=1</u>

CLASSROOM A107

CLASSROOM A146

CLASSROOM A109

MECH
A138

PEIMS A135

CORRIDOR
A136

CLASSROOM A210

CLASSROOM

CLASSROOM
A211

A108

∨ **2** 

BV 2

2

MECHANICAL
A203

0

0

CORRIDOR
A204

<u>WH−2</u> 1

1 <u>wH-1</u>

CLASSROOM
A117

CORRIDOR A103

CLASSROOM A123

(BUILDING A- 1ST FLOOR)

CLASSROOM A201

CLASSROOM A226

(BUILDING A- 2ND FLOOR)
NORTH

CLASSROOM A202

**2** 

WORK ROOM
A225

2

SOUTH STAIR

2

CLASSROOM A122

IDEA BROWNSVILLE

01 PLUMBING PLAN

SCALE : 3/32" = 1'-0"

SOUTH STAIR
A119

CLASSROOM A227

IDEA BROWNSVILLE

02 PLUMBING PLAN
SCALE:3/32" = 1'-0"

1 WH-1

CLASSROOM A118


- 1. PLUMBING CONTRACTOR SHALL ISOLATE DOMESTIC COLD WATER SYSTEM AT THE WORKING AREAS PRIOR ANY WORK BEING DONE.
- 2. FOR ALL WALL HYDRANTS BEING REPLACED, CONTRACTOR SHALL RETAIN EXISTING BOX/ENCLOSURE AND SHALL REPLACE ALL INTERNAL COMPONENTS. IT WILL BE CONTRACTOR RESPONSIBILITY TO PROVIDE AN EQUAL/SIMILAR HYDRANT TO FIT INTO EXISTING BOX/ENCLOSURE.
- 3. PLUMBING CONTRACTOR SHALL PERFORM ALL WORK CAREFULLY TO NOT DAMAGE BUILDING FACADE/STRUCTURE.

## PLUMBING KEYED NOTES:

| PLU      | MBING LEGEND                |
|----------|-----------------------------|
| <b>—</b> | WALL HYDRANT TO BE REPLACED |

## 1 REMOVE AND REPLACE WALL HYDRANT AT THIS APPROXIMATE LOCATION. SEE SCHEDULE ON SHEET P3.01. 2 APPROXIMATE LOCATION OF EXISTING ISOLATION VALVE. FIELD VERIFY EXACT LOCATION.



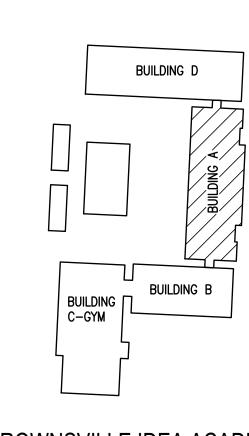





1126 SOUTH COMMERCE ST. HARLINGEN, TX PHONE: 956-230-3435 TEXAS REGISTERED ENGINEERING FIRM F-15998

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P2.01

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PROJECT NO.:

COPY NO:

CSP # 27-LRPU-0424

**GENERAL NOTES:** 

1. PLUMBING CONTRACTOR SHALL ISOLATE DOMESTIC COLD WATER SYSTEM AT THE WORKING AREAS PRIOR ANY WORK BEING DONE.

COMPONENTS.' IT WILL BE CONTRACTOR RESPONSIBILITY TO PROVIDE AN

3. PLUMBING CONTRACTOR SHALL PERFORM ALL WORK CAREFULLY TO NOT DAMAGE BUILDING FACADE/STRUCTURE.

2. FOR ALL WALL HYDRANTS BEING REPLACED, CONTRACTOR SHALL RETAIN EXISTING BOX/ENCLOSURE AND SHALL REPLACE ALL INTERNAL

EQUAL/SIMILAR HYDRANT TO FIT INTO EXISTING BOX/ENCLOSURE.

PLUMBING KEYED NOTES:

1 REMOVE AND REPLACE WALL HYDRANT AT THIS APPROXIMATE LOCATION. SEE SCHEDULE ON SHEET P3.01.

2 APPROXIMATE LOCATION OF EXISTING ISOLATION VALVE. FIELD VERIFY EXACT LOCATION.

PLUMBING LEGEND

WALL HYDRANT TO BE REPLACED






P2.02

**BROWNSVILLE IDEA ACADEMY** KEYPLAN

BUILDING C-GYM

BUILDING D

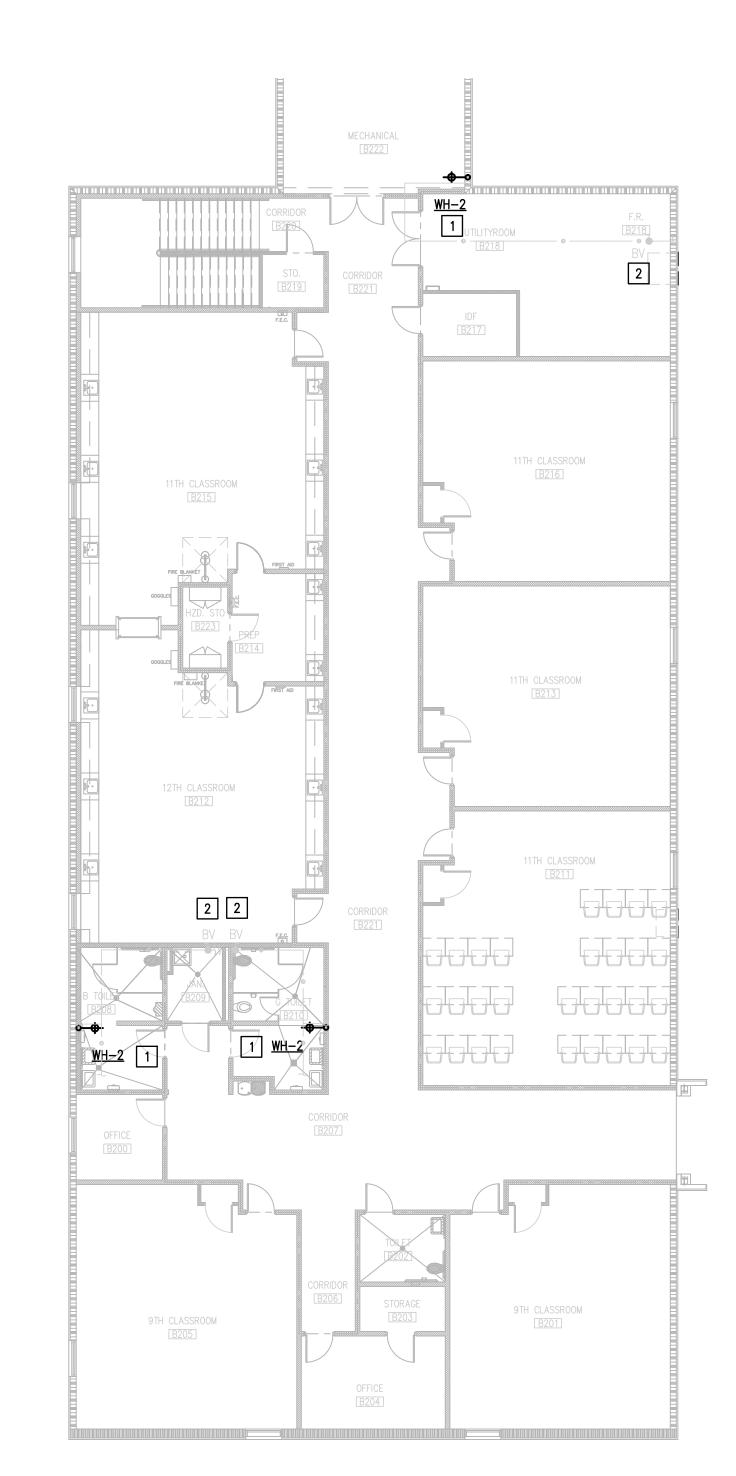



8TH ENGLISH
B104

10TH CLASSROOM
B115

8th CLASSROOM


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₩H-2

<u>WH-1</u>

9TH MATH

LIKESKILLS
B101

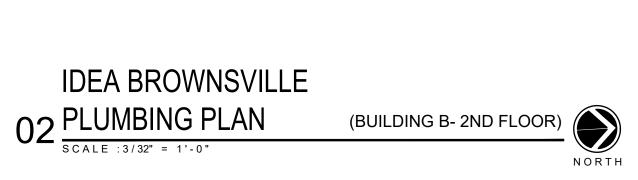

COPY NO:

CSP # 27-LRPU-0424

CESAR A. GONZALEZ




PROJECT NO.:

P2.03



BUILDING

BUILDING D

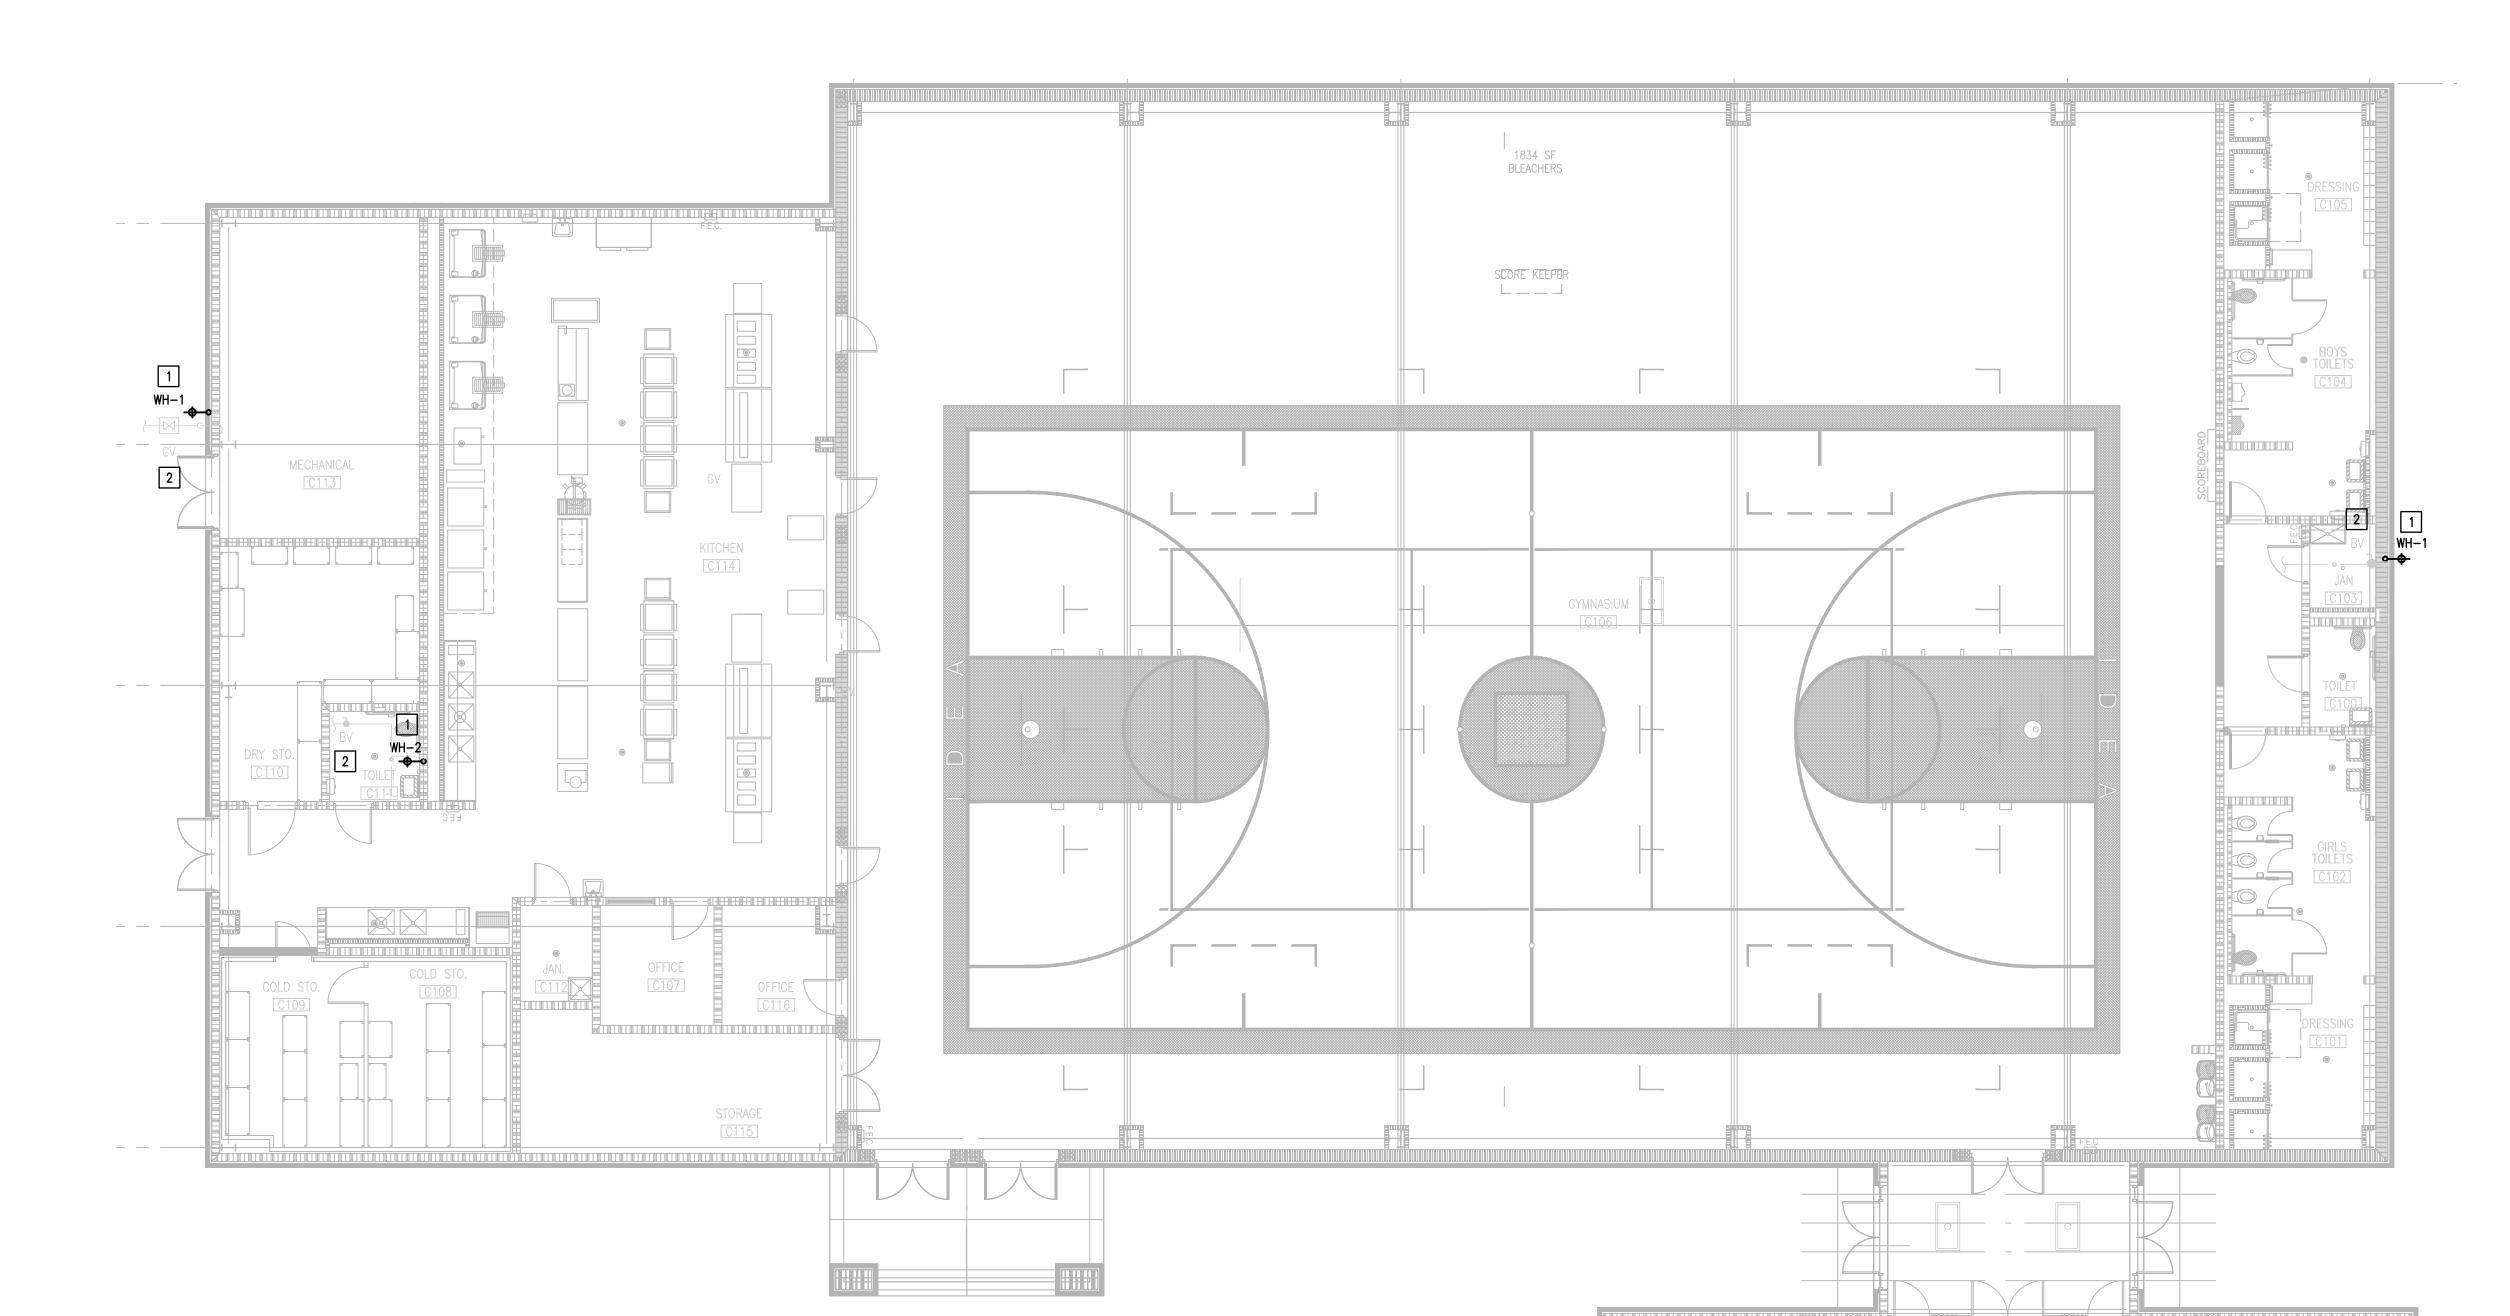

IDEA BROWNSVILLE

(BUILDING C- GYM)
NORTH

01 PLUMBING PLAN
SCALE:1/8" = 1'-0"

## **GENERAL NOTES:**

- PLUMBING CONTRACTOR SHALL ISOLATE DOMESTIC COLD WATER SYSTEM AT THE WORKING AREAS PRIOR ANY WORK BEING DONE.
- 2. FOR ALL WALL HYDRANTS BEING REPLACED, CONTRACTOR SHALL RETAIN EXISTING BOX/ENCLOSURE AND SHALL REPLACE ALL INTERNAL COMPONENTS. IT WILL BE CONTRACTOR RESPONSIBILITY TO PROVIDE AN EQUAL/SIMILAR HYDRANT TO FIT INTO EXISTING BOX/ENCLOSURE.
- 3. PLUMBING CONTRACTOR SHALL PERFORM ALL WORK CAREFULLY TO NOT DAMAGE BUILDING FACADE/STRUCTURE.

## PLUMBING KEYED NOTES:

- 1 REMOVE AND REPLACE WALL HYDRANT AT THIS APPROXIMATE LOCATION. SEE SCHEDULE ON SHEET P3.01.
- 2 APPROXIMATE LOCATION OF EXISTING ISOLATION VALVE. FIELD VERIFY EXACT LOCATION.

| 。PLU         | MBING LEGEND                |
|--------------|-----------------------------|
| <del> </del> | WALL HYDRANT TO BE REPLACED |



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CSP # 27-LRPU-0424

CESAR A. GONZALEZ

04.19.2023

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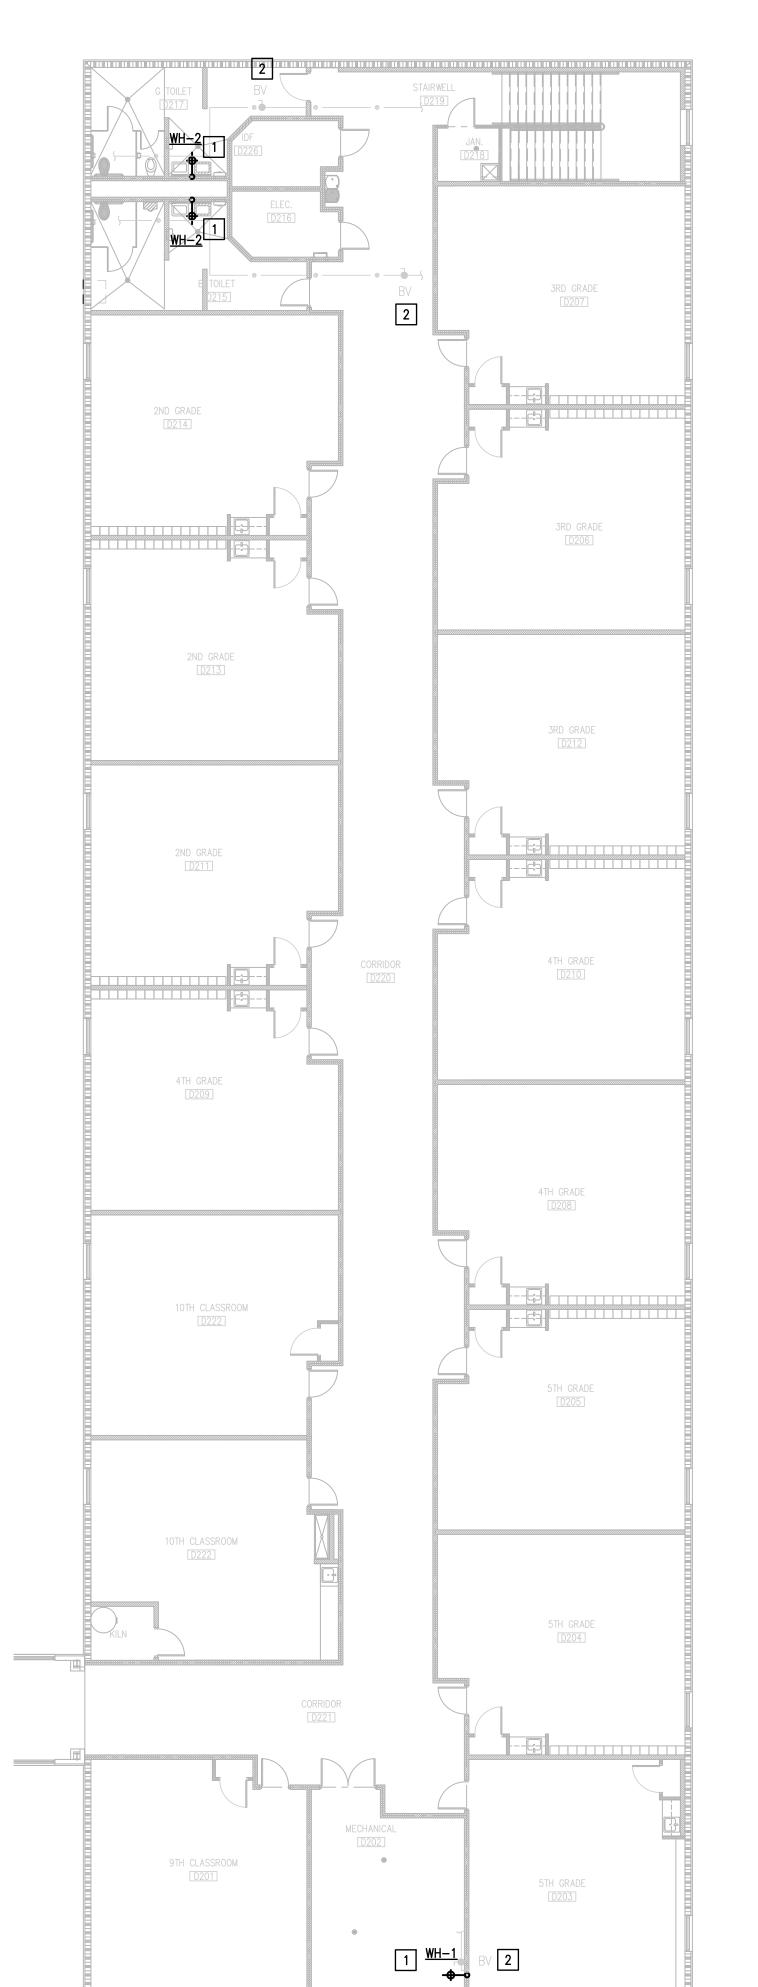
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SHEET:
P2.04

BROWNSVILLE IDEA ACADEMY KEYPLAN

BUILDING C-GYM

BÚILDING D

BUILDING B



IDEA BROWNSVILLE

02 PLUMBING PLAN
SCALE:3/32" = 1'-0" (BUILDING D- 2ND FLOOR)

PRIMARY SPEDS <u>WH-1</u> KINDERGARTEN
D107 KINDERGARTEN D108 KINDERGARTEN
D104 KINDERGARTEN
D101

WORKROOM D103

<u>WH-1</u>

<u>₩H-2</u>

WH-2

IDEA BROWNSVILLE 01 PLUMBING PLAN
SCALE:3/32" = 1'-0"

(BUILDING D- 1ST FLOOR)

**GENERAL NOTES:** 

1. PLUMBING CONTRACTOR SHALL ISOLATE DOMESTIC COLD WATER SYSTEM AT THE WORKING AREAS PRIOR ANY WORK BEING DONE.

2. FOR ALL WALL HYDRANTS BEING REPLACED, CONTRACTOR SHALL RETAIN EXISTING BOX/ENCLOSURE AND SHALL REPLACE ALL INTERNAL COMPONENTS. IT WILL BE CONTRACTOR RESPONSIBILITY TO PROVIDE AN EQUAL/SIMILAR HYDRANT TO FIT INTO EXISTING BOX/ENCLOSURE.

3. PLUMBING CONTRACTOR SHALL PERFORM ALL WORK CAREFULLY TO NOT DAMAGE BUILDING FACADE/STRUCTURE.


## PLUMBING KEYED NOTES:

1 REMOVE AND REPLACE WALL HYDRANT AT THIS APPROXIMATE LOCATION. SEE SCHEDULE ON SHEET P3.01.

2 APPROXIMATE LOCATION OF EXISTING ISOLATION VALVE. FIELD VERIFY EXACT LOCATION.

| 。PLU         | MBING LEGEND                |
|--------------|-----------------------------|
| <del>-</del> | WALL HYDRANT TO BE REPLACED |



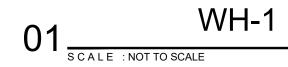



 $02 \frac{\text{WH-2}}{\text{SCALE : NOT TO SCALE}}$ 

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IDEA PUBLIC SCHOOLS OWER RGV PLUMBING UPGRADES

IO GRANDRE VALLEY



## **GENERAL NOTES:**

- 1. PLUMBING CONTRACTOR SHALL ISOLATE DOMESTIC COLD WATER SYSTEM AT THE WORKING AREAS PRIOR ANY WORK BEING DONE.
- 2. FOR ALL WALL HYDRANTS BEING REPLACED, CONTRACTOR SHALL RETAIN EXISTING BOX/ENCLOSURE AND SHALL REPLACE ALL INTERNAL COMPONENTS. IT WILL BE CONTRACTOR RESPONSIBILITY TO PROVIDE AN EQUAL/SIMILAR HYDRANT TO FIT INTO EXISTING BOX/ENCLOSURE.
- 3. PLUMBING CONTRACTOR SHALL PERFORM ALL WORK CAREFULLY TO NOT DAMAGE BUILDING FACADE/STRUCTURE.

## PLUMBING KEYED NOTES:

1 REMOVE AND REPLACE WALL HYDRANT AT THIS APPROXIMATE LOCATION. SEE SCHEDULE ON SHEET P4.03.

| PLUMBING LEGEND |                             |  |
|-----------------|-----------------------------|--|
| <b>○ ◆</b>      | WALL HYDRANT TO BE REPLACED |  |

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**100** UMBING PUB 겁 RGV IDE/ LOWER

PAVILLION

ELEMENTARY BLDG.

DONNA IDEA ACADEMY

KEYPLAN

PRIMARY BLDG.

10TH BLDG.

9TH BLDG.

CAFE/GYM

1126 SOUTH COMMERCE ST. HARLINGEN, TX PHONE: 956-230-3435 TEXAS REGISTERED ENGINEERING FIRM F-15998

APRIL 19, 202 CHECKED BY: C.A.G. DRAWN BY:

PROJECT NO.: 23v82

P4.01

**♦** WH−1

10th BLDG

01 IDEA DONNA - SITE PLAN

SCALE:3/32" = 1'-0"

9th BLDG



## **GENERAL NOTES:**

 PLUMBING CONTRACTOR SHALL ISOLATE DOMESTIC COLD WATER SYSTEM AT THE WORKING AREAS PRIOR ANY WORK BEING DONE.


 FOR ALL WALL HYDRANTS BEING REPLACED, CONTRACTOR SHALL RETAIN EXISTING BOX/ENCLOSURE AND SHALL REPLACE ALL INTERNAL COMPONENTS. IT WILL BE CONTRACTOR RESPONSIBILITY TO PROVIDE AN EQUAL/SIMILAR HYDRANT TO FIT INTO EXISTING BOX/ENCLOSURE.

 PLUMBING CONTRACTOR SHALL PERFORM ALL WORK CAREFULLY TO NOT DAMAGE BUILDING FACADE/STRUCTURE.

## PLUMBING KEYED NOTES:

1 REMOVE AND REPLACE WALL HYDRANT AT THIS APPROXIMATE LOCATION. SEE SCHEDULE ON SHEET P4.03.

| PLUMBING LEGEND |                             |  |
|-----------------|-----------------------------|--|
| о <del></del>   | WALL HYDRANT TO BE REPLACED |  |

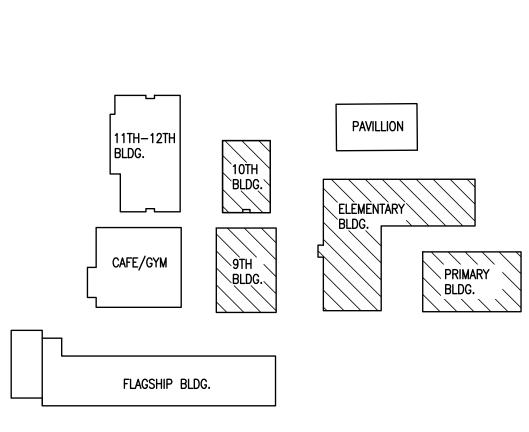

DONNA IDEA ACADEMY KEYPLAN

NO: REVISION: BY:

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IDEA PUBLIC SCHOOLS LOWER RGV PLUMBING UPGRAI

O GRANDRE VALLE

engineering

1126 SOUTH COMMERCE ST.
HARLINGEN, TX
PHONE: 956-230-3435
TEXAS REGISTERED
ENGINEERING FIRM
F-15998

DATE: APRIL 19, 20

CHECKED BY: C.A.

DRAWN BY: J.

CHECKED BY: C.A.G.

DRAWN BY: J.V.

PROJECT NO.: 23v82

CAD FILE:

CAD FILE: SHEET: P4.02







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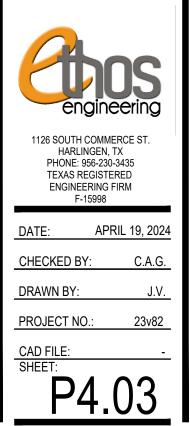
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IDEA PUBLIC SCHOOLS OWER RGV PLUMBING UPGRADES

RIO GRANDRE VALLE



COPY NO:

CSP # 27-LRPU-0424

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P5.01

**GENERAL NOTES:** 

1. PLUMBING CONTRACTOR SHALL ISOLATE DOMESTIC COLD WATER SYSTEM AT THE WORKING AREAS PRIOR ANY WORK BEING DONE.

2. FOR ALL WALL HYDRANTS BEING REPLACED, CONTRACTOR SHALL RETAIN EXISTING BOX/ENCLOSURE AND SHALL REPLACE ALL INTERNAL COMPONENTS. IT WILL BE CONTRACTOR RESPONSIBILITY TO PROVIDE AN EQUAL/SIMILAR HYDRANT TO FIT INTO EXISTING BOX/ENCLOSURE.

3. PLUMBING CONTRACTOR SHALL PERFORM ALL WORK CAREFULLY TO NOT DAMAGE BUILDING FACADE/STRUCTURE.

## **DEMOLITION ELECTRICAL KEYED NOTES:**

APPROXIMATE LOCATION OF EXISTING PANELBOARD SERVING ELECTRIC WATER HEATER.

- APPROXIMATE LOCATION OF EXISTING PANELBOARD SERVING ELECTRIC WATER
- 2 CONNECT NEW ELECTRIC WATER HEATER. RETAIN AND REUSE EXISTING BRANCH CIRCUIT. IF EXISTING BRANCH CIRCUIT DOES NOT REACH NEW POINT OF CONNECTION PROVIDE A J-BOX AND EXTEND WIRING AS NECESSARY.

- 2) DISCONNECT EXISTING ELECTRIC WATER HEATER FOR INSTALLATION OF NEW ELECTRIC WATER HEATER. RETAIN AND REUSE EXISTING BRANCH CIRCUIT.

### **ELECTRICAL NEW KEYED NOTES:**

### **DEMOLITION GENERAL NOTES:**

- 1. ALL DEMOLITION WORK SHALL BE DONE IN ACCORDANCE WITH ALL APPLICABLE CODES INCLUDING THOSE PUBLISHED BY OSHA.
- 2. A VISIT TO THE SITE IS REQUIRED TO PROPERLY BID THE DEMOLITION PLUMBING WORK. ALL INFORMATION SHOWN ON THE EXISTING CONSTRUCTION WILL BE REFERENCE ONLY AND WILL NEED TO BE FIELD VERIFIED BY THE CONTRACTOR.
- 3. PROVIDE ALL DEMOLITION WORK REQUIRED FOR THE REMOVAL OF EXISTING NON REUSED PLUMBING EQUIPMENT AND ASSOCIATED DEVICES. PROVIDE A COMPLETE AND OPERABLE SYSTEM UPON COMPLETION OF THE PROJECT.
- 4. COORDINATE DEMOLITION OF DIVISION 22 SYSTEM AS REQUIRED WITH ALL OTHER TRADES.
- 5. ALL EXISTING EQUIPMENT AND MATERIALS REMOVED DURING CONSTRUCTION, THAT IS NOT TO BE REUSED, SHALL BE REMOVED FROM THE JOB SITE AND PROPERLY RETURNED TO THE OWNER, IF DESIRED BY
- COORDINATE WITH OWNER, AND DISPOSE OF EQUIPMENT AND MATERIALS THAT OWNER DOES NOT REMAIN.
- PREPARE AREA FOR INSTALLATION OF NEW PLUMBING SYSTEMS. REFER TO NEW PLANS AND COORDINATE WITH DEMOLITION WORK.

## **DEMOLITION** PLUMBING KEYED NOTES:

- 1 DEMOLISH EXISTING ELECTRIC WATER HEATER AT THIS APPROXIMATE LOCATION.
- 2 DEMOLISH EXISTING DRINKING FOUNTAINS AT THIS APPROXIMATE LOCATION.
- 3 ISOLATE AND DISCONNECT EXISTING COLD AND HOT WATER PIPES SERVING PLUMBING FIXTURE AT THIS APPROXIMATE LOCATION. CONNECT AFTER REPLACING.
- 4 DEMOLISH EXISTING PLUMBING FIXTURES MARKED ON PLANS.
- 5 PREPARE AREA FOR INSTALLATION OF NEW PLUMBING FIXTURES. COORDINATE WITH DEMOLITION.

### PLUMBING KEYED NOTES:

- 1 REMOVE AND REPLACE WALL HYDRANT AT THIS APPROXIMATE LOCATION. SEE SCHEDULE ON SHEET P5.11.
- 2) PROVIDE NEW ELECTRIC WATER HEATER EWH-1 AS PER SCHEDULE UNDER SCHEDULE SHEET P5.11 OR AN APPROVED EQUAL. ADJUST PLUMBING LINES AND FITTINGS TO THE NEW PLUMBING FIXTURE AS NECESSARY. REFER TO DETAIL ON DETAIL SHEET P5.11.
- 3 PROVIDE NEW DRINKING FOUNTAINS EDF-1&2 WITH NEW ONE INDICATED ON THE SCHEDULES. SEE P5.11 ADJUST PLUMBING LINES AND FITTINGS TO THE NEW PLUMBING FIXTURE AS NECESSARY AND REPAIR WALL TO MATCH EXISTING CONDITIONS IF NECESSARY.
- 4 APPROXIMATE LOCATION OF EXISTING ISOLATION VALVE. FIELD VERIFY EXACT LOCATION.

|                                       | PLUMBING LEGEND |  |  |
|---------------------------------------|-----------------|--|--|
| — — TO BE DEMOLISHED                  |                 |  |  |
| ○──────────────────────────────────── |                 |  |  |

# BUILDING "A" BUILDING "E" BUILDING "D" BUILDING "B" BUILDING "C" BUILDING "G" BUILDING "H"

FRONTIER IDEA ACADEMY **KEYPLAN** 



01 DEMOLITION ELECTRICAL AND PLUMBING PLAN

F.E.C.

**IDEA FRONTIER** 

SCALE :3/32" = 1'-0"

1LA

(BUILDING A)

NORTH

NORTH

(BUILDING A)

PLUMBING WORK. ALL INFORMATION SHOWN ON THE EXISTING CONSTRUCTION WILL BE REFERENCE ONLY AND WILL NEED TO BE FIELD VERIFIED BY THE CONTRACTOR. PROVIDE ALL DEMOLITION WORK REQUIRED FOR THE REMOVAL OF EXISTING NON REUSED PLUMBING EQUIPMENT AND ASSOCIATED DEVICES.

THE PROJECT. 4. COORDINATE DEMOLITION OF DIVISION 22 SYSTEM AS REQUIRED WITH ALL

PROVIDE A COMPLETE AND OPERABLE SYSTEM UPON COMPLETION OF

5. ALL EXISTING EQUIPMENT AND MATERIALS REMOVED DURING CONSTRUCTION, THAT IS NOT TO BE REUSED, SHALL BE REMOVED FROM THE JOB SITE AND PROPERLY RETURNED TO THE OWNER, IF DESIRED BY

6. COORDINATE WITH OWNER, AND DISPOSE OF EQUIPMENT AND MATERIALS THAT OWNER DOES NOT REMAIN.

PREPARE AREA FOR INSTALLATION OF NEW PLUMBING SYSTEMS. REFER TO NEW PLANS AND COORDINATE WITH DEMOLITION WORK.

## **GENERAL NOTES:**

OTHER TRADES.

- PLUMBING CONTRACTOR SHALL ISOLATE DOMESTIC COLD WATER SYSTEM AT THE WORKING AREAS PRIOR ANY WORK BEING DONE.
- 2. FOR ALL WALL HYDRANTS BEING REPLACED, CONTRACTOR SHALL RETAIN EXISTING BOX/ENCLOSURE AND SHALL REPLACE ALL INTERNAL COMPONENTS. IT WILL BE CONTRACTOR RESPONSIBILITY TO PROVIDE AN EQUAL/SIMILAR HYDRANT TO FIT INTO EXISTING BOX/ENCLOSURE.
- PLUMBING CONTRACTOR SHALL PERFORM ALL WORK CAREFULLY TO NOT DAMAGE BUILDING FACADE/STRUCTURE.

## **DEMOLITION** PLUMBING KEYED NOTES:

EXISTING CONDENSATE


AND REPLACED

PIPING TO BE REMOVED

- 1 DEMOLISH EXISTING ELECTRIC WATER HEATER AT THIS APPROXIMATE LOCATION.
- 2 DEMOLISH EXISTING CONDENSATE PIPING SERVING HVAC EQUIPMENT AT THIS APPROXIMATE LOCATION.
- 3 ISOLATE AND DISCONNECT EXISTING COLD AND HOT WATER PIPES SERVING PLUMBING FIXTURE AT THIS APPROXIMATE LOCATION. CONNECT AFTER REPLACING.
- 4 DEMOLISH EXISTING PLUMBING FIXTURES MARKED ON PLANS.
- 5 PREPARE AREA FOR INSTALLATION OF NEW PLUMBING FIXTURES. COORDINATE WITH DEMOLITION.

## PLUMBING KEYED NOTES:

- 1 REMOVE AND REPLACE WALL HYDRANT AT THIS APPROXIMATE LOCATION. SEE SCHEDULE ON SHEET P5.11.
- 2 PROVIDE NEW ELECTRIC WATER HEATER EWH-2 AS PER SCHEDULE UNDER SCHEDULE SHEET P5.11 OR AN APPROVED EQUAL. ADJUST PLUMBING LINES AND FITTINGS TO THE NEW PLUMBING FIXTURE AS NECESSARY. REFER TO DETAIL ON DETAIL SHEET P5.11.
- (3) PROVIDE NEW 2" SOFT COPPER PIPING FOR CONDENSATE DRAIN LINE OF EXISTING AIR CONDITIONING UNIT AT THIS APPROXIMATE LOCATION. PROVIDE 1" THICK FLEXIBLE ELECTROMETRIC INSULATION FOR NEW CONDENSATE PIPING AND CONNECT INTO EXISTING HUB DRAIN. NEW CONDENSATE PIPE SHALL BE SIZED AS PER AIR CONDITIONING UNIT MANUFACTURER RECOMMENDATIONS, ENSURE TO NOT PROVIDE A SMALLER PIPE SIZE THAN EXISTING.
- (4) APPROXIMATE LOCATION OF EXISTING ISOLATION VALVE. FIELD VERIFY EXACT LOCATION.

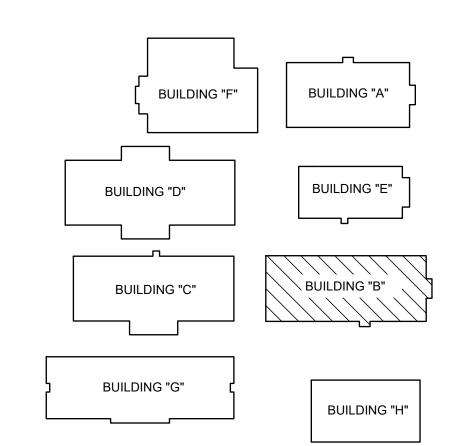

FRONTIER IDEA ACADEMY KEYPLAN

**DEMOLITION GENERAL NOTES:** 

COPY NO: CSP # 27-LRPU-0424

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F-15998 APRIL 19, 202 CHECKED BY: C.A.G.

DRAWN BY: PROJECT NO.:

P5.02

**DEMOLITION ELECTRICAL KEYED NOTES:** 1) APPROXIMATE LOCATION OF EXISTING PANELBOARD SERVING ELECTRIC WATER HEATER.

## **ELECTRICAL NEW KEYED NOTES:**

APPROXIMATE LOCATION OF EXISTING PANELBOARD SERVING ELECTRIC WATER

2) DISCONNECT EXISTING ELECTRIC WATER HEATER FOR INSTALLATION OF NEW


ELECTRIC WATER HEATER. RETAIN AND REUSE EXISTING BRANCH CIRCUIT.

2 CONNECT NEW ELECTRIC WATER HEATER. RETAIN AND REUSE EXISTING BRANCH CIRCUIT. IF EXISTING BRANCH CIRCUIT DOES NOT REACH NEW POINT OF CONNECTION PROVIDE A J-BOX AND EXTEND WIRING AS NECESSARY.

| PL                  | LUMBING LEGEND              |
|---------------------|-----------------------------|
|                     | TO BE DEMOLISHED            |
| <b>0</b> — <b>⊕</b> | WALL HYDRANT TO BE REPLACED |



**IDEA FRONTIER** EXISTING CONDITIONS (BUILDING B - MEZZANINE) 3 S CALE : NOT TO SCALE

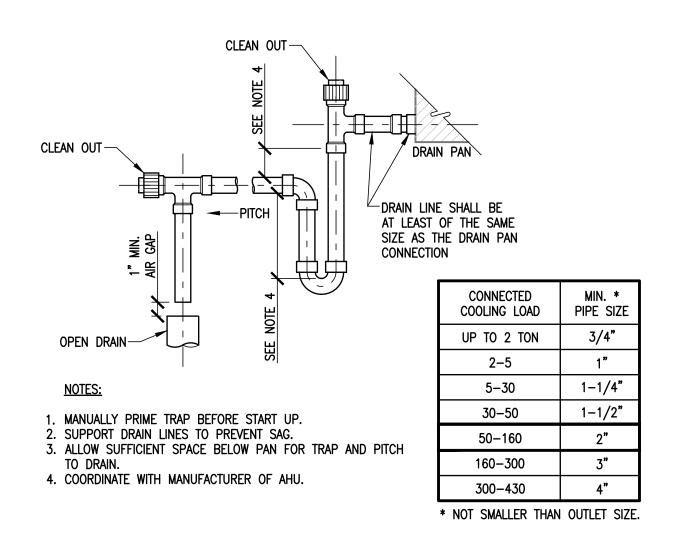

CONDENSATE DRAIN

TRAP PIPE

# REFER TO DETAIL 04 CONDENSATE DRAIN <u>AHU-2</u> TRAP PIPE ON THESE SAME SHEET. (IN MEZZANINE)

(BUILDING B)

NORTH

IDEA FRONTIER 02 NEW ELECTRICAL AND PLUMBING PLAN

**IDEA FRONTIER** 

01 DEMOLITION ELECTRICAL AND PLUMBING PLAN

(BUILDING B)

NORTH

REFER TO 03 EXISTING CONDITIONS

1)LB

ON THESE SAME SHEET.

1126 SOUTH COMMERCE ST. HARLINGEN, TX PHONE: 956-230-3435 TEXAS REGISTERED

**ENGINEERING FIRM** 

CHECKED BY:

PROJECT NO.:

DRAWN BY:

F-15998

P5.03

APRIL 19, 202

NO: REVISION: BY

COPY NO:

CSP # 27-LRPU-0424

\*

CESAR A. GONZALEZ

108611

04.19.2023

1. ALL DEMOLITION WORK SHALL BE DONE IN ACCORDANCE WITH ALL

2. A VISIT TO THE SITE IS REQUIRED TO PROPERLY BID THE DEMOLITION PLUMBING WORK. ALL INFORMATION SHOWN ON THE EXISTING CONSTRUCTION WILL BE REFERENCE ONLY AND WILL NEED TO BE FIELD VERIFIED BY THE CONTRACTOR.

PROVIDE ALL DEMOLITION WORK REQUIRED FOR THE REMOVAL OF EXISTING NON REUSED PLUMBING EQUIPMENT AND ASSOCIATED DEVICES. PROVIDE A COMPLETE AND OPERABLE SYSTEM UPON COMPLETION OF

4. COORDINATE DEMOLITION OF DIVISION 22 SYSTEM AS REQUIRED WITH ALL

5. ALL EXISTING EQUIPMENT AND MATERIALS REMOVED DURING CONSTRUCTION, THAT IS NOT TO BE REUSED, SHALL BE REMOVED FROM THE JOB SITE AND PROPERLY RETURNED TO THE OWNER, IF DESIRED BY

PREPARE AREA FOR INSTALLATION OF NEW PLUMBING SYSTEMS. REFER

# **DEMOLITION**

1 DEMOLISH EXISTING ELECTRIC WATER HEATER AT THIS APPROXIMATE

2 DEMOLISH EXISTING CONDENSATE PIPING THAT WILL NO LONGER BE USED AT THIS APPROXIMATE LOCATION NEAR THE 2" HUB DRAIN ON

3 ISOLATE AND DISCONNECT EXISTING COLD AND HOT WATER PIPES SERVING PLUMBING FIXTURE AT THIS APPROXIMATE LOCATION. CONNECT AFTER REPLACING.

4 DEMOLISH EXISTING PLUMBING FIXTURES MARKED ON PLANS.


### PLUMBING KEYED NOTES:

1 REMOVE AND REPLACE WALL HYDRANT AT THIS APPROXIMATE LOCATION. SEE SCHEDULE ON SHEET P5.11.


2) PROVIDE NEW ELECTRIC WATER HEATER EWH-3 AS PER SCHEDULE UNDER SCHEDULE SHEET P5.11 OR AN APPROVED EQUAL. ADJUST

(3) PROVIDE NEW 1-1/2" SOFT COPPER PIPING FOR CONDENSATE DRAIN LINE OF EXISTING AIR CONDITIONING UNIT AT THIS APPROXIMATE LOCATION. PROVIDE 1" THICK FLEXIBLE ELECTROMETRIC INSULATION FOR NEW CONDENSATE PIPING AND CONNECT INTO EXISTING HUB DRAIN. NEW CONDENSATE PIPE SHALL BE SIZED AS PER AIR CONDITIONING UNIT MANUFACTURER RECOMMENDATIONS, ENSURE TO NOT PROVIDE A SMALLER PIPE SIZE THAN EXISTING.

| PLUMBING LEGEND |                             |  |
|-----------------|-----------------------------|--|
|                 | TO BE DEMOLISHED            |  |
|                 | NEW CONDENSATE PIPE         |  |
| <b>○</b> ◆      | WALL HYDRANT TO BE REPLACED |  |

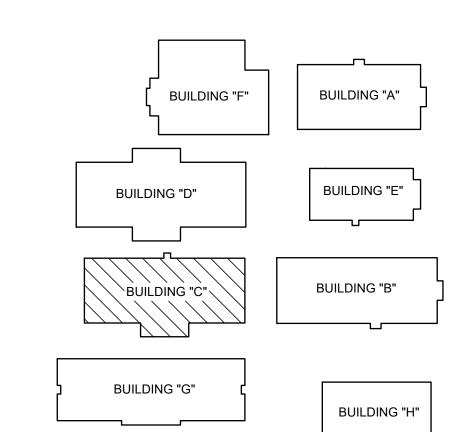


FRONTIER IDEA ACADEMY **KEYPLAN** 

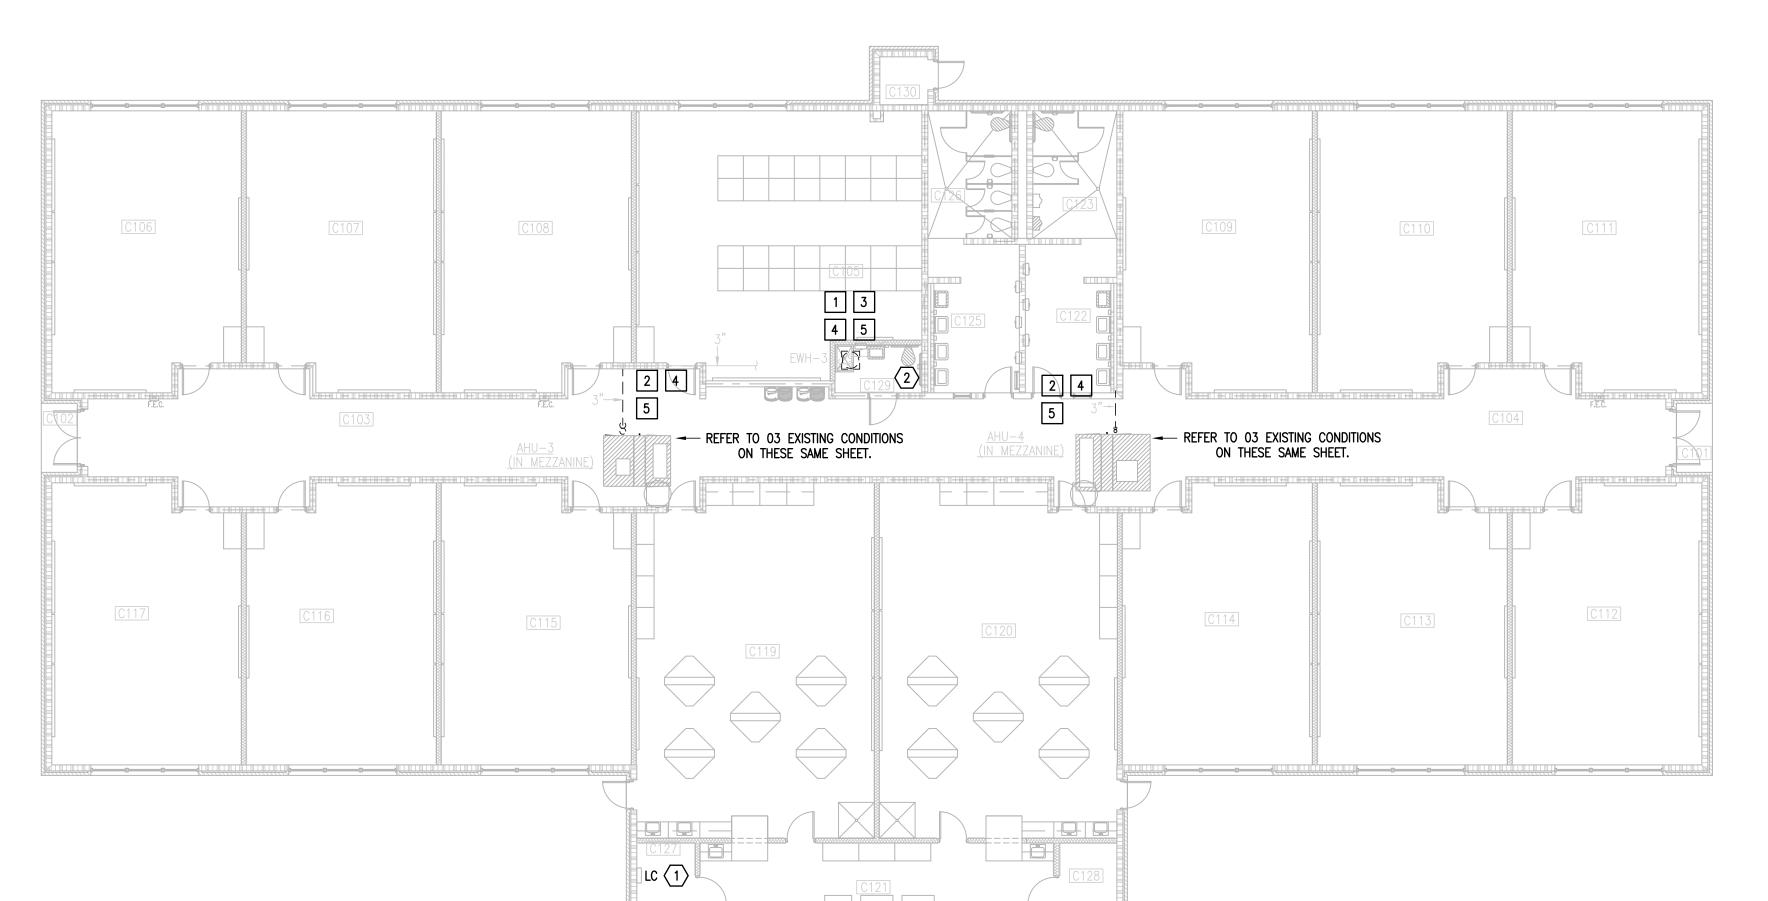

IDEA FRONTIER 01 DEMOLITION ELECTRICAL AND PLUMBING PLAN



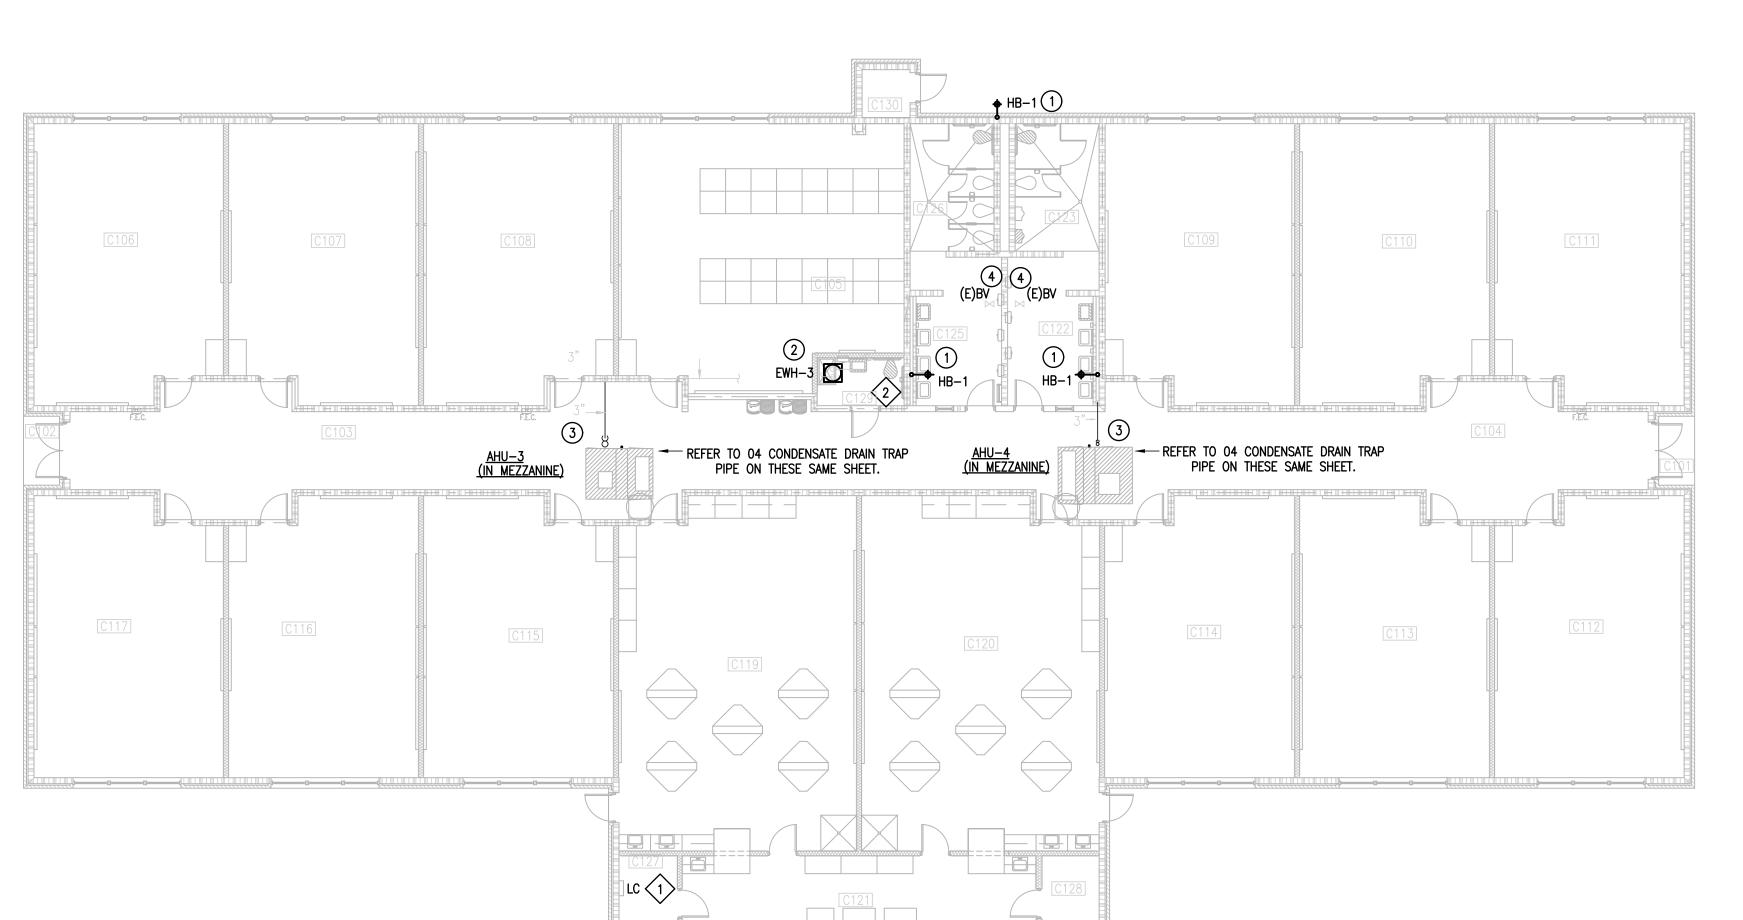

IDEA FRONTIER

02 NEW ELECTRICAL AND PLUMBING PLAN

(BUILDING C)

## **GENERAL NOTES:**

- 1. PLUMBING CONTRACTOR SHALL ISOLATE DOMESTIC COLD WATER SYSTEM AT THE WORKING AREAS PRIOR ANY WORK BEING DONE.
- 2. FOR ALL WALL HYDRANTS BEING REPLACED, CONTRACTOR SHALL RETAIN EXISTING BOX/ENCLOSURE AND SHALL REPLACE ALL INTERNAL COMPONENTS. IT WILL BE CONTRACTOR RESPONSIBILITY TO PROVIDE AN EQUAL/SIMILAR HYDRANT TO FIT INTO EXISTING BOX/ENCLOSURE.
- 3. PLUMBING CONTRACTOR SHALL PERFORM ALL WORK CAREFULLY TO NOT DAMAGE BUILDING FACADE/STRUCTURE.

## **DEMOLITION ELECTRICAL KEYED NOTES:**

- 1 APPROXIMATE LOCATION OF EXISTING PANELBOARD SERVING ELECTRIC WATER
- DISCONNECT EXISTING ELECTRIC WATER HEATER FOR INSTALLATION OF NEW ELECTRIC WATER HEATER. RETAIN AND REUSE EXISTING BRANCH CIRCUIT.


### **ELECTRICAL NEW KEYED NOTES:**

- APPROXIMATE LOCATION OF EXISTING PANELBOARD SERVING ELECTRIC WATER
- CONNECT NEW ELECTRIC WATER HEATER. RETAIN AND REUSE EXISTING BRANCH CIRCUIT. IF EXISTING BRANCH CIRCUIT DOES NOT REACH NEW POINT OF CONNECTION PROVIDE A J-BOX AND EXTEND WIRING AS NECESSARY.



## **IDEA FRONTIER** 03 EXISTING CONDITIONS AHU-3&4

(BUILDING C - MEZZANINE)

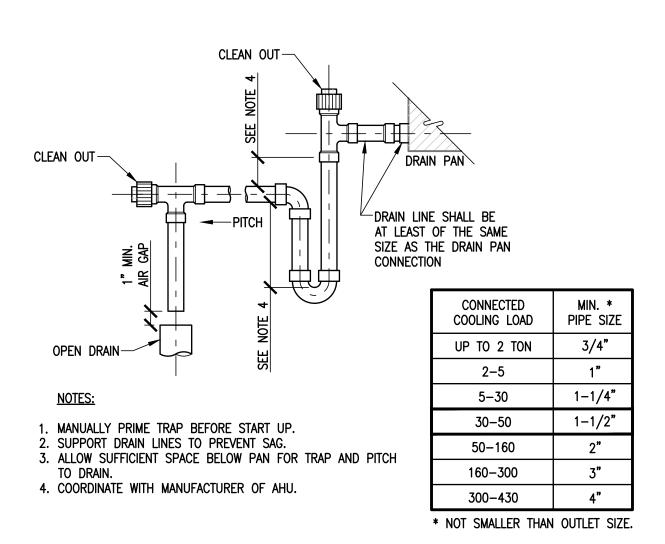

## **CONDENSATE DRAIN**

TRAP PIPE

APPLICABLE CODES INCLUDING THOSE PUBLISHED BY OSHA.

THE PROJECT.

OTHER TRADES.

COORDINATE WITH OWNER, AND DISPOSE OF EQUIPMENT AND MATERIALS THAT OWNER DOES NOT REMAIN.

TO NEW PLANS AND COORDINATE WITH DEMOLITION WORK.


PLUMBING KEYED NOTES:

5 PREPARE AREA FOR INSTALLATION OF NEW PLUMBING FIXTURES. COORDINATE WITH DEMOLITION.

PLUMBING LINES AND FITTINGS TO THE NEW PLUMBING FIXTURE AS NECESSARY. REFER TO DETAIL ON DETAIL SHEET P5.11.

4 APPROXIMATE LOCATION OF EXISTING ISOLATION VALVE. FIELD VERIFY EXACT LOCATION.

| PLUMBING LEGEND |                             |  |
|-----------------|-----------------------------|--|
|                 | TO BE DEMOLISHED            |  |
|                 | NEW CONDENSATE PIPE         |  |
| <b>○</b>        | WALL HYDRANT TO BE REPLACED |  |

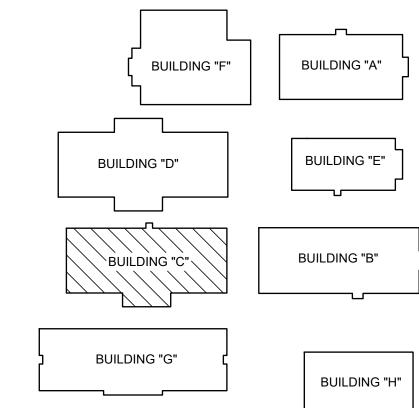

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CSP # 27-LRPU-0424

\*

CESAR A. GONZALEZ

108611

04.19.2023

APRIL 19, 202 CHECKED BY: DRAWN BY: PROJECT NO.:

P5.04



- 1. PLUMBING CONTRACTOR SHALL ISOLATE DOMESTIC COLD WATER SYSTEM AT THE WORKING AREAS PRIOR ANY WORK BEING DONE.
- 2. FOR ALL WALL HYDRANTS BEING REPLACED, CONTRACTOR SHALL RETAIN EXISTING BOX/ENCLOSURE AND SHALL REPLACE ALL INTERNAL COMPONENTS. IT WILL BE EXISTING BOX/ENCLOSURE.
- 3. PLUMBING CONTRACTOR SHALL PERFORM ALL WORK CAREFULLY TO NOT DAMAGE BUILDING FACADE/STRUCTURE.


### **DEMOLITION ELECTRICAL KEYED NOTES:**

- 1 APPROXIMATE LOCATION OF EXISTING PANELBOARD SERVING ELECTRIC WATER
- 2) DISCONNECT EXISTING ELECTRIC WATER HEATER FOR INSTALLATION OF NEW ELECTRIC WATER HEATER. RETAIN AND REUSE EXISTING BRANCH CIRCUIT.



## **IDEA FRONTIER**

O3 EXISTING CONDITIONS AHU-5&6

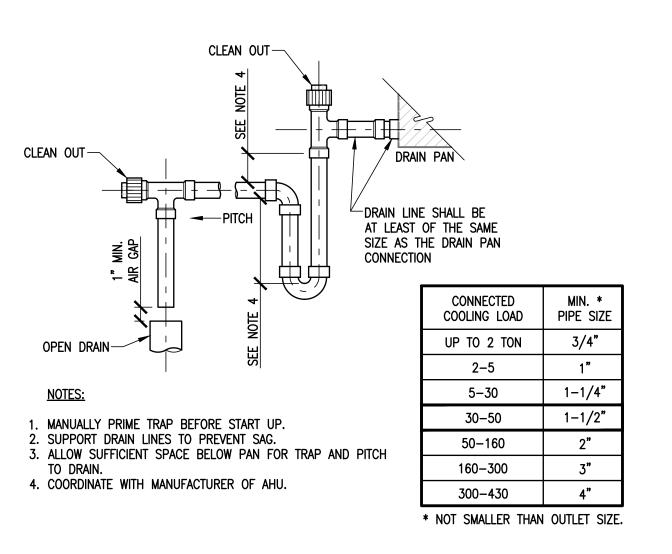

## CONDENSATE DRAIN

TRAP PIPE

# PIPING TO BE REMOVED AND REPLACED



(BUILDING D - MEZZANINE)

## **IDEA FRONTIER**

02 NEW ELECTRICAL AND PLUMBING PLAN

01 DEMOLITION ELECTRICAL AND PLUMBING PLAN

IDEA FRONTIER

 $\langle 1 \rangle$ 

REFER TO 03 EXISTING CONDITIONS

ON THESE SAME SHEET.

(BUILDING D)

REFER TO 04 CONDENSATE DRAIN TRAP PIPE ON THESE SAME SHEET.

<u>ahu-5</u> (in mezzanine)

NORTH

NORTH

5

REFER TO 03 EXISTING CONDITIONS

REFER TO 04 CONDENSATE DRAIN TRAP

PIPE ON THESE SAME SHEET.

ON THESE SAME SHEET.

CONTRACTOR RESPONSIBILITY TO PROVIDE AN EQUAL/SIMILAR HYDRANT TO FIT INTO

### **ELECTRICAL NEW KEYED NOTES:**

- CONNECTION PROVIDE A J-BOX AND EXTEND WIRING AS NECESSARY.

- APPROXIMATE LOCATION OF EXISTING PANELBOARD SERVING ELECTRIC WATER
- CONNECT NEW ELECTRIC WATER HEATER. RETAIN AND REUSE EXISTING BRANCH CIRCUIT. IF EXISTING BRANCH CIRCUIT DOES NOT REACH NEW POINT OF

## **DEMOLITION GENERAL NOTES:**

- 1. ALL DEMOLITION WORK SHALL BE DONE IN ACCORDANCE WITH ALL APPLICABLE CODES INCLUDING THOSE PUBLISHED BY OSHA.
- 2. A VISIT TO THE SITE IS REQUIRED TO PROPERLY BID THE DEMOLITION PLUMBING WORK. ALL INFORMATION SHOWN ON THE EXISTING CONSTRUCTION WILL BE REFERENCE ONLY AND WILL NEED TO BE FIELD VERIFIED BY THE CONTRACTOR.
- PROVIDE ALL DEMOLITION WORK REQUIRED FOR THE REMOVAL OF EXISTING NON REUSED PLUMBING EQUIPMENT AND ASSOCIATED DEVICES. PROVIDE A COMPLETE AND OPERABLE SYSTEM UPON COMPLETION OF THE PROJECT.
- COORDINATE DEMOLITION OF DIVISION 22 SYSTEM AS REQUIRED WITH ALL OTHER TRADES.
- 5. ALL EXISTING EQUIPMENT AND MATERIALS REMOVED DURING CONSTRUCTION, THAT IS NOT TO BE REUSED, SHALL BE REMOVED FROM THE JOB SITE AND PROPERLY RETURNED TO THE OWNER, IF DESIRED BY
- COORDINATE WITH OWNER, AND DISPOSE OF EQUIPMENT AND MATERIALS THAT OWNER DOES NOT REMAIN.
- PREPARE AREA FOR INSTALLATION OF NEW PLUMBING SYSTEMS. REFER TO NEW PLANS AND COORDINATE WITH DEMOLITION WORK.

## **DEMOLITION** PLUMBING KEYED NOTES:

- 1 DEMOLISH EXISTING ELECTRIC WATER HEATER AT THIS APPROXIMATE LOCATION.
- 2 DEMOLISH EXISTING CONDENSATE PIPING THAT WILL NO LONGER BE USED AT THIS APPROXIMATE LOCATION NEAR THE 2" HUB DRAIN ON
- 3 ISOLATE AND DISCONNECT EXISTING COLD AND HOT WATER PIPES SERVING PLUMBING FIXTURE AT THIS APPROXIMATE LOCATION. CONNECT AFTER REPLACING.
- 4 DEMOLISH EXISTING PLUMBING FIXTURES MARKED ON PLANS.
- 5 PREPARE AREA FOR INSTALLATION OF NEW PLUMBING FIXTURES. COORDINATE WITH DEMOLITION.

## PLUMBING KEYED NOTES:

- 1) REMOVE AND REPLACE WALL HYDRANT AT THIS APPROXIMATE LOCATION. SEE SCHEDULE ON SHEET P5.11.
- (2) PROVIDE NEW ELECTRIC WATER HEATER EWH-4 AS PER SCHEDULE UNDER SCHEDULE SHEET P5.11 OR AN APPROVED EQUAL. ADJUST PLUMBING LINES AND FITTINGS TO THE NEW PLUMBING FIXTURE AS NECESSARY. REFER TO DETAIL ON DETAIL SHEET P5.11.
- (3) PROVIDE NEW 1-1/2" SOFT COPPER PIPING FOR CONDENSATE DRAIN LINE OF EXISTING AIR CONDITIONING UNIT AT THIS APPROXIMATE LOCATION. PROVIDE 1" THICK FLEXIBLE ELECTROMETRIC INSULATION FOR NEW CONDENSATE PIPING AND CONNECT INTO EXISTING HUB DRAIN. NEW CONDENSATE PIPE SHALL BE SIZED AS PER AIR CONDITIONING UNIT MANUFACTURER RECOMMENDATIONS, ENSURE TO NOT PROVIDE A SMALLER PIPE SIZE THAN EXISTING.
- 4 APPROXIMATE LOCATION OF EXISTING ISOLATION VALVE. FIELD VERIFY EXACT LOCATION.

| PLUMBING LEGEND |                             |  |  |  |  |  |  |
|-----------------|-----------------------------|--|--|--|--|--|--|
|                 | TO BE DEMOLISHED            |  |  |  |  |  |  |
|                 | NEW CONDENSATE PIPE         |  |  |  |  |  |  |
| <b>○</b>        | WALL HYDRANT TO BE REPLACED |  |  |  |  |  |  |
|                 |                             |  |  |  |  |  |  |



**BUILDING "F"** 

 $^{ackslash}$ BUILDING "D"

BUILDING "C"

BUILDING "G"

BUILDING "A"

BUILDING "E"

BUILDING "B"



IDEA FRONTIER

O1 PLUMBING PLAN

SCALE: 1/8" = 1'-0"

(BUILDING E)
NORTH

**GENERAL NOTES:** 

- PLUMBING CONTRACTOR SHALL ISOLATE DOMESTIC COLD WATER SYSTEM AT THE WORKING AREAS PRIOR ANY WORK BEING DONE.
- 2. FOR ALL WALL HYDRANTS BEING REPLACED, CONTRACTOR SHALL RETAIN EXISTING BOX/ENCLOSURE AND SHALL REPLACE ALL INTERNAL COMPONENTS. IT WILL BE CONTRACTOR RESPONSIBILITY TO PROVIDE AN EQUAL/SIMILAR HYDRANT TO FIT INTO EXISTING BOX/ENCLOSURE.
- 3. PLUMBING CONTRACTOR SHALL PERFORM ALL WORK CAREFULLY TO NOT DAMAGE BUILDING FACADE/STRUCTURE.

## PLUMBING KEYED NOTES:

1 REMOVE AND REPLACE WALL HYDRANT/HOSE BIB, AT THIS APPROXIMATE LOCATION. SEE SCHEDULE ON SHEET P5.11.

2 APPROXIMATE LOCATION OF EXISTING ISOLATION VALVE. FIELD VERIFY EXACT LOCATION.

| PLU            | MBING LEGEND                |
|----------------|-----------------------------|
| <del>0 ф</del> | WALL HYDRANT TO BE REPLACED |
|                |                             |

CSP # 27-LRPU-0424

NO: REVISION: BY:



04.19.202 SH

TEXAS

IDEA PUBLIC SCHOOLS LOWER RGV PLUMBING UPGRADE





P5.05

FRONTIER IDEA ACADEMY KEYPLAN

BUILDING "F"

BUILDING "D"

BUILDING "C"

BUILDING "G"

BUILDING "A"

BUILDING "E"

BUILDING "B"

BUILDING "H"

COPY NO:

CSP # 27-LRPU-0424

\*

CESAR A. GONZALEZ

DRAWN BY:

BUILDING "H" PROJECT NO.: FRONTIER IDEA ACADEMY P5.06 KEYPLAN

BUILDING "A"

BUILDING "E"


BUILDING "B"

BUILDING "F"

BUILDING "D"

BUILDING "C"

BUILDING "G"

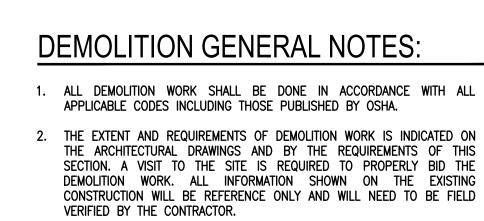

- 3. PROVIDE ALL DEMOLITION WORK REQUIRED FOR THE REMOVAL OF EXISTING NON REUSED PLUMBING EQUIPMENT AND ASSOCIATED DEVICES. PROVIDE A COMPLETE AND OPERABLE SYSTEM UPON COMPLETION OF THE PROJECT.
- 4. COORDINATE DEMOLITION OF DIVISION 22 SYSTEM AS REQUIRED WITH ALL OTHER TRADES.
- 5. ALL EXISTING EQUIPMENT AND MATERIALS REMOVED DURING CONSTRUCTION, THAT IS NOT TO BE REUSED, SHALL BE REMOVED FROM THE JOB SITE AND PROPERLY RETURNED TO THE OWNER, IF DESIRED BY
- 6. IT IS INTENDED THAT DEMOLITION WORK LEAVE THE ENTIRE AREA FREE OF ABOVE-GRADE ITEMS. INCLUDING PIPING, STRUCTURAL SUPPORTS MATERIALS AND MISCELLANEOUS ITEMS. ALL SUCH ITEMS ARE TO BE REMOVED UNLESS SPECIFICALLY INDICATED OTHERWISE.
- OWNER MAY WISH TO KEEP DEMOLISHED EQUIPMENT AND MATERIALS. COORDINATE WITH OWNER, AND DISPOSE OF EQUIPMENT AND MATERIALS THAT OWNER DOES NOT REMAIN.
- 8. PREPARE AREA FOR INSTALLATION OF NEW PLUMBING SYSTEMS. REFER TO NEW PLANS AND COORDINATE WITH DEMOLITION WORK.


## DEMOLITION PLUMBING KEYED NOTES:

- 1 DEMOLISH EXISTING ELECTRIC WATER HEATER AT THIS APPROXIMATE LOCATION.
- 2 ISOLATE AND DISCONNECT EXISTING COLD AND HOT WATER PIPES SERVING PLUMBING FIXTURE AT THIS APPROXIMATE LOCATION. CONNECT AFTER REPLACING.
- 3 DEMOLISH EXISTING PLUMBING FIXTURES MARKED ON PLANS.
- 4 PREPARE AREA FOR INSTALLATION OF NEW PLUMBING FIXTURES. COORDINATE WITH DEMOLITION.

| PLUMBING LEGEND |                  |  |  |  |  |
|-----------------|------------------|--|--|--|--|
|                 | TO BE DEMOLISHED |  |  |  |  |

## DEMOLITION **ELECTRICAL KEYED NOTES:**

- 1) APPROXIMATE LOCATION OF EXISTING PANELBOARD SERVING ELECTRIC WATER HEATER.
- DISCONNECT EXISTING ELECTRIC WATER HEATER FOR INSTALLATION OF NEW ELECTRIC WATER HEATER. RETAIN AND REUSE EXISTING BRANCH

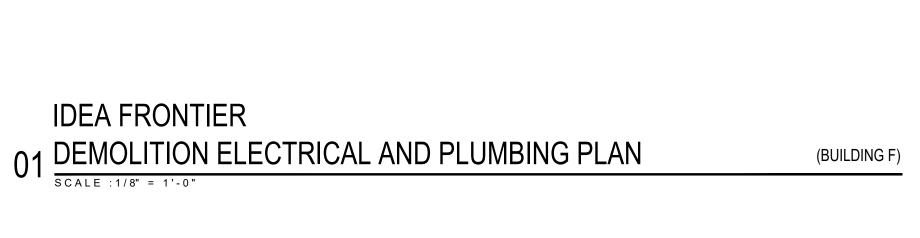



F117

LDING F)



## **GENERAL NOTES:**

- PLUMBING CONTRACTOR SHALL ISOLATE DOMESTIC COLD WATER SYSTEM AT THE WORKING AREAS PRIOR ANY WORK BEING DONE.
- 2. FOR ALL WALL HYDRANTS BEING REPLACED, CONTRACTOR SHALL RETAIN EXISTING BOX/ENCLOSURE AND SHALL REPLACE ALL INTERNAL COMPONENTS. IT WILL BE CONTRACTOR RESPONSIBILITY TO PROVIDE AN EQUAL/SIMILAR HYDRANT TO FIT INTO EXISTING BOX/ENCLOSURE.
- 3. PLUMBING CONTRACTOR SHALL PERFORM ALL WORK CAREFULLY TO NOT DAMAGE BUILDING FACADE/STRUCTURE.


## PLUMBING KEYED NOTES:

- 1 REMOVE AND REPLACE WALL HYDRANT AT THIS APPROXIMATE LOCATION. SEE SCHEDULE ON SHEET P5.11.
- 2 PROVIDE NEW ELECTRIC WATER HEATER EWH-5 AS PER SCHEDULE UNDER SCHEDULE SHEET P5.11 OR AN APPROVED EQUAL. ADJUST PLUMBING LINES AND FITTINGS TO THE NEW PLUMBING FIXTURE AS NECESSARY. REFER TO DETAIL ON DETAIL SHEET P5.11.
- 3 APPROXIMATE LOCATION OF EXISTING ISOLATION VALVE. FIELD VERIFY EXACT LOCATION.

## ELECTRICAL NEW KEYED NOTES:

- APPROXIMATE LOCATION OF EXISTING PANELBOARD SERVING ELECTRIC WATER HEATER.
- 2 CONNECT NEW ELECTRIC WATER HEATER. RETAIN AND REUSE EXISTING BRANCH CIRCUIT. IF EXISTING BRANCH CIRCUIT DOES NOT REACH NEW POINT OF CONNECTION PROVIDE A J-BOX AND EXTEND WIRING AS NECESSARY.

| PL                              | PLUMBING LEGEND |  |  |  |  |  |
|---------------------------------|-----------------|--|--|--|--|--|
| — — TO BE DEMOLISHED            |                 |  |  |  |  |  |
| ○ ◆ WALL HYDRANT TO BE REPLACED |                 |  |  |  |  |  |

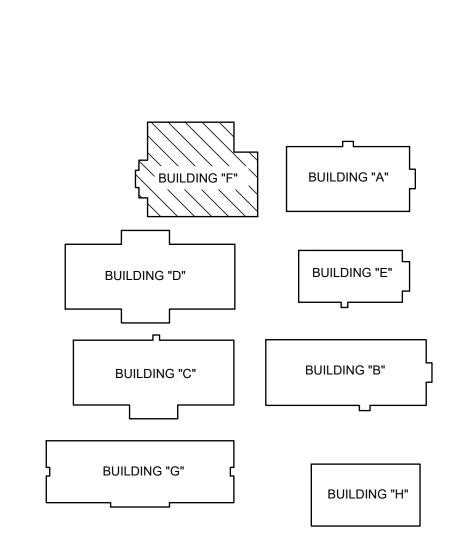

FRONTIER IDEA ACADEMY KEYPLAN

NO: REVISION: BY:

CSP # 27-LRPU-0424

COPY NO:



04.19.20

TEXAS

IDEA PUBLIC SCHOOLS LOWER RGV PLUMBING UPGR

O GRANDRE VALL


1126 SOUTH COMMERCE ST. HARLINGEN, TX PHONE: 956-230-3435 TEXAS REGISTERED ENGINEERING FIRM F-15998

P5.07

CHECKED BY:

PROJECT NO.:

DRAWN BY:

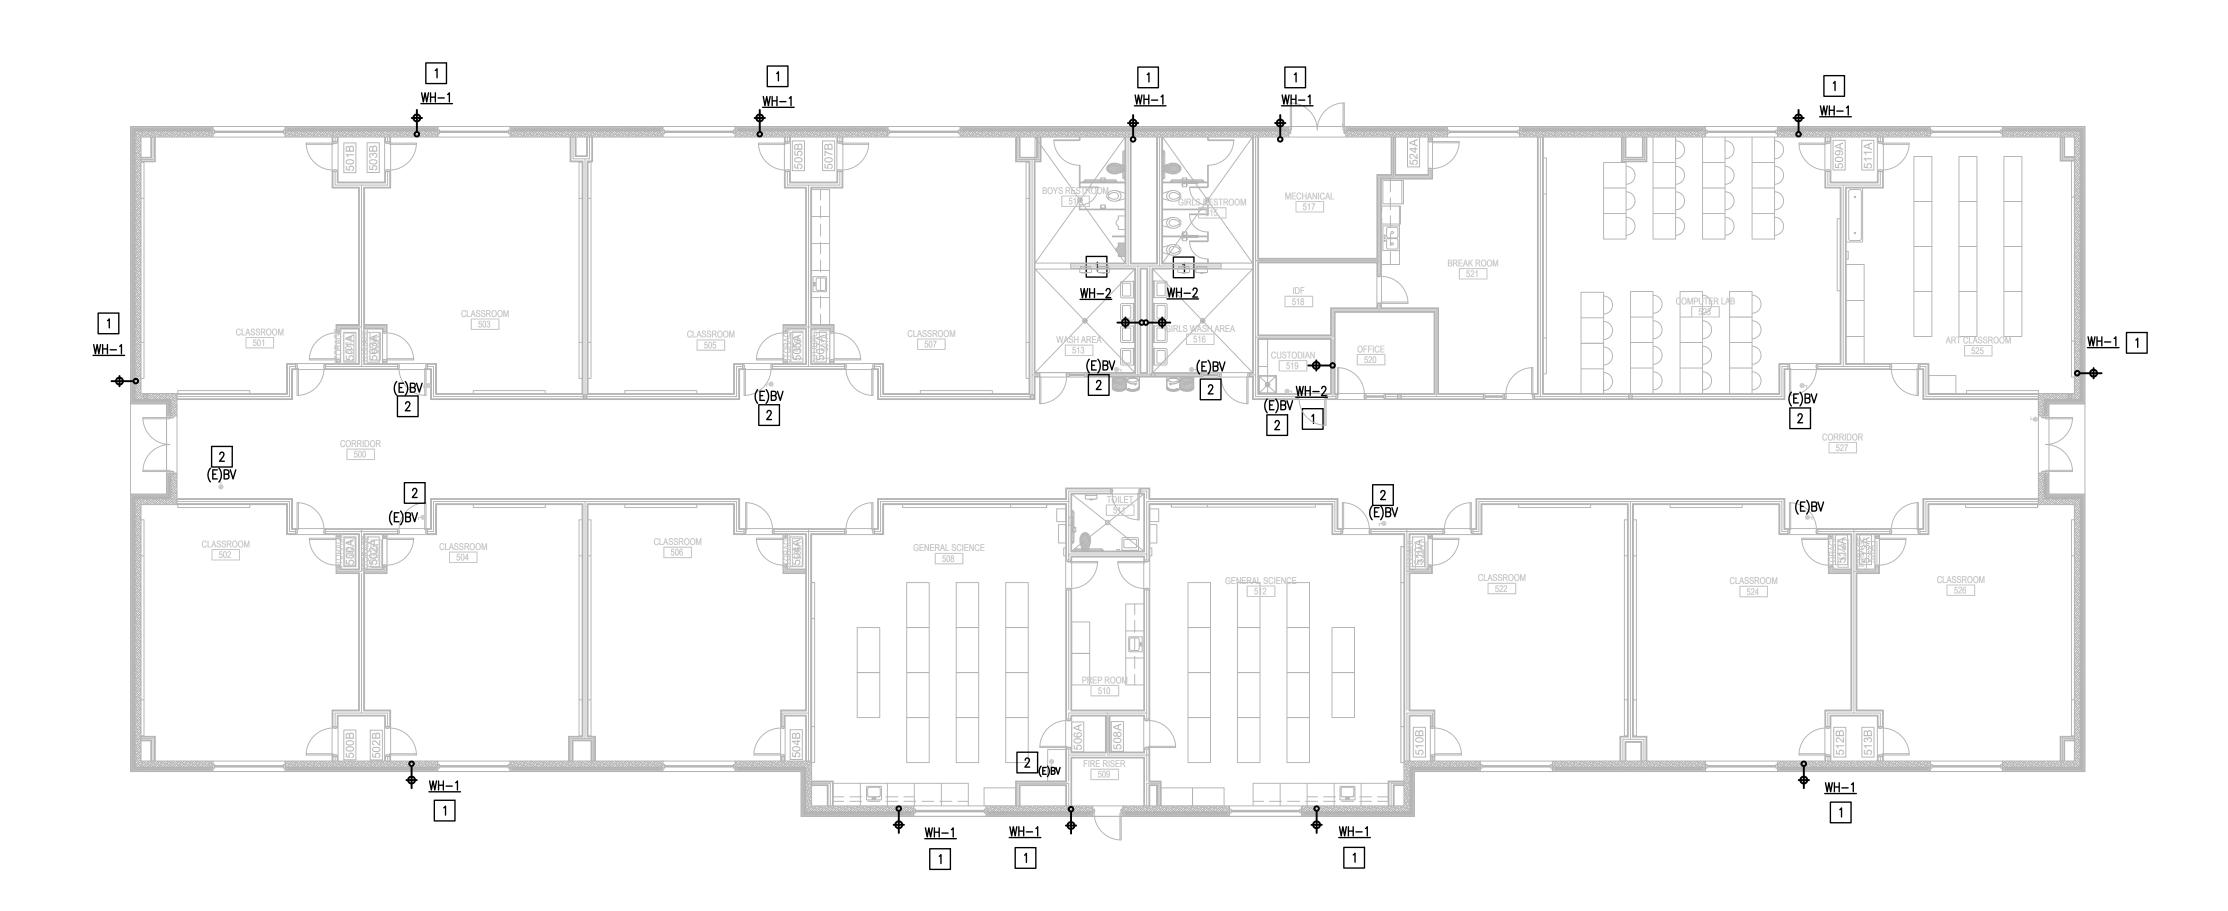

IDEA FRONTIER

O1 PLUMBING PLAN

SCALE:3/32" = 1'-0"

LDING G)

**GENERAL NOTES:** 

- PLUMBING CONTRACTOR SHALL ISOLATE DOMESTIC COLD WATER SYSTEM AT THE WORKING AREAS PRIOR ANY WORK BEING DONE.
- FOR ALL WALL HYDRANTS BEING REPLACED, CONTRACTOR SHALL RETAIN EXISTING BOX/ENCLOSURE AND SHALL REPLACE ALL INTERNAL COMPONENTS. IT WILL BE CONTRACTOR RESPONSIBILITY TO PROVIDE AN EQUAL/SIMILAR HYDRANT TO FIT INTO EXISTING BOX/ENCLOSURE.
- PLUMBING CONTRACTOR SHALL PERFORM ALL WORK CAREFULLY TO NOT DAMAGE BUILDING FACADE/STRUCTURE.

## PLUMBING KEYED NOTES:

- REMOVE AND REPLACE WALL HYDRANT AT THIS APPROXIMATE LOCATION. SEE SCHEDULE ON SHEET P5.11.
- 2 APPROXIMATE LOCATION OF EXISTING ISOLATION VALVE. FIELD VERIFY EXACT LOCATION.

| PLUMBING LEGEND  |                             |  |  |  |
|------------------|-----------------------------|--|--|--|
| о <del></del> ф- | WALL HYDRANT TO BE REPLACED |  |  |  |

NO: REVISION: BY:

CSP # 27-LRPU-0424

COPY NO:



04.19.2023

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IDEA PUBLIC SCHOOLS LOWER RGV PLUMBING UPGRADI





CAD FILE:
SHEET:
P5.08

FRONTIER IDEA ACADEMY KEYPLAN

BUILDING "F"

BUILDING "D"

BUILDING "C"

BUILDING "G"

BUILDING "A"

BUILDING "E"

BUILDING "B"

BUILDING "H"

(BUILDING H)


**GENERAL NOTES:** 

- 1. PLUMBING CONTRACTOR SHALL ISOLATE DOMESTIC COLD WATER SYSTEM AT THE WORKING AREAS PRIOR ANY WORK BEING DONE.
- 2. FOR ALL WALL HYDRANTS BEING REPLACED, CONTRACTOR SHALL RETAIN EXISTING BOX/ENCLOSURE AND SHALL REPLACE ALL INTERNAL COMPONENTS. IT WILL BE CONTRACTOR RESPONSIBILITY TO PROVIDE AN EQUAL/SIMILAR HYDRANT TO FIT INTO EXISTING BOX/ENCLOSURE.
- 3. PLUMBING CONTRACTOR SHALL PERFORM ALL WORK CAREFULLY TO NOT DAMAGE BUILDING FACADE/STRUCTURE.

## PLUMBING KEYED NOTES:

- 1 REMOVE AND REPLACE WALL HYDRANT AT THIS APPROXIMATE LOCATION. SEE SCHEDULE ON SHEET P5.11.
- 2 APPROXIMATE LOCATION OF EXISTING ISOLATION VALVE. FIELD VERIFY EXACT LOCATION.

| PLU       | MBING LEGEND                |
|-----------|-----------------------------|
| <b>0−</b> | WALL HYDRANT TO BE REPLACED |

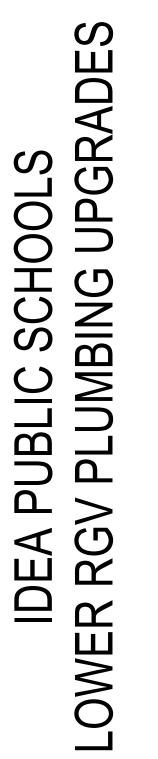


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COPY NO:

CSP # 27-LRPU-0424

CESAR A. GONZALEZ

04.19.2023

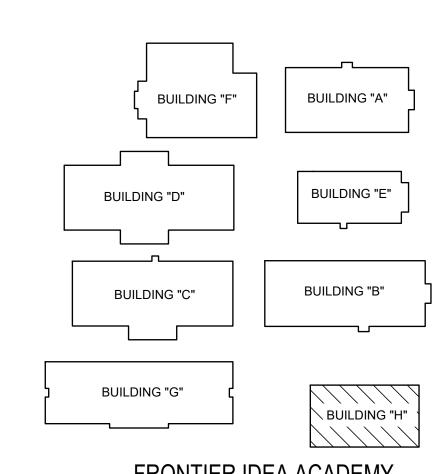

FRONTIER IDEA ACADEMY KEYPLAN



1126 SOUTH COMMERCE ST. HARLINGEN, TX PHONE: 956-230-3435 TEXAS REGISTERED ENGINEERING FIRM F-15998

CHECKED BY: C.A.G.

P5.09

DRAWN BY:

PROJECT NO.:

APRIL 19, 2024

1126 SOUTH COMMERCE ST. HARLINGEN, TX PHONE: 956-230-3435 TEXAS REGISTERED

ENGINEERING FIRM F-15998

CHECKED BY: C.A.G.

P5.10

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PROJECT NO.:

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COPY NO:

CSP # 27-LRPU-0424

CESAR A. GONZALEZ

04.19.2023

1. ALL DEMOLITION WORK SHALL BE DONE IN ACCORDANCE WITH ALL APPLICABLE CODES INCLUDING THOSE PUBLISHED BY OSHA.

2. A VISIT TO THE SITE IS REQUIRED TO PROPERLY BID THE DEMOLITION PLUMBING WORK. ALL INFORMATION SHOWN ON THE EXISTING CONSTRUCTION WILL BE REFERENCE ONLY AND WILL NEED TO BE FIELD VERIFIED BY THE CONTRACTOR.

3. PROVIDE ALL DEMOLITION WORK REQUIRED FOR THE REMOVAL OF EXISTING NON REUSED PLUMBING EQUIPMENT AND ASSOCIATED DEVICES. PROVIDE A COMPLETE AND OPERABLE SYSTEM UPON COMPLETION OF THE PROJECT.

4. COORDINATE DEMOLITION OF DIVISION 22 SYSTEM AS REQUIRED WITH ALL OTHER TRADES.

5. COORDINATE WITH OWNER, AND DISPOSE OF EQUIPMENT AND MATERIALS THAT OWNER DOES NOT REMAIN.

6. PLUMBING CONTRACTOR SHALL ISOLATE DOMESTIC COLD AND HOT WATER SYSTEM AT THE WORKING AREAS PRIOR ANY WORK BEING DONE.

7. PLUMBING CONTRACTOR SHALL PERFORM EXCAVATION/HAND DIG WITH CAUTION TO NOT DAMAGE ANY EXISTING UTILITIES. CONTRACTOR WILL BE RESPONSIBLE TO FIX OR REPAIR ANY ITEM THAT RESULT DAMAGED WHILE PERFORMING WORK.

## **DEMOLITION** PLUMBING KEYED NOTES (ALT#1):

1 DEMOLISH EXISTING 4" DOMESTIC COLD WATER BACK-FLOW PREVENTER AT THIS APPROXIMATE LOCATION.

## PLUMBING KEYED NOTES (ALT#1):


PROVIDE NEW 4" BACK FLOW PREVENTER WATTS MODEL:LF957RPDA-FS, WITH FLANGED ENDS, LEAD FREE AND NSF COMPLIANT OR AN APPROVED EQUAL.


## PLUMBING KEYED NOTES:

1) RUN NEW 1" DOMESTIC COLD WATER PIPE FROM PORTABLE BUILDING AND CONNECT DOWNSTREAM THE DOMESTIC COLD WATER BACK-FLOW PREVENTER.


2 ROVIDE NEW GATE VALVE IN QUAZITE BOX. SEE ASSOCIATED DETAIL ON

3 EXCAVATE AT THIS APPROXIMATE LOCATION AS NECESSARY TO ACCOMMODATE NEW UNDERGROUND COLD WATER LINE PIPING. HAND DIG AS NECESSARY TO AVOID ANY EXISTING UTILITIES. AREA TO BE BACKFILLED, COMPACTED, AND TO MATCH EXISTING CONDITIONS.

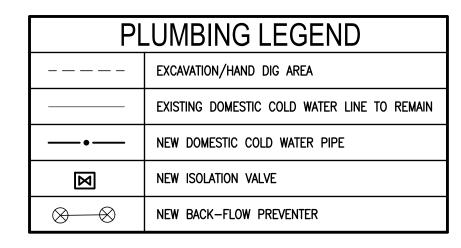

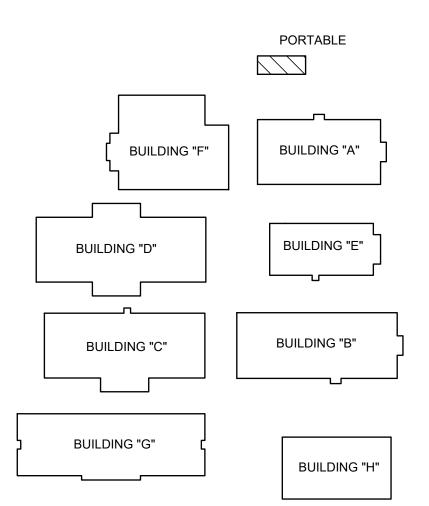

FRONTIER IDEA ACADEMY KEYPLAN

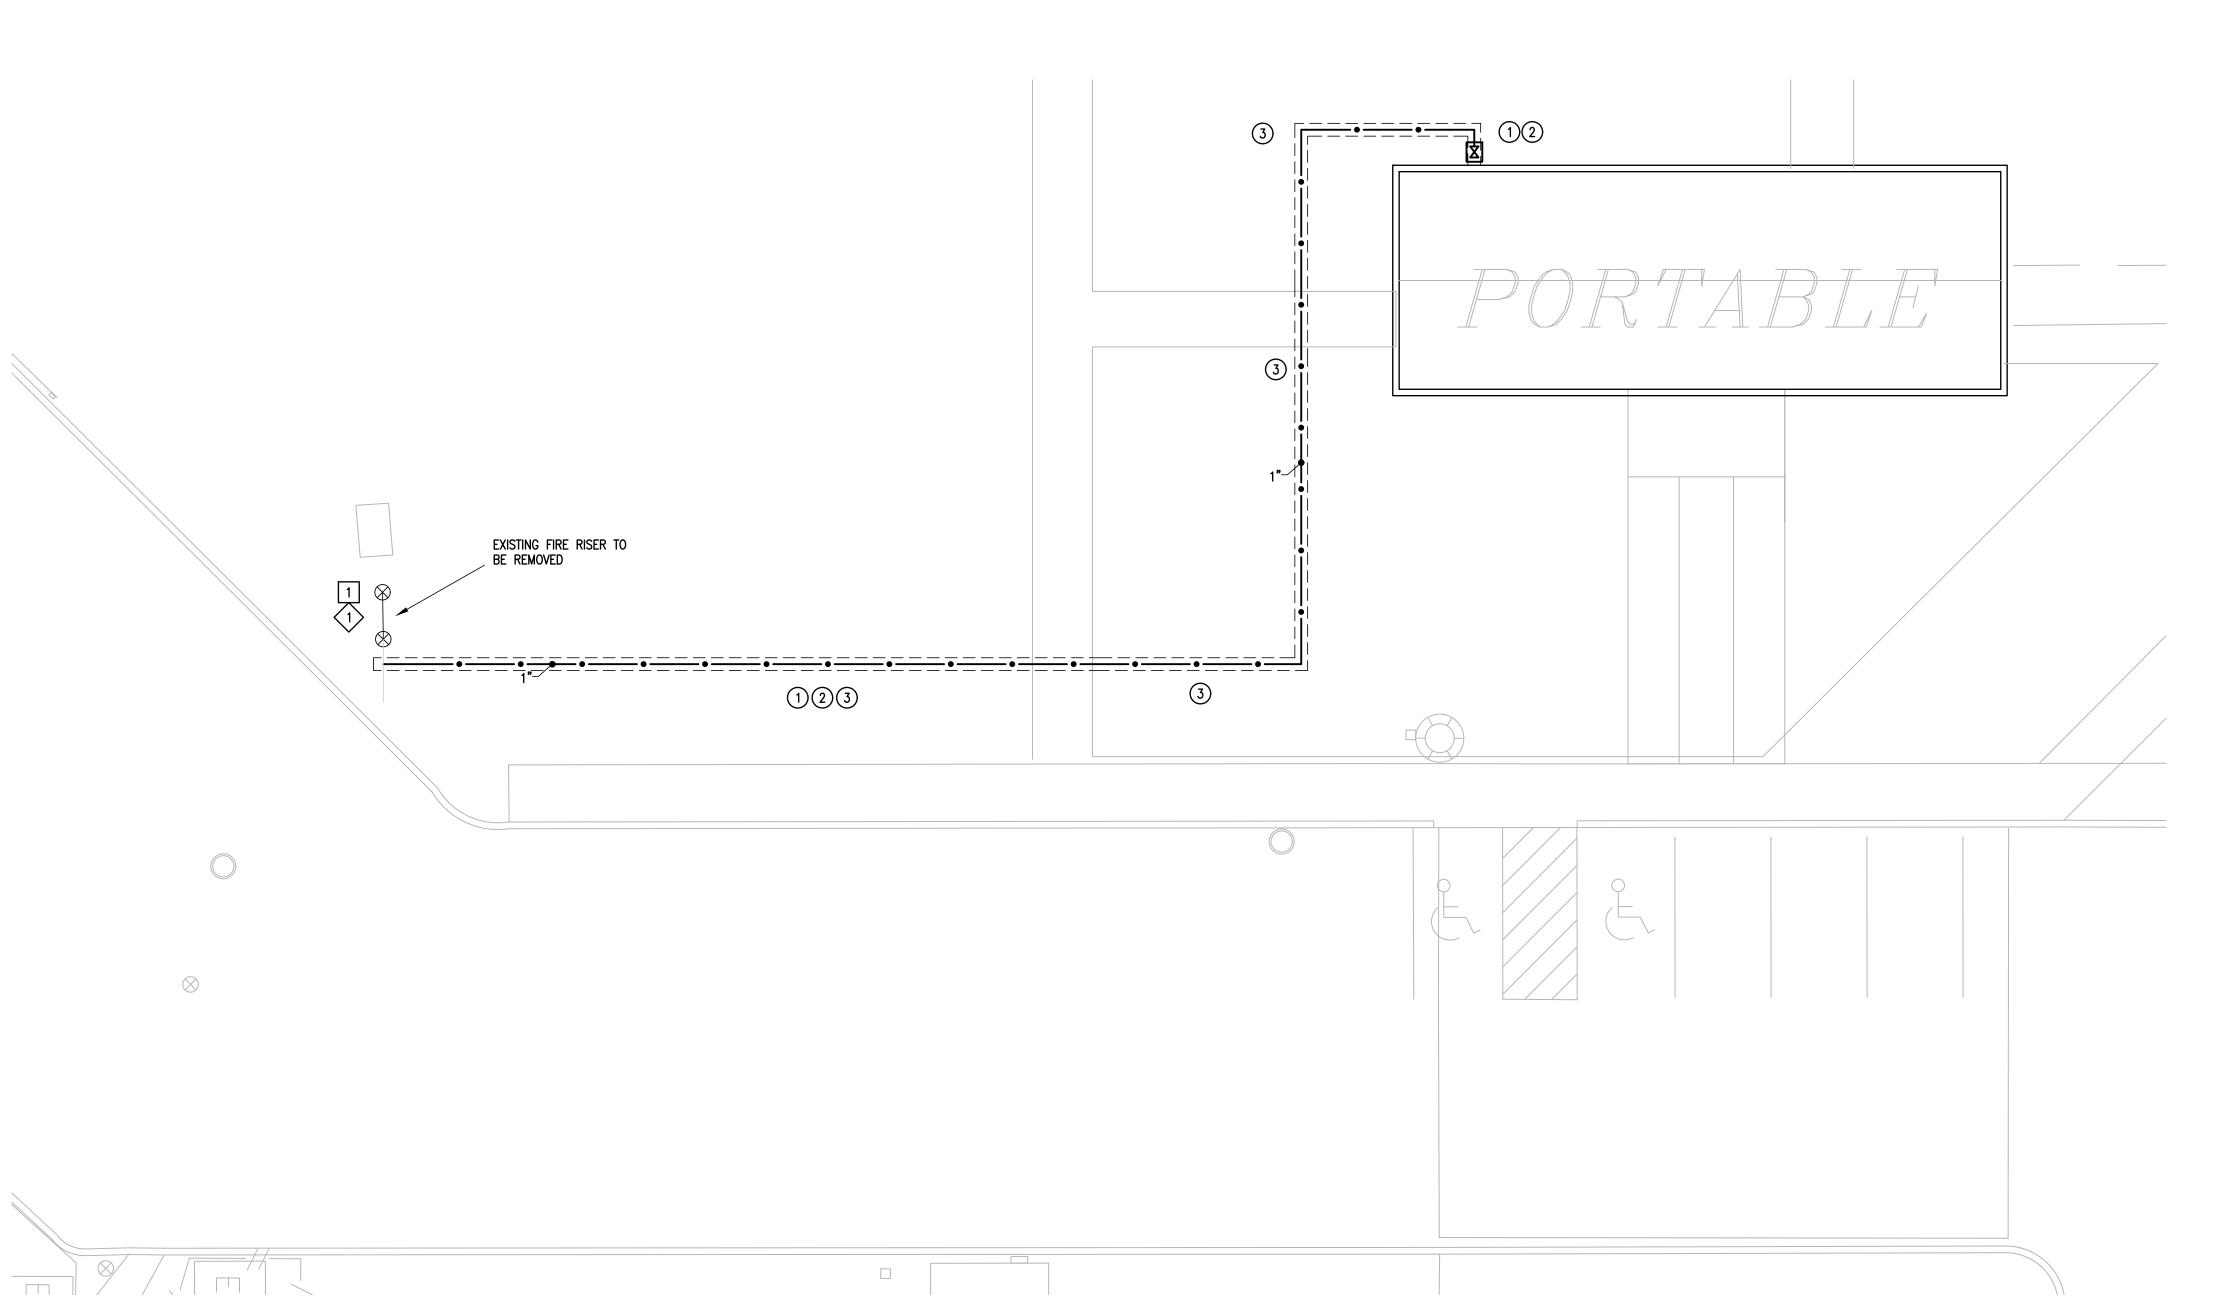

IDEA FRONTIER 01 PLUMBING PLAN
SCALE: 1" = 10'-0"





(ALTERNATE #1)

IDEA FRONTIER DOMESTIC COLD WATER 02 BACK-FLOW PREVENTER EXISTING DOMESTIC COLD WATER BACK-FLOW PREVENTER TO BE REPLACED (ALTERNATE #1)



EXISTING DOMESTIC COLD

CUT AND RUN NEW PIPING AS PER PLANS.

WATER MAIN VALVE SERVING PORTABLE.

IDEA FRONTIER (PORTABLE) DOMESTIC COLD WATER

03 ENTRANCE
SCALE : NOT TO SCALE

COPY NO:

CSP # 27-LRPU-0424

CESAR A. GONZALEZ

04.19.2023

| 0000  | IBING FIXTURE SCH   |  |       |    |         |          |       |         |
|-------|---|--|-------|----|---------|----------|-------|---------|
| MARK  | MANUFACTURER & MODEL NUMBER                                       | DESCRIPTION  | WASTE |    | NNECTIC | NS<br>HW | NOTES | REMARKS |
| EDF-1 | ELKAY<br>LVRCTL8SC<br>APRON<br>98324C<br>CARRIER<br>ZURN Z1225-BL | WALL MOUNTED ADA VANDAL-RESISTANT FILTERED, 8.0 GPH STAINLESS STEEL, BI-LEVEL ELECTRIC DRINKING FOUNTAIN. VANDAL- RESISTANT BUBBLERS WITH CHROME PLATED INTEGRAL HOOD GUARD, PVC P-TRAP, INDOOR RATED, APRON AND CARRIER. ADULT STANDARD & ADULT ADA MOUNTING. | 2"    | 2" | 1/2"    | -        | -     | -       |
|       | ELKAY   | WALL MOUNTED ADA VANDAL-RESISTANT FILTERED, 8.0 GPH STAINLESS STEEL, BOTTLE  |       |    |         |          |       |         |

|        | MANUFACTURER &   |  | CONNECTIONS |      |      |    |       |         |
|--------|--|--|-------------|------|------|----|-------|---------|
| MARK   | MODEL NUMBER   | DESCRIPTION  | WASTE       | VENT | CW   | HW | NOTES | REMARKS |
| EDF-1  | ELKAY<br>LVRCTL8SC<br>APRON<br>98324C<br>CARRIER<br>ZURN Z1225-BL  | WALL MOUNTED ADA VANDAL-RESISTANT FILTERED, 8.0 GPH STAINLESS STEEL, BI-LEVEL ELECTRIC DRINKING FOUNTAIN. VANDAL- RESISTANT BUBBLERS WITH CHROME PLATED INTEGRAL HOOD GUARD, PVC P-TRAP, INDOOR RATED, APRON AND CARRIER. ADULT STANDARD & ADULT ADA MOUNTING.   | 2"          | 2"   | 1/2" | -  | -     |         |
| EDF-2  | ELKAY<br>LVRCTL8WSK<br>APRON<br>98324C<br>CARRIER<br>ZURN Z1225-BL | WALL MOUNTED ADA VANDAL-RESISTANT FILTERED, 8.0 GPH STAINLESS STEEL, BOTTLE FILLING STATION & BI-LEVEL ELECTRIC DRINKING FOUNTAIN. VANDAL-RESISTANT BUBBLERS WITH CHROME PLATED INTEGRAL HOOD GUARD, PVC P-TRAP, INDOOR RATED, APRON AND CARRIER. ADULT STANDARD & ADULT ADA MOUNTING.   | 2"          | 2"   | 1/2" | -  | -     | -       |
| WH-1&2 | WOODFORD<br>MODEL 65   | THE MODEL 65 ARE AUTOMATIC DRAINING, FREEZELESS WALL HYDRANTS WITH SINGLE CHECK HOSE CONNECTION ANTI-SIPHON VACUUM BREAKERS. HYDRANTS DRAIN AS HANDLE IS SHUT OFF, EVEN IF HOSE IS ATTACHED. ALL MODELS ARE DESIGNED FOR IRRIGATION PURPOSES TO BLEND IN WITH MODERN ARCHITECTURE FOR INSTALLATION ON RESTAURANTS, SCHOOLS, OFFICE BUILDINGS, CHURCHES, APARTMENTS, MOTELS, STORES, SHOPPING CENTERS AND INDUSTRIAL BUILDINGS. | -           | -    | 3/4" | -  | -     |         |
| HB-1   | WOODFORD<br>MODEL 26   | THE MODEL 26 ARE FIELD TESTABLE, BACKFLOW PROTECTED WALL FAUCETS INTENDED FOR IRRIGATION PURPOSES IN MILD CLIMATE AREAS. THE MODELS ARE DESIGNED TO BLEND WITH MODERN ARCHITECTURE FOR INSTALLATION ON OR IN HOMES, SERVICE STATIONS, CHURCHES, MOTELS, DRIVEIN RESTAURANTS, ETC.  | -           | -    | 3/4" | -  | -     |         |

| ELE      | ELECTRIC WATER HEATER SCHEDULE                           |           |          |     |             |                 |          |                     |       |  |  |  |
|----------|--|-----------|----------|-----|-------------|-----------------|----------|---------------------|-------|--|--|--|
| Project: | Project: IDEA PS PLUMBING UPGRADES AT LOWER RGV CAMPUSES |           |          |     |             |                 |          |                     |       |  |  |  |
| MARK     | LOCATION   | SERVING   | GALLON   | KW  | NUMBER      | RECOVERY IN GPH | ELECT.   | MANUFACTURER        | NOTES |  |  |  |
| IVIARK   | LOCATION   | SERVING   | CAPACITY | KVV | OF ELEMENTS | AT 120°F RISE   | V/P/H    | & MODEL             | NOTES |  |  |  |
| EWH-1    | SEE PLANS  | SEE PLANS | 6        | 3   | 1           | 10              | 208/1/60 | A.O. SMITH DEL-6    | ALL   |  |  |  |
| EWH-2    | SEE PLANS  | SEE PLANS | 6        | 3   | 1           | 10              | 208/1/60 | A.O. SMITH DEL-6    | ALL   |  |  |  |
| EWH-3    | SEE PLANS  | SEE PLANS | 6        | 3   | 1           | 10              | 208/1/60 | A.O. SMITH DEL-6    | ALL   |  |  |  |
| EWH-4    | SEE PLANS  | SEE PLANS | 6        | 3   | 1           | 10              | 208/1/60 | A.O. SMITH DEL-6    | ALL   |  |  |  |
| EWH-5    | SEE PLANS  | SEE PLANS | 120      | 54  | 3           | 185             | 480/3/60 | A.O. SMITH DSE-120A | ALL   |  |  |  |

### NOTES:

- 1. MANUFACTURER & MODEL NUMBER ARE "OR APPROVED EQUAL".
- 2. PROVIDE INMERSION TYPE THERMOSTAT.







EDF-2 04




WH-1&2 05 SCALE: NOT TO SCALE






EWH-1,2,3&4 SCALE: NOT TO SCALE

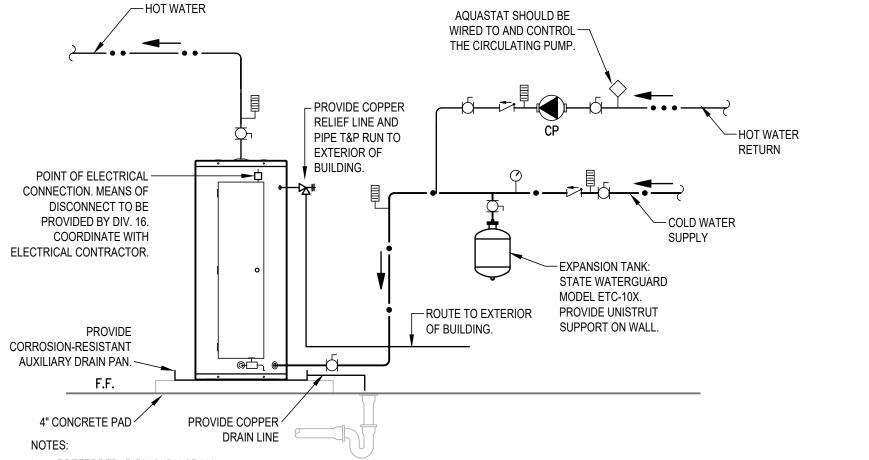


- 1. PREFERRED PIPING DIAGRAM.
- 2. THE TEMPERATURE AND PRESSURE RELIEF VALVE SETTING SHALL NOT EXCEED PRESSURE RATING OF ANY COMPONENT IN THE SYSTEM.
- 3. PROVIDE HEAT TRAP DEVICE OR AN ARRANGEMENT OF TUBING AS PER IECC. INSULATE THE FIRST 8' OF OUTLET PIPING AND THE INLET PIPING BETWEEN THE STORAGE TANK AND HEAT TRAP (INCLUDE THE HEAT TRAP).
- 4. WHERE WATER HEATER IS INSTALLED IN A ROOM WITH SUSPENDED CEILING, SHUT OFF VALVES MUST BE LOCATED BELOW SUSPENDED CEILING.


| #          | TEMPERATURE &<br>PRESSURE RELIEF<br>VALVE | Å | CHECK VALVE | ф | FULL PORT BALL<br>VALVE | $\bigcirc$ | PRESSURE GAUGE      |
|------------|---|---|-------------|---|-------------------------|------------|---------------------|
| $\Diamond$ | AQUASTAT                                  | 4 | DRAIN       | F | TEMPERATURE<br>GAGE     |            | CIRCULATING<br>PUMP |



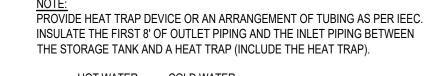


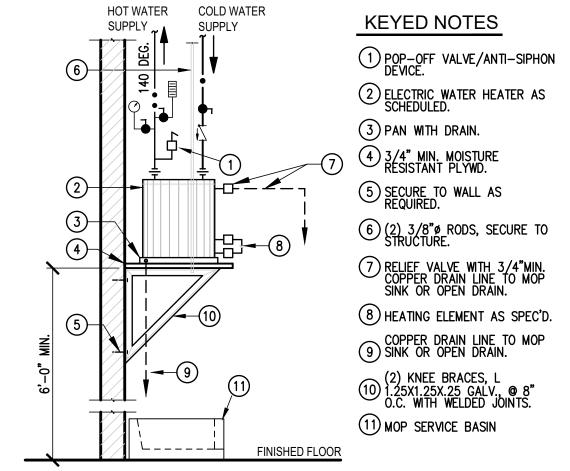

EWH-1,2,3&4 WALL MOUNTED 02 ELECTRIC WATER HEATER DETAIL
SCALE: NOT TO SCALE

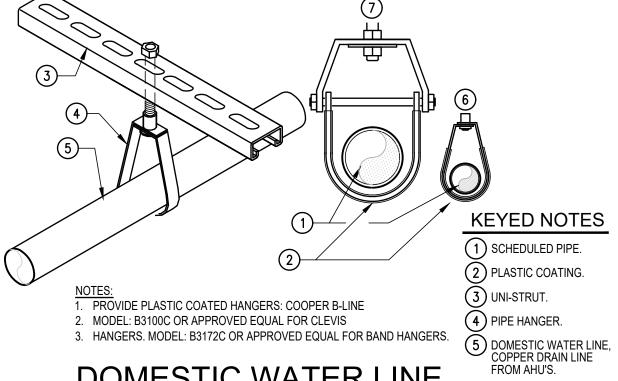



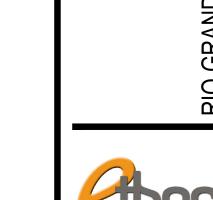



CHECKED BY: DRAWN BY: PROJECT NO.:

P5.11




EWH-5


1126 SOUTH COMMERCE ST. HARLINGEN, TX PHONE: 956-230-3435 TEXAS REGISTERED ENGINEERING FIRM F-15998 APRIL 19, 202

CHECKED BY: C.A.G. DRAWN BY:

PROJECT NO.:

P6.01

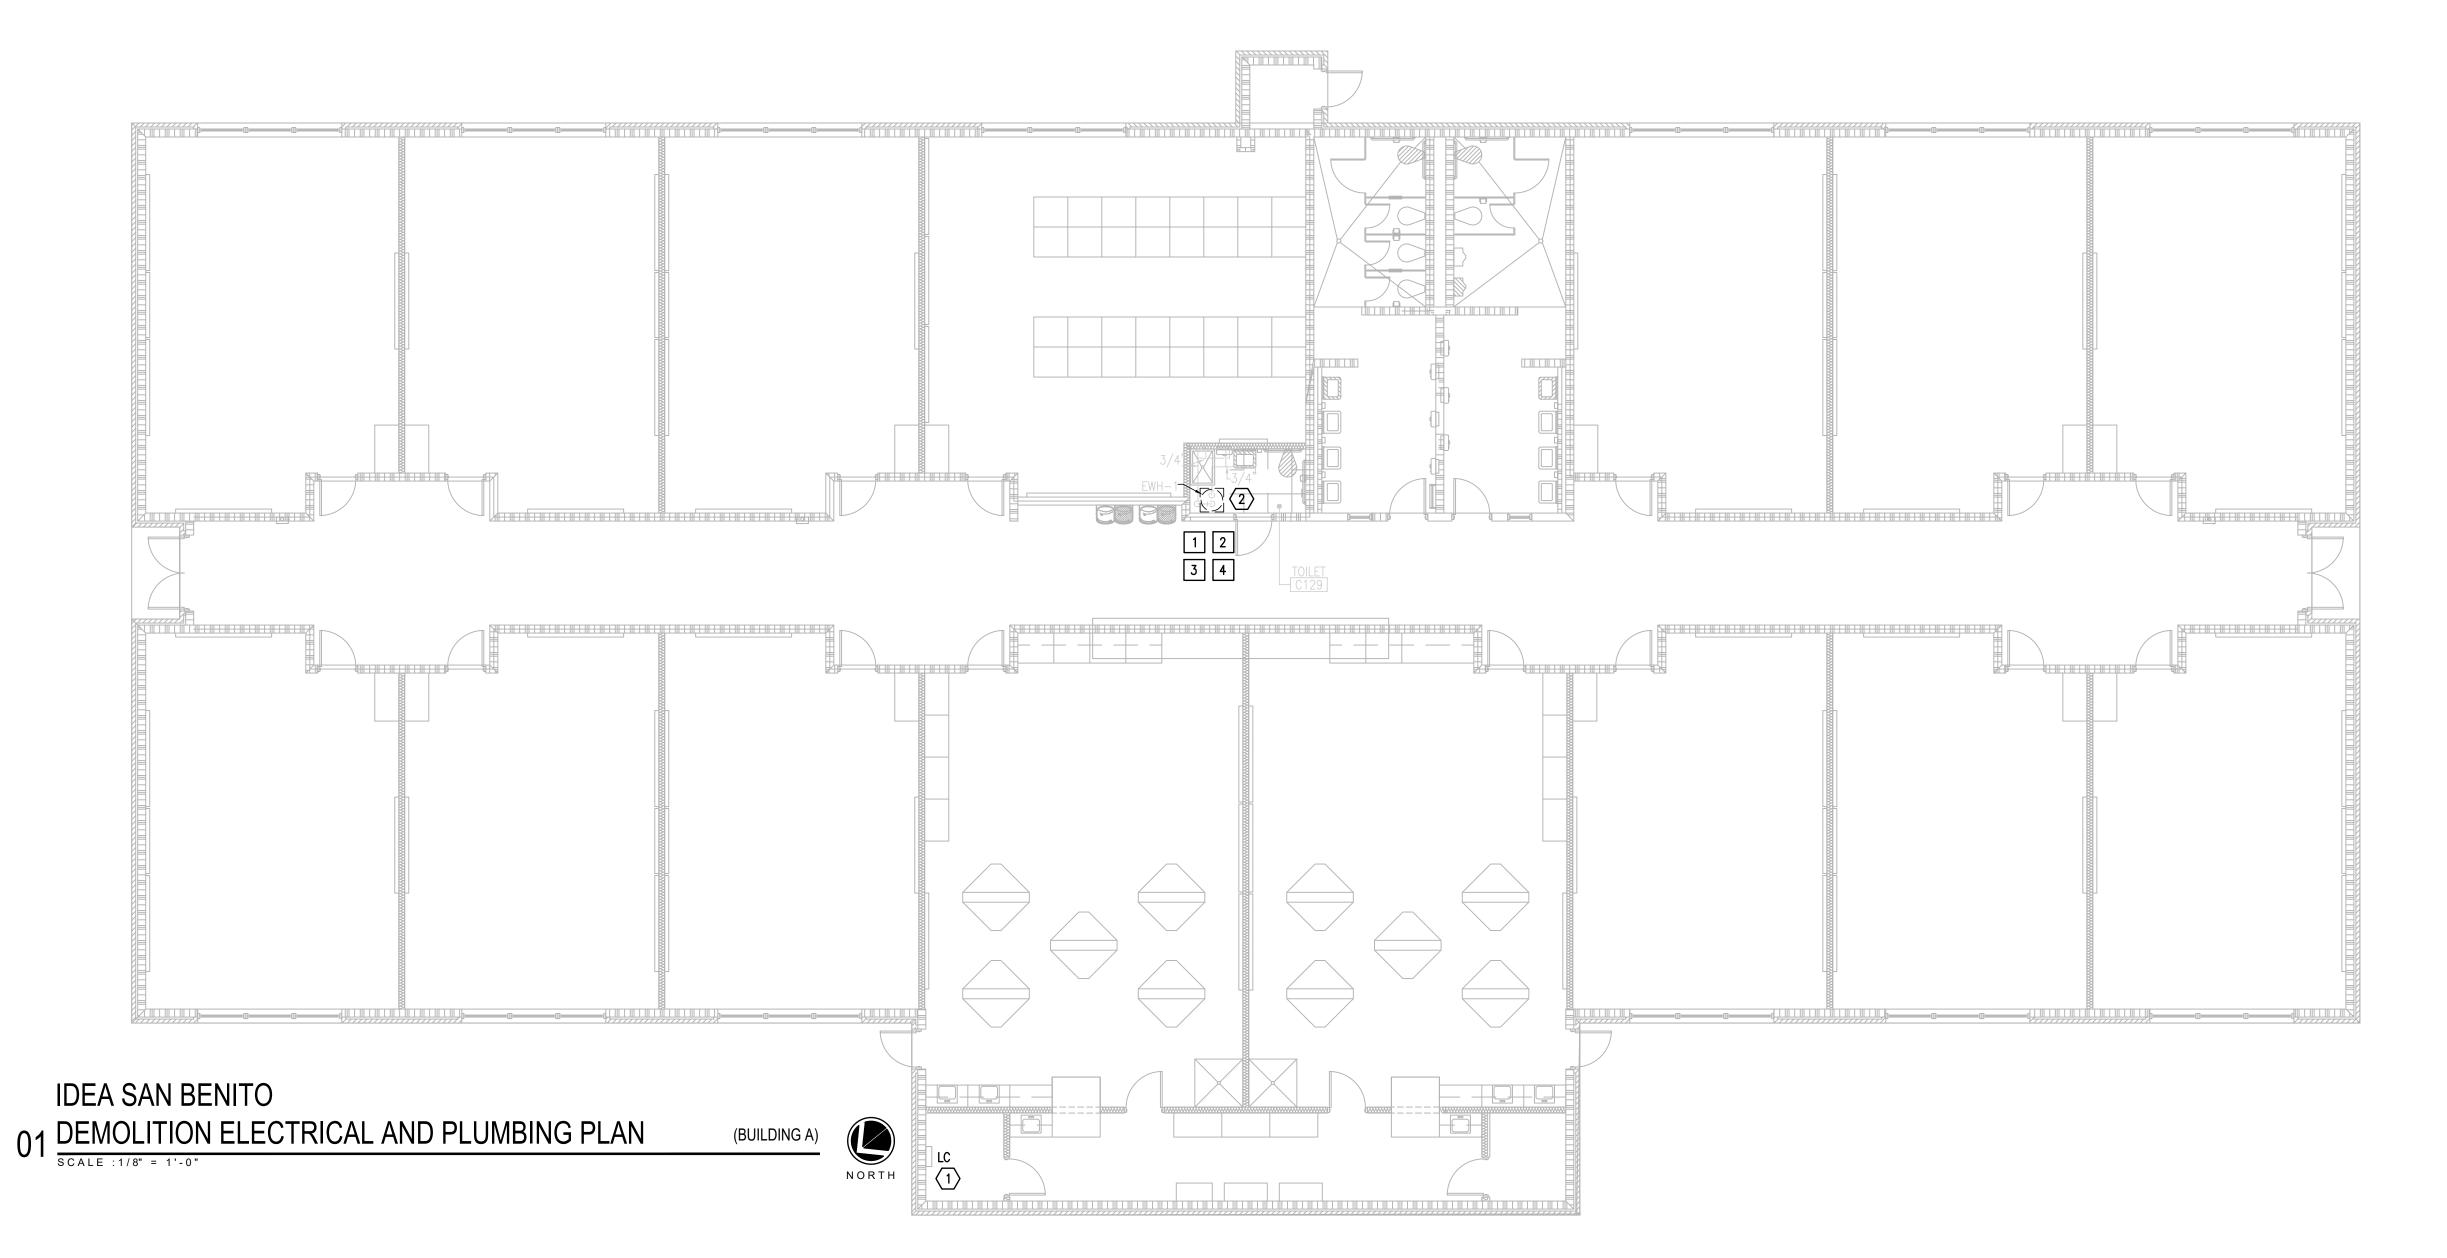

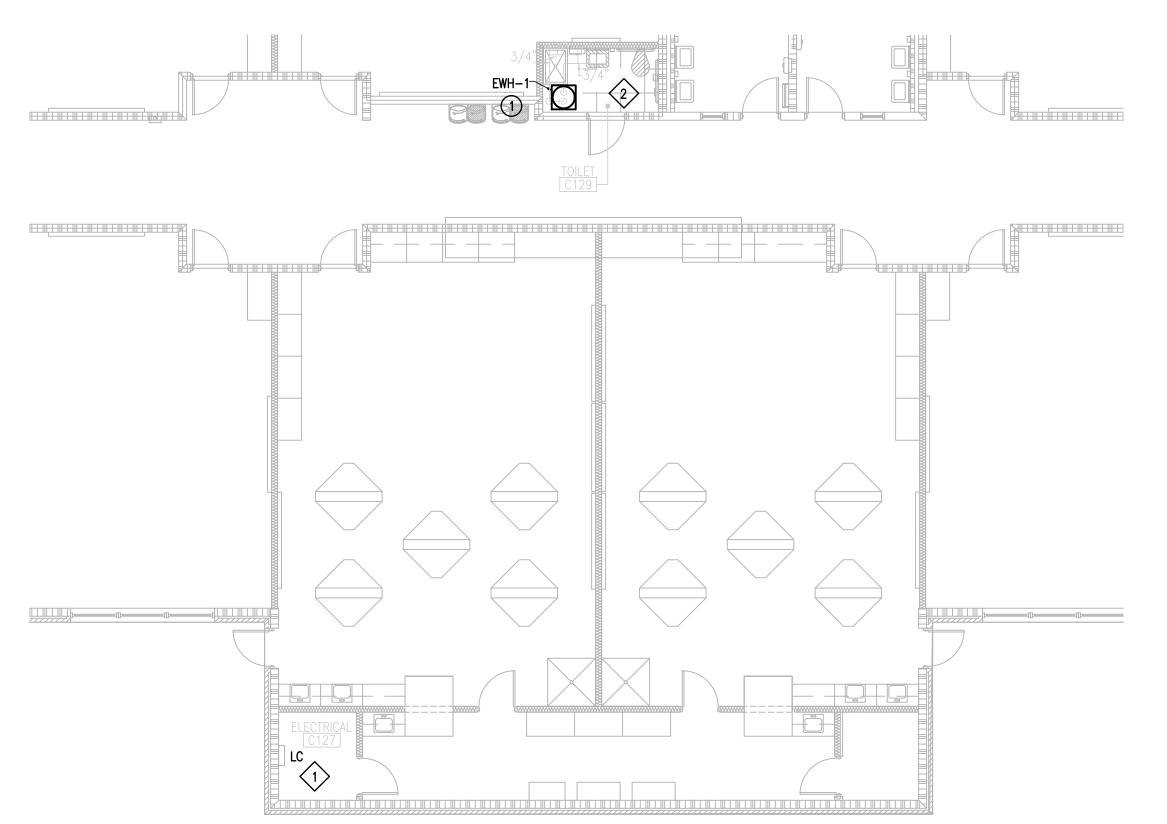

**IDEA SAN BENITO** 02 NEW ELECTRICAL PLUMBING PLAN
SCALE: 1/8" = 1'-0"

(BUILDING A)

NORTH

## **DEMOLITION GENERAL NOTES:**

- 1. ALL DEMOLITION WORK SHALL BE DONE IN ACCORDANCE WITH ALL APPLICABLE CODES INCLUDING THOSE PUBLISHED BY OSHA.
- 2. A VISIT TO THE SITE IS REQUIRED TO PROPERLY BID THE DEMOLITION PLUMBING WORK. ALL INFORMATION SHOWN ON THE EXISTING CONSTRUCTION WILL BE REFERENCE ONLY AND WILL NEED TO BE FIELD VERIFIED BY THE CONTRACTOR.
- 3. PROVIDE ALL DEMOLITION WORK REQUIRED FOR THE REMOVAL OF EXISTING NON REUSED PLUMBING EQUIPMENT AND ASSOCIATED DEVICES. PROVIDE A COMPLETE AND OPERABLE SYSTEM UPON COMPLETION OF THE PROJECT.
- 4. COORDINATE DEMOLITION OF DIVISION 22 SYSTEM AS REQUIRED WITH ALL OTHER TRADES.
- 5. ALL EXISTING EQUIPMENT AND MATERIALS REMOVED DURING CONSTRUCTION, THAT IS NOT TO BE REUSED, SHALL BE REMOVED FROM THE JOB SITE AND PROPERLY RETURNED TO THE OWNER, IF DESIRED BY
- 6. COORDINATE WITH OWNER, AND DISPOSE OF EQUIPMENT AND MATERIALS THAT OWNER DOES NOT REMAIN.
- 7. PREPARE AREA FOR INSTALLATION OF NEW PLUMBING SYSTEMS. REFER TO NEW PLANS AND COORDINATE WITH DEMOLITION WORK.
- 8. PLUMBING CONTRACTOR SHALL ISOLATE DOMESTIC COLD AND HOT WATER SYSTEM AT THE WORKING AREAS PRIOR ANY WORK BEING DONE.

### **GENERAL NOTES:**

- 1. PLUMBING CONTRACTOR SHALL ISOLATE DOMESTIC COLD WATER SYSTEM AT THE WORKING AREAS PRIOR ANY WORK BEING DONE.
- 2. PLUMBING CONTRACTOR SHALL PERFORM ALL WORK CAREFULLY TO NOT DAMAGE BUILDING FACADE/STRUCTURE.

## **DEMOLITION** PLUMBING KEYED NOTES:

- 1 DEMOLISH EXISTING ELECTRIC WATER HEATER AT THIS APPROXIMATE LOCATION.
- 2 ISOLATE AND DISCONNECT EXISTING COLD AND HOT WATER PIPES SERVING PLUMBING FIXTURE AT THIS APPROXIMATE LOCATION. CONNECT AFTER REPLACING.
- 3 DEMOLISH EXISTING PLUMBING FIXTURES MARKED ON PLANS.
- 4 PREPARE AREA FOR INSTALLATION OF NEW PLUMBING FIXTURES. COORDINATE WITH DEMOLITION.

## PLUMBING KEYED NOTES:

1) PROVIDE NEW ELECTRIC WATER HEATER EWH-1 AS PER SCHEDULE UNDER SCHEDULE SHEET P6.05 OR AN APPROVED EQUAL. ADJUST PLUMBING LINES AND FITTINGS TO THE NEW PLUMBING FIXTURE AS NECESSARY. REFER TO DETAIL ON DETAIL SHEET P5.11.




## **DEMOLITION** ELECTRICAL KEYED NOTES:


- APPROXIMATE LOCATION OF EXISTING PANELBOARD SERVING ELECTRIC WATER HEATER.
- DISCONNECT EXISTING ELECTRIC WATER HEATER FOR INSTALLATION OF NEW ELECTRIC WATER HEATER. RETAIN AND REUSE EXISTING BRANCH CIRCUIT.

## **ELECTRICAL NEW KEYED NOTES:**

- APPROXIMATE LOCATION OF EXISTING PANELBOARD SERVING ELECTRIC WATER HEATER.
- 2 CONNECT NEW ELECTRIC WATER HEATER. RETAIN AND REUSE EXISTING BRANCH CIRCUIT. IF EXISTING BRANCH CIRCUIT DOES NOT REACH NEW POINT OF CONNECTION PROVIDE A J-BOX AND EXTEND WIRING AS

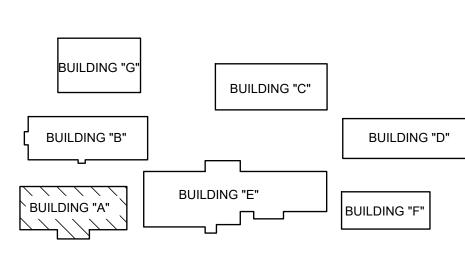

SAN BENITO IDEA ACADEMY KEYPLAN

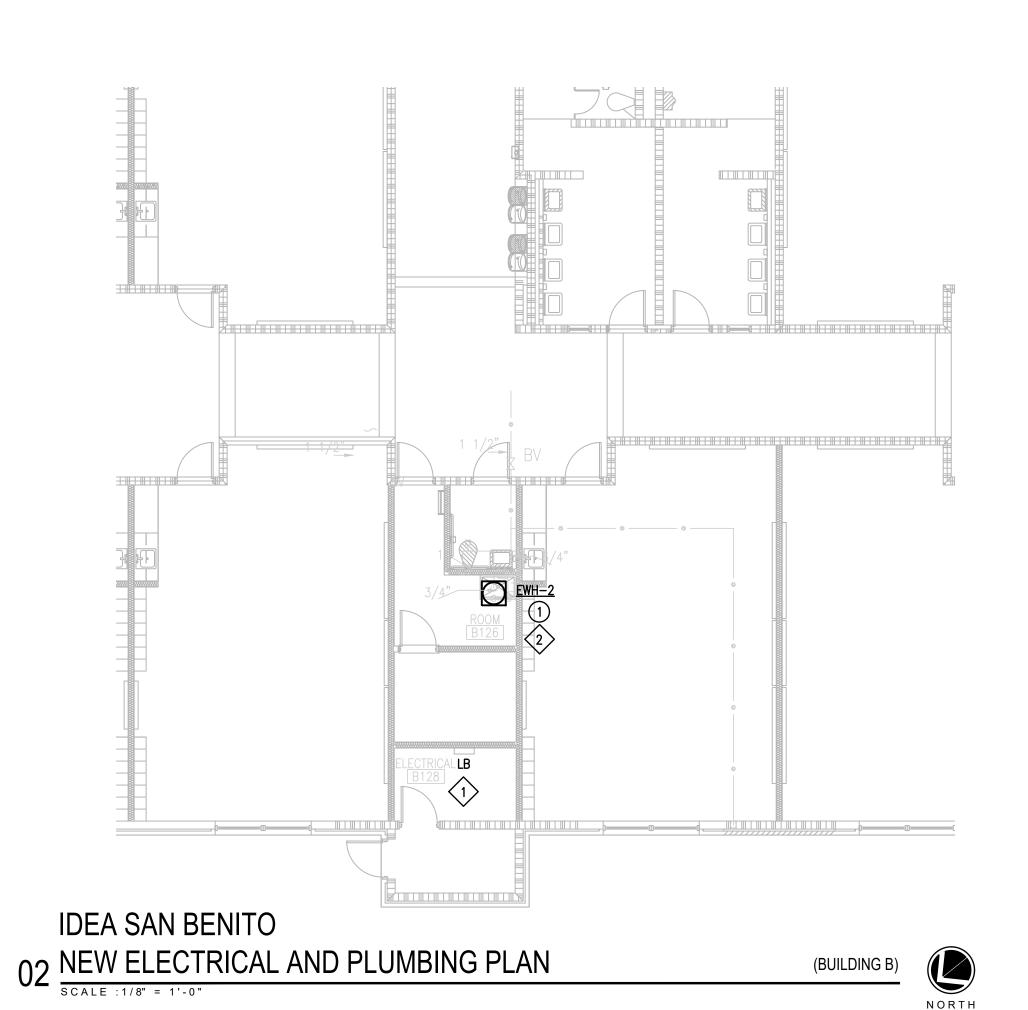

### **DEMOLITION GENERAL NOTES:**

- 1. ALL DEMOLITION WORK SHALL BE DONE IN ACCORDANCE WITH ALL APPLICABLE CODES INCLUDING THOSE PUBLISHED BY OSHA.
- 2. A VISIT TO THE SITE IS REQUIRED TO PROPERLY BID THE DEMOLITION PLUMBING WORK. ALL INFORMATION SHOWN ON THE EXISTING CONSTRUCTION WILL BE REFERENCE ONLY AND WILL NEED TO BE FIELD VERIFIED BY THE CONTRACTOR.
- 3. PROVIDE ALL DEMOLITION WORK REQUIRED FOR THE REMOVAL OF EXISTING NON REUSED PLUMBING EQUIPMENT AND ASSOCIATED DEVICES. PROVIDE A COMPLETE AND OPERABLE SYSTEM UPON COMPLETION OF THE PROJECT.
- 4. COORDINATE DEMOLITION OF DIVISION 22 SYSTEM AS REQUIRED WITH ALL OTHER TRADES.
- 5. ALL EXISTING EQUIPMENT AND MATERIALS REMOVED DURING CONSTRUCTION, THAT IS NOT TO BE REUSED, SHALL BE REMOVED FROM THE JOB SITE AND PROPERLY RETURNED TO THE OWNER, IF DESIRED BY
- COORDINATE WITH OWNER, AND DISPOSE OF EQUIPMENT AND MATERIALS THAT OWNER DOES NOT REMAIN.
- 7. PREPARE AREA FOR INSTALLATION OF NEW PLUMBING SYSTEMS. REFER TO NEW PLANS AND COORDINATE WITH DEMOLITION WORK.
- 8. PLUMBING CONTRACTOR SHALL ISOLATE DOMESTIC COLD AND HOT WATER SYSTEM AT THE WORKING AREAS PRIOR ANY WORK BEING DONE.

### **GENERAL NOTES:**

- 1. PLUMBING CONTRACTOR SHALL ISOLATE DOMESTIC COLD WATER SYSTEM AT THE WORKING AREAS PRIOR ANY WORK BEING DONE.
- 2. PLUMBING CONTRACTOR SHALL PERFORM ALL WORK CAREFULLY TO NOT DAMAGE BUILDING FACADE/STRUCTURE.

## **DEMOLITION** PLUMBING KEYED NOTES:

- 1 DEMOLISH EXISTING ELECTRIC WATER HEATER AT THIS APPROXIMATE LOCATION.
- 2 ISOLATE AND DISCONNECT EXISTING COLD AND HOT WATER PIPES SERVING PLUMBING FIXTURE AT THIS APPROXIMATE LOCATION. CONNECT AFTER REPLACING.
- 3 DEMOLISH EXISTING PLUMBING FIXTURES MARKED ON PLANS.
- 4 PREPARE AREA FOR INSTALLATION OF NEW PLUMBING FIXTURES. COORDINATE WITH DEMOLITION.

## PLUMBING KEYED NOTES:

1) PROVIDE NEW ELECTRIC WATER HEATER EWH-2 AS PER SCHEDULE UNDER SCHEDULE SHEET P6.05 OR AN APPROVED EQUAL. ADJUST PLUMBING LINES AND FITTINGS TO THE NEW PLUMBING FIXTURE AS NECESSARY. REFER TO DETAIL ON DETAIL SHEET P5.11.




## DEMOLITION **ELECTRICAL KEYED NOTES:**

- APPROXIMATE LOCATION OF EXISTING PANELBOARD SERVING ELECTRIC WATER HEATER.
- DISCONNECT EXISTING ELECTRIC WATER HEATER FOR INSTALLATION OF NEW ELECTRIC WATER HEATER. RETAIN AND REUSE EXISTING BRANCH

## **ELECTRICAL NEW KEYED NOTES:**

- APPROXIMATE LOCATION OF EXISTING PANELBOARD SERVING ELECTRIC WATER HEATER.
- 2 CONNECT NEW ELECTRIC WATER HEATER. RETAIN AND REUSE EXISTING BRANCH CIRCUIT. IF EXISTING BRANCH CIRCUIT DOES NOT REACH NEW POINT OF CONNECTION PROVIDE A J-BOX AND EXTEND WIRING AS

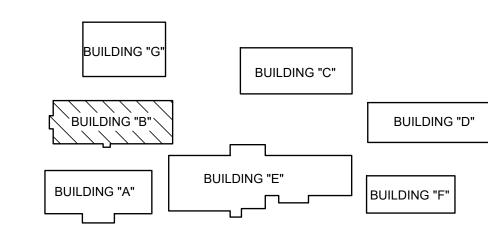

SAN BENITO IDEA ACADEMY KEYPLAN

NO: REVISION: BY

COPY NO: CSP # 27-LRPU-0424



ADE 0 0 UB 귑 **D** 9 



DRAWN BY: PROJECT NO.: P6.02

1 REMOVE, STORE AND RE-INSTALL FLOOR SINK GRATE AFTER COMPLETING WORK.

PROVIDE NEW TRAP SEAL FOR EXISTING FLOOR SINK AT THIS APPROXIMATE LOCATION. ENSURE TO PROVIDE APPROPRIATE SIZE TO FIT INTO EXISTING PIPING. REFER TO SCHEDULE ON SHEET P6.05.

PLUMBING KEYED NOTES:

COPY NO: CSP # 27-LRPU-0424


NO: REVISION: BY:



SCHOOL UMBING PUB IDE,



CAD FILE: SHEET: P6.03

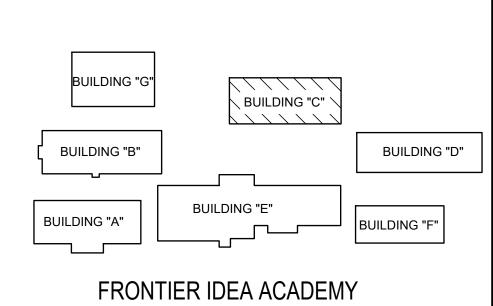

KEYPLAN

COPY NO:

CSP # 27-LRPU-0424

\*

CESAR A. GONZALEZ

108611

04.19.2023

 DATE:
 APRIL 19, 2024


 CHECKED BY:
 C.A.G.

 DRAWN BY:
 J.V.

 PROJECT NO.:
 23v82

 CAD FILE:

 SHEET:
 P6.04

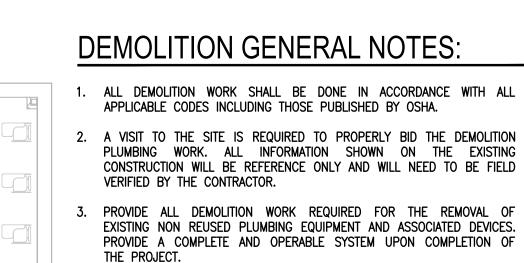

COORDINATE DEMOLITION OF DIVISION 22 SYSTEM AS REQUIRED WITH ALL OTHER TRADES.

5. ALL EXISTING EQUIPMENT AND MATERIALS REMOVED DURING CONSTRUCTION, THAT IS NOT TO BE REUSED, SHALL BE REMOVED FROM THE JOB SITE AND PROPERLY RETURNED TO THE OWNER, IF DESIRED BY

6. COORDINATE WITH OWNER, AND DISPOSE OF EQUIPMENT AND MATERIALS THAT OWNER DOES NOT REMAIN.

PREPARE AREA FOR INSTALLATION OF NEW PLUMBING SYSTEMS. REFER TO NEW PLANS AND COORDINATE WITH DEMOLITION WORK.

8. PLUMBING CONTRACTOR SHALL ISOLATE DOMESTIC COLD AND HOT WATER SYSTEM AT THE WORKING AREAS PRIOR ANY WORK BEING DONE.

## GENERAL NOTES:

- PLUMBING CONTRACTOR SHALL ISOLATE DOMESTIC COLD WATER SYSTEM AT THE WORKING AREAS PRIOR ANY WORK BEING DONE.
- 2. PLUMBING CONTRACTOR SHALL PERFORM ALL WORK CAREFULLY TO NOT DAMAGE BUILDING FACADE/STRUCTURE.

# DEMOLITION PLUMBING KEYED NOTES:

- 1 DEMOLISH EXISTING ELECTRIC WATER HEATER AT THIS APPROXIMATE LOCATION.
- 2 ISOLATE AND DISCONNECT EXISTING COLD AND HOT WATER PIPES SERVING PLUMBING FIXTURE AT THIS APPROXIMATE LOCATION. CONNECT AFTER REPLACING.
- 3 DEMOLISH EXISTING PLUMBING FIXTURES MARKED ON PLANS.
- PREPARE AREA FOR INSTALLATION OF NEW PLUMBING FIXTURES. COORDINATE WITH DEMOLITION.

## PLUMBING KEYED NOTES:

1 PROVIDE NEW ELECTRIC WATER HEATER EWH—3 AS PER SCHEDULE UNDER SCHEDULE SHEET P6.05 OR AN APPROVED EQUAL. ADJUST PLUMBING LINES AND FITTINGS TO THE NEW PLUMBING FIXTURE AS NECESSARY. REFER TO DETAIL ON DETAIL SHEET P5.11.




# DEMOLITION ELECTRICAL KEYED NOTES:

- APPROXIMATE LOCATION OF EXISTING PANELBOARD SERVING ELECTRIC WATER HEATER.
- DISCONNECT EXISTING ELECTRIC WATER HEATER FOR INSTALLATION OF NEW ELECTRIC WATER HEATER. RETAIN AND REUSE EXISTING BRANCH

## ELECTRICAL NEW KEYED NOTES:

- APPROXIMATE LOCATION OF EXISTING PANELBOARD SERVING ELECTRIC WATER HEATER.
- 2 CONNECT NEW ELECTRIC WATER HEATER. RETAIN AND REUSE EXISTING BRANCH CIRCUIT. IF EXISTING BRANCH CIRCUIT DOES NOT REACH NEW POINT OF CONNECTION PROVIDE A J-BOX AND EXTEND WIRING AS NECESSARY.

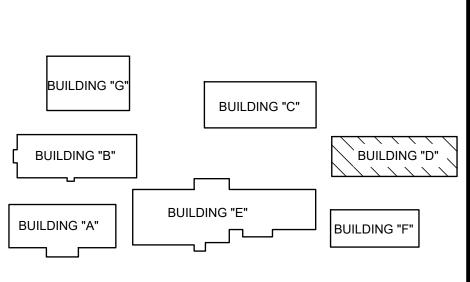


FRONTIER IDEA ACADEMY KEYPLAN



**IDEA SAN BENITO** 

01 DEMOLITION ELECTRICAL AND PLUMBING PLAN



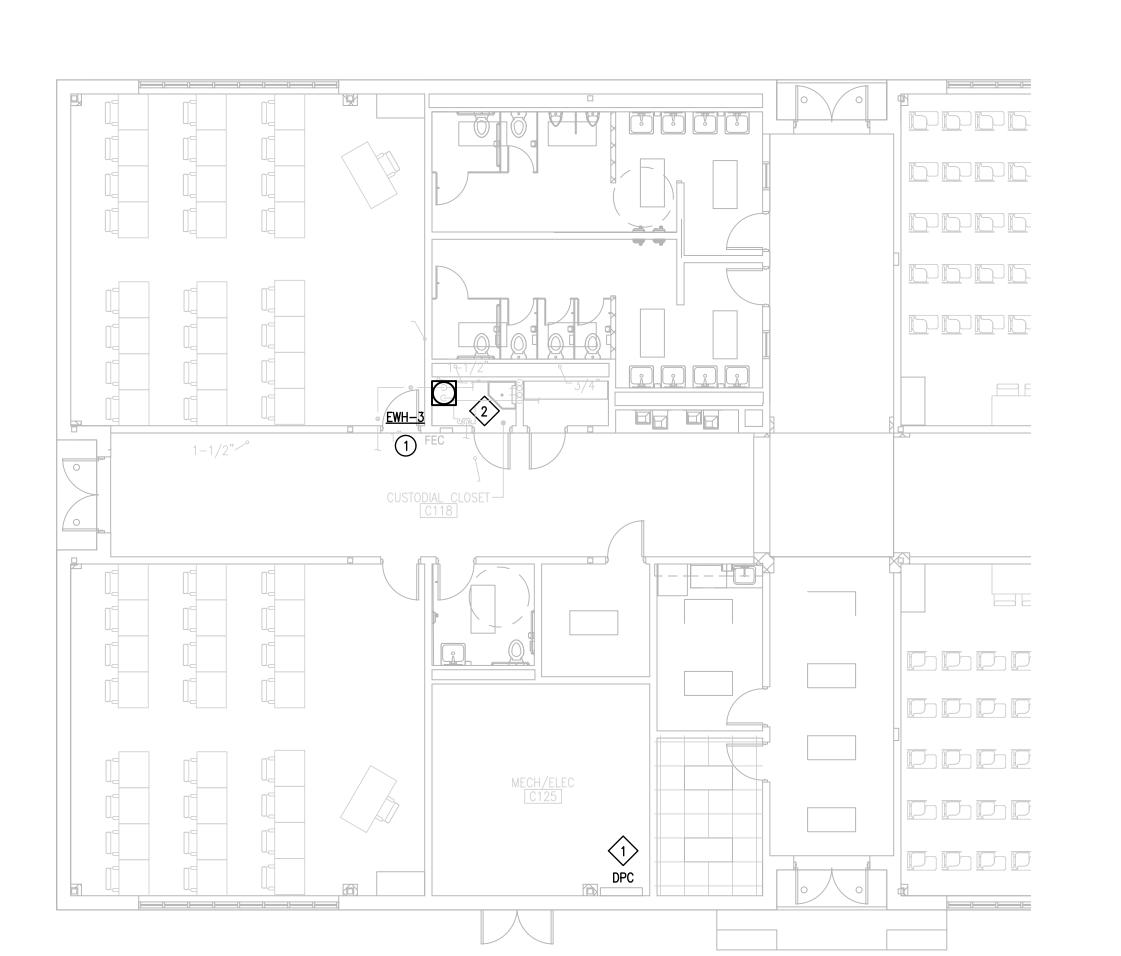

IDEA SAN BENITO

02 NEW ELECTRICAL AND PLUMBING PLAN

(BUILDING D)



| PLUMBING FIXTURE SCHEDUL |
|--------------------------|
|--------------------------|

| Project: II | DEA PS PLUMBING UPGRADES A | AT LOWER RGV CAMPUSES   |       |      |    |    |       |         |
|-------------|----------------------------|---|-------|------|----|----|-------|---------|
|             | MANUFACTURER &             | MANUFACTURER & CONNECTIONS  |       |      |    |    |       |         |
| MARK        | MODEL NUMBER               | DESCRIPTION   | WASTE | VENT | CW | HW | NOTES | REMARKS |
| TS-1        | ZURN 1072                  | TRAP SEAL DEVICE FOR USE WITH FLOOR DRAINS TO MINIMIZE TRAP EVAPORATION. PRODUCT IS COMPRISED OF AN ABS RIGID STRUCTURE, SILCONE GASKET AND SEAL FOR 2" [51 MM], 3" [76 MM], 3-1/2" [89 MM], AND 4" [102 MM] SIZES. DEVICE IS ENGINEERED TO COMPLY WITH THE PERFORMANCE REQUIREMENTS OF ASSE 1072 STANDARD AND IS THIRD PARTY LISTED WITH IAPMO (UPC), ICC (ICC CES PMG) AND ASSE | 3"    | -    | -  | -  | -     |         |

|  | ELECTRIC WATER HEATER SCHEDULE  Project: IDEA PS PLUMBING UPGRADES AT LOWER RGV CAMPUSES |           |           |                       |   |                       |                                  |                 |                         |       |  |  |  |
|--|--|-----------|-----------|-----------------------|---|-----------------------|----------------------------------|-----------------|-------------------------|-------|--|--|--|
|  |  |           |           |                       |   |                       |                                  |                 |                         |       |  |  |  |
|  | MARK   | LOCATION  | SERVING   | GALLON<br>CAPACITY KW |   | NUMBER<br>OF ELEMENTS | RECOVERY IN GPH<br>AT 120°F RISE | ELECT.<br>V/P/H | MANUFACTURER<br>& MODEL | NOTES |  |  |  |
|  | EWH-1  | SEE PLANS | SEE PLANS | 6                     | 3 | 1                     | 10                               | 208/1/60        | A.O. SMITH DEL-6        | ALL   |  |  |  |
|  | EWH-2  | SEE PLANS | SEE PLANS | 6                     | 3 | 1                     | 10                               | 208/1/60        | A.O. SMITH DEL-6        | ALL   |  |  |  |
|  | EWH-3  | SEE PLANS | SEE PLANS | 6                     | 3 | 1                     | 10                               | 208/1/60        | A.O. SMITH DEL-6        | ALL   |  |  |  |

### NOTES:

- 1. MANUFACTURER & MODEL NUMBER ARE "OR APPROVED EQUAL".
- 2. PROVIDE INMERSION TYPE THERMOSTAT.







O1 EWH-1,2&3

02 TS-1

NOTE:
PROVIDE HEAT TRAP DEVICE OR AN ARRANGEMENT OF TUBING AS PER IEEC.
INSULATE THE FIRST 8' OF OUTLET PIPING AND THE INLET PIPING BETWEEN
THE STORAGE TANK AND A HEAT TRAP (INCLUDE THE HEAT TRAP).

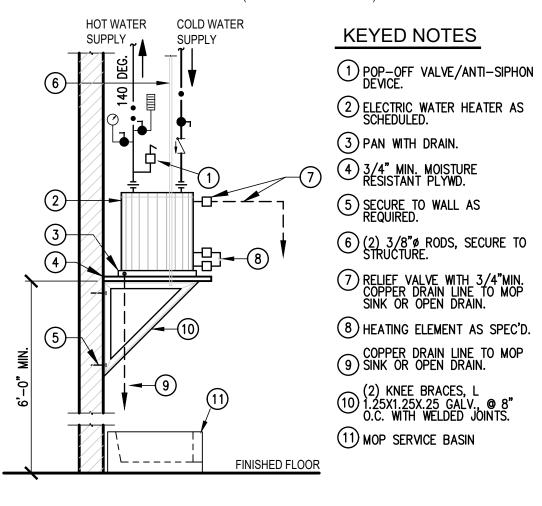

EWH-1,2&3
WALL MOUNTED
ELECTRIC WATER HEATER DETAIL
SCALE: NOT TO SCALE

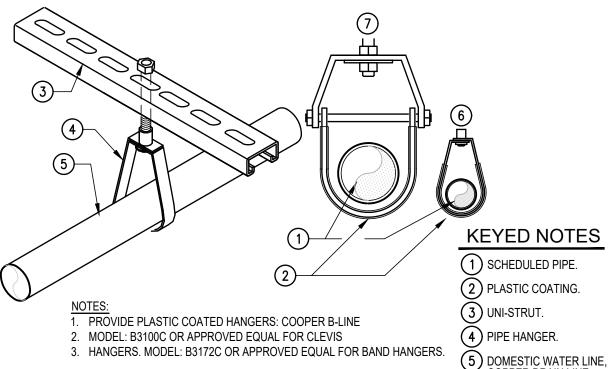

DOMESTIC WATER LINE

O4 PIPING SUPPORT DETAIL

SCALE: NOT TO SCALE

OCOPPER DRAIN LIN FROM AHU'S.

6 BAND HANGER.

7 CLEVIS HANGER.

(2) PLASTIC COATING.
(3) UNI-STRUT.
(4) PIPE HANGER.
(5) DOMESTIC WATER LINE, COPPER DRAIN LINE FROM AHU'S.
(6) BAND HANGER.
(7) CLEVIS HANGER.

IDEA PUBLIC SCHOOLS LOWER RGV PLUMBING UPGRADES

NO: REVISION: BY:

COPY NO:

CSP # 27-LRPU-0424

CESAR A. GONZALEZ

SRANDRE VALLEN



DRAWN BY: J.V.

PROJECT NO.: 23v82

CAD FILE: SHEET:


P6.05


COPY NO:

CSP # 27-LRPU-0424

CESAR A. GONZALEZ

04.19.2023

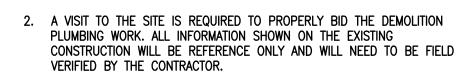

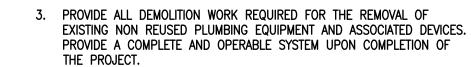


- 4. COORDINATE DEMOLITION OF DIVISION 22 SYSTEM AS REQUIRED WITH ALL OTHER TRADES.
- 5. ALL EXISTING EQUIPMENT AND MATERIALS REMOVED DURING CONSTRUCTION, THAT IS NOT TO BE REUSED, SHALL BE REMOVED FROM THE JOB SITE AND PROPERLY RETURNED TO THE OWNER, IF DESIRED BY
- 6. COORDINATE WITH OWNER, AND DISPOSE OF EQUIPMENT AND MATERIALS THAT OWNER DOES NOT REMAIN.
- 7. PREPARE AREA FOR INSTALLATION OF NEW PLUMBING SYSTEMS. REFER TO NEW PLANS AND COORDINATE WITH DEMOLITION WORK.
- 8. PLUMBING CONTRACTOR SHALL ISOLATE DOMESTIC COLD AND HOT WATER SYSTEM AT THE WORKING AREAS PRIOR ANY WORK BEING DONE.

## DEMOLITION PLUMBING KEYED NOTES:

- 1 DEMOLISH EXISTING HOT WATER CIRCULATING PUMP AT THIS APPROXIMATE LOCATION (CP-1).
- 2 DEMOLISH EXISTING THERMOSTATIC MIXING VALVE (TMV-1) AT THIS APPROXIMATE LOCATION.
- 3 DEMOLISH EXISTING LAVATORY FAUCET AT THIS APPROXIMATE LOCATION
- 4 PREPARE AREA FOR INSTALLATION OF NEW PLUMBING FIXTURES. COORDINATE WITH DEMOLITION.



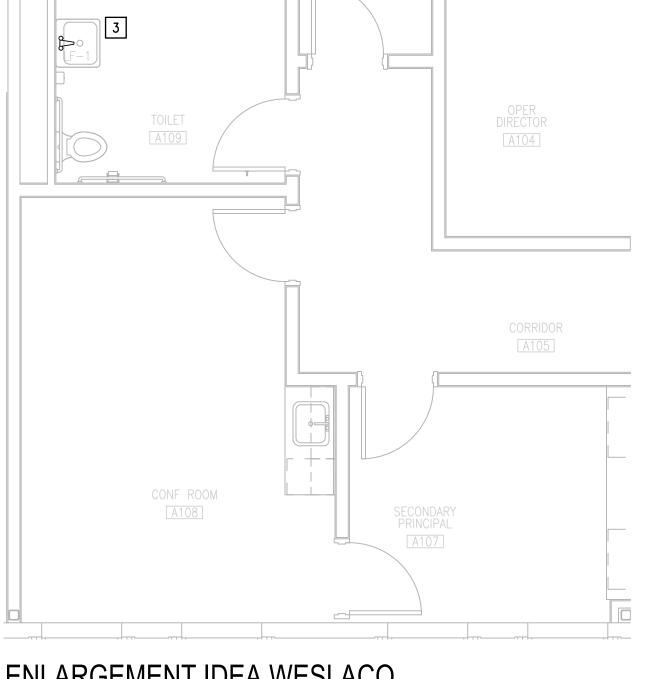




(MAIN BUILDING- 1ST FLOOR)

NORTH



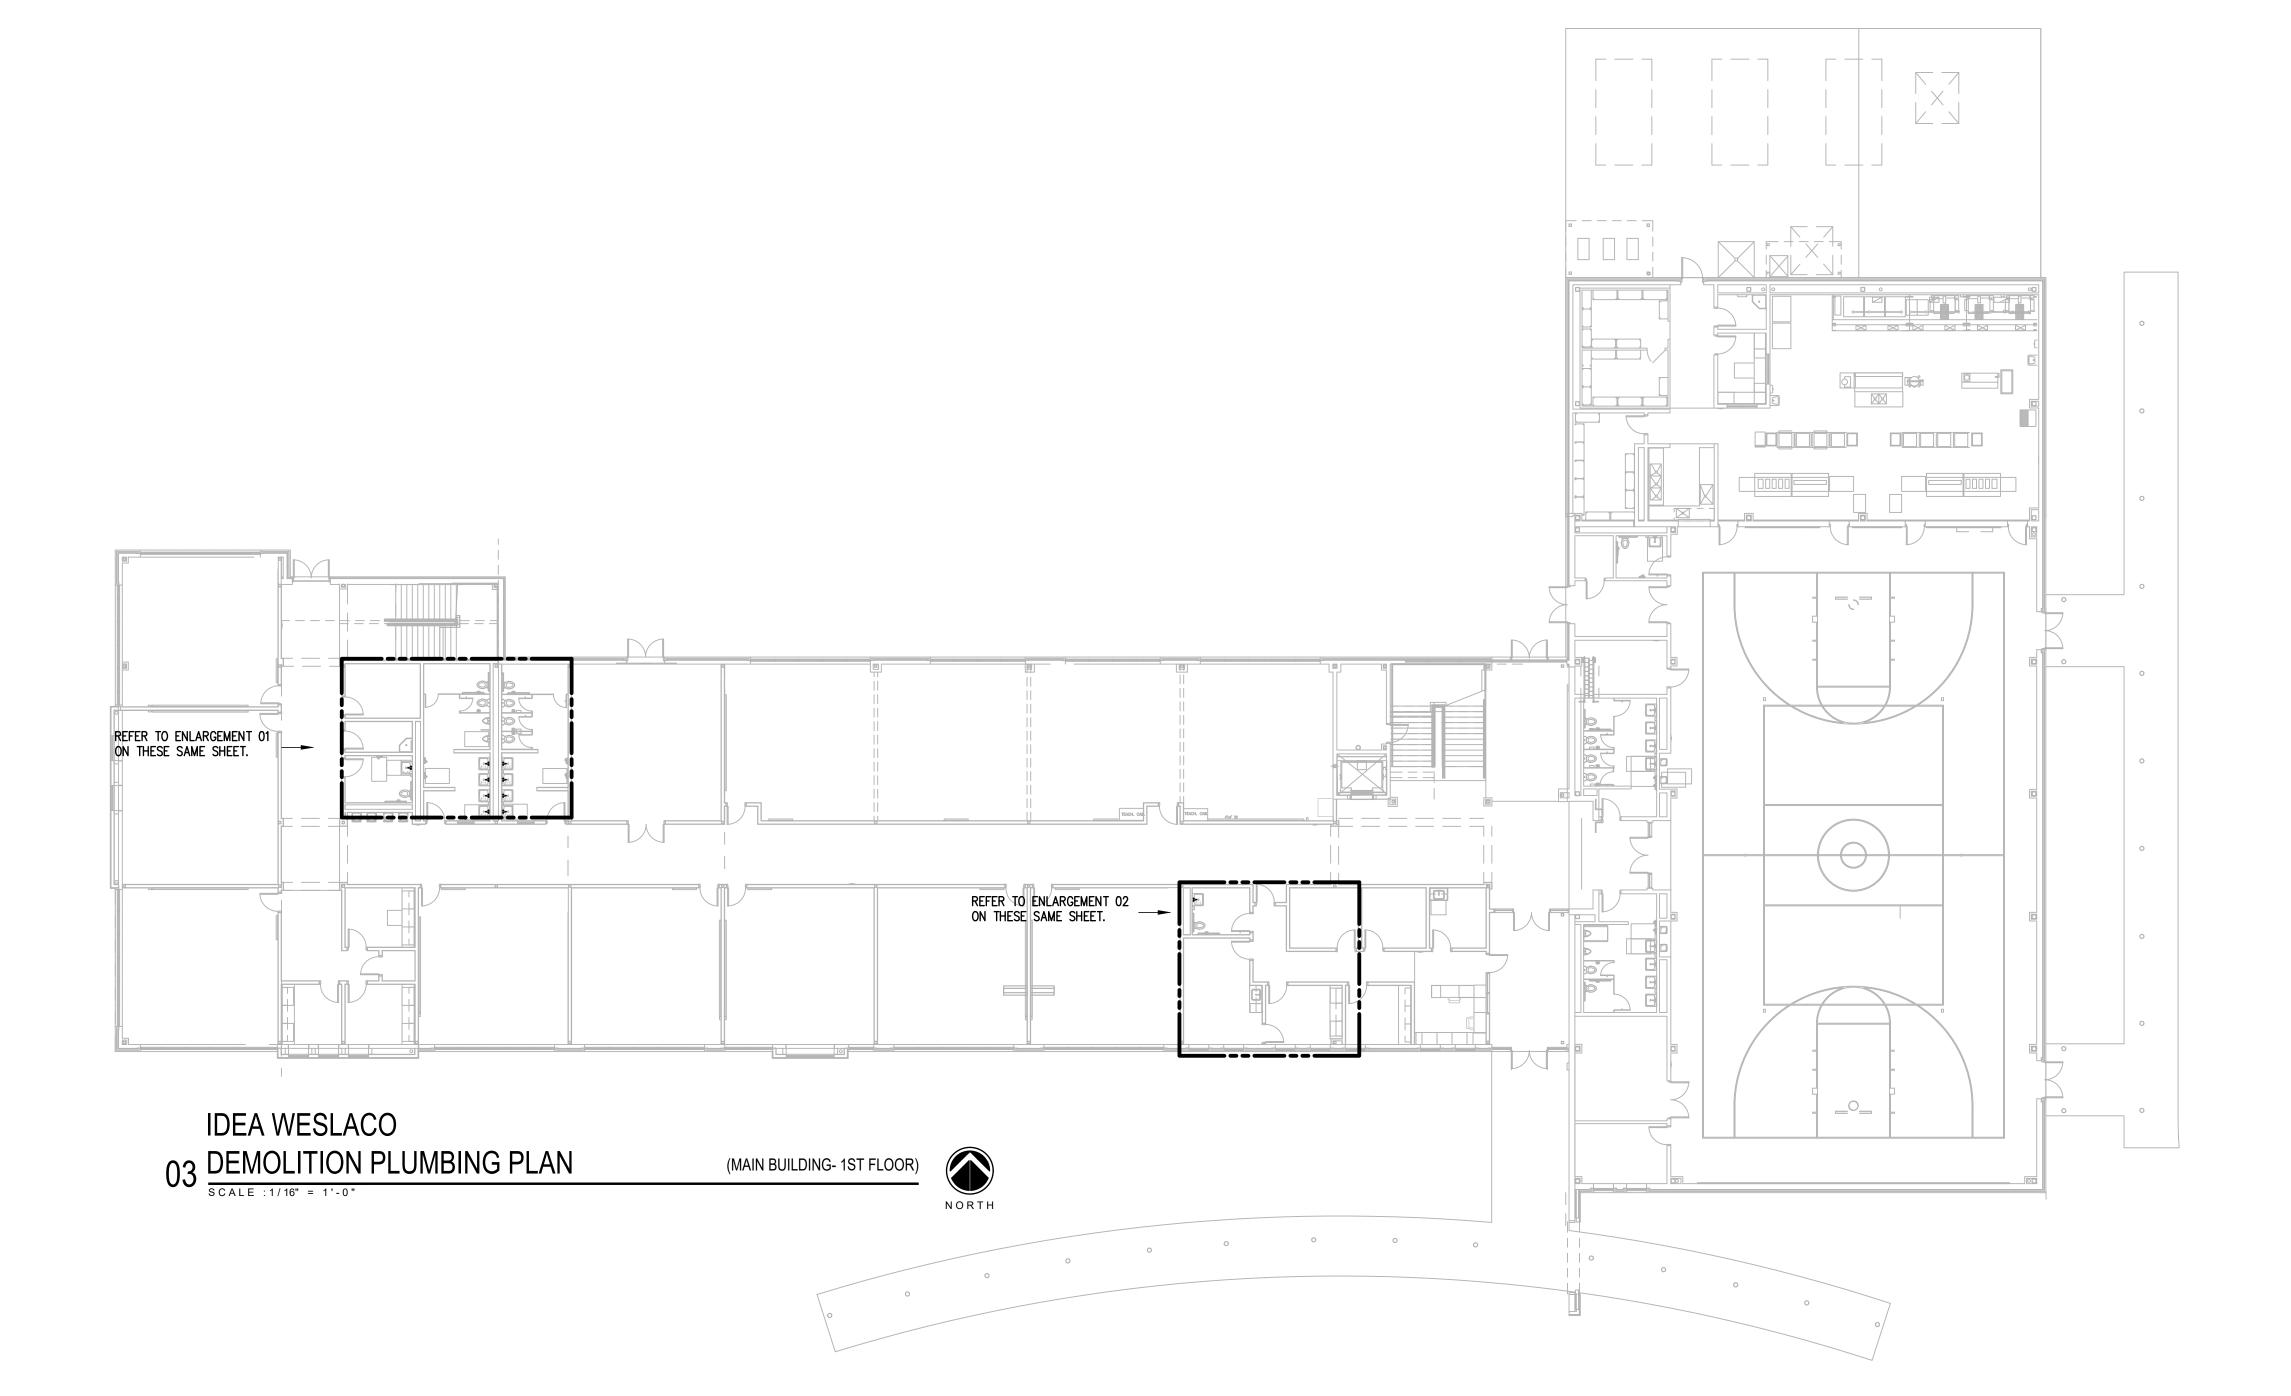


ENLARGEMENT IDEA WESLACO

(MAIN BUILDING- 1ST FLOOR)

NORTH

01 DEMOLITION PLUMBING PLAN

SCALE :1/4" = 1'-0"

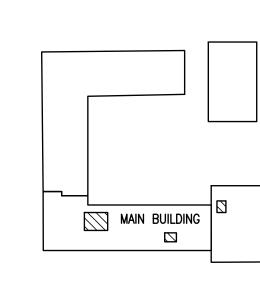

WESLACO IDEA ACADEMY KEYPLAN



1126 SOUTH COMMERCE ST. HARLINGEN, TX PHONE: 956-230-3435 TEXAS REGISTERED ENGINEERING FIRM F-15998

CHECKED BY:

PROJECT NO.:

DRAWN BY:

APRIL 19, 20

COPY NO:

CSP # 27-LRPU-0424

CESAR A. GONZALEZ

108611

04.19.2023

1126 SOUTH COMMERCE ST. HARLINGEN, TX PHONE: 956-230-3435 TEXAS REGISTERED

ENGINEERING FIRM F-15998


P7.02

CHECKED BY:

PROJECT NO.:

DRAWN BY:

APRIL 19, 20

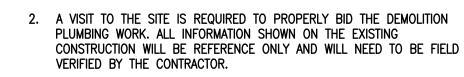

3. PROVIDE ALL DEMOLITION WORK REQUIRED FOR THE REMOVAL OF EXISTING NON REUSED PLUMBING EQUIPMENT AND ASSOCIATED DEVICES. PROVIDE A COMPLETE AND OPERABLE SYSTEM UPON COMPLETION OF THE PROJECT.

4. COORDINATE DEMOLITION OF DIVISION 22 SYSTEM AS REQUIRED WITH ALL OTHER TRADES.

5. ALL EXISTING EQUIPMENT AND MATERIALS REMOVED DURING CONSTRUCTION, THAT IS NOT TO BE REUSED, SHALL BE REMOVED FROM THE JOB SITE AND PROPERLY RETURNED TO THE OWNER, IF DESIRED BY

6. COORDINATE WITH OWNER, AND DISPOSE OF EQUIPMENT AND MATERIALS THAT OWNER DOES NOT REMAIN.

PREPARE AREA FOR INSTALLATION OF NEW PLUMBING SYSTEMS. REFER TO NEW PLANS AND COORDINATE WITH DEMOLITION WORK.

8. PLUMBING CONTRACTOR SHALL ISOLATE DOMESTIC COLD AND HOT WATER SYSTEM AT THE WORKING AREAS PRIOR ANY WORK BEING DONE.

## **DEMOLITION** PLUMBING KEYED NOTES:


- 1 DEMOLISH EXISTING HOT WATER CIRCULATING PUMP AT THIS APPROXIMATE LOCATION (CP-1).
- 2 DEMOLISH EXISTING THERMOSTATIC MIXING VALVE (TMV-1) AT THIS APPROXIMATE LOCATION.
- 3 DEMOLISH EXISTING LAVATORY FAUCET AT THIS APPROXIMATE LOCATION
- 4 PREPARE AREA FOR INSTALLATION OF NEW PLUMBING FIXTURES. COORDINATE WITH DEMOLITION.

## DEMOLITION **ELECTRICAL KEYED NOTES:**


1) APPROXIMATE LOCATION OF EXISTING PANELBOARD AT FIRST FLOOR SERVING ELECTRIC CIRCULATING PUMP.

DISCONNECT EXISTING ELECTRIC CIRCULATING PUMP FOR INSTALLATION OF NEW ELECTRIC CIRCULATING PUMP. RETAIN AND REUSE EXISTING BRANCH CIRCUIT.




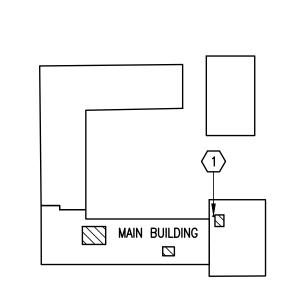



WESLACO IDEA ACADEMY **KEYPLAN** 

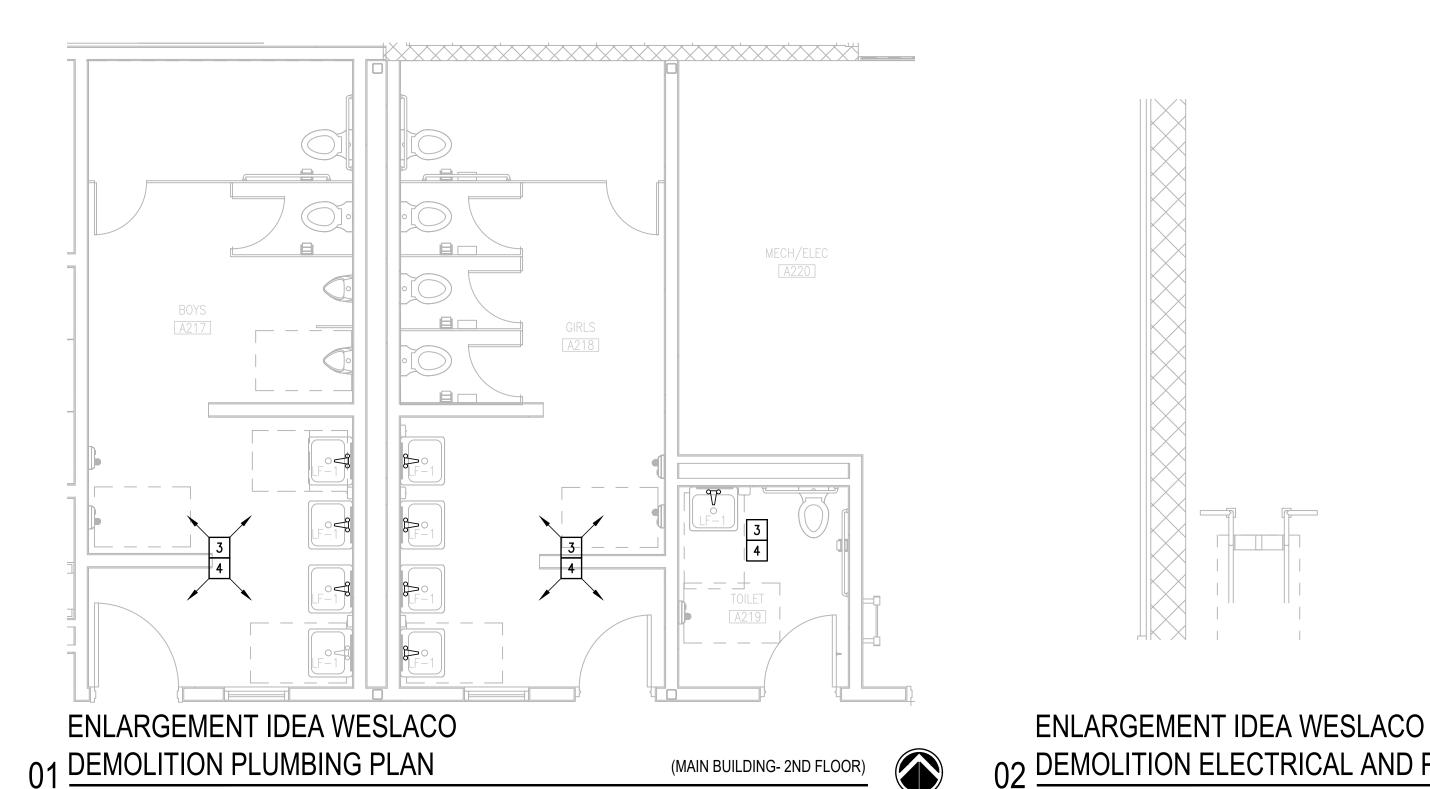

NORTH

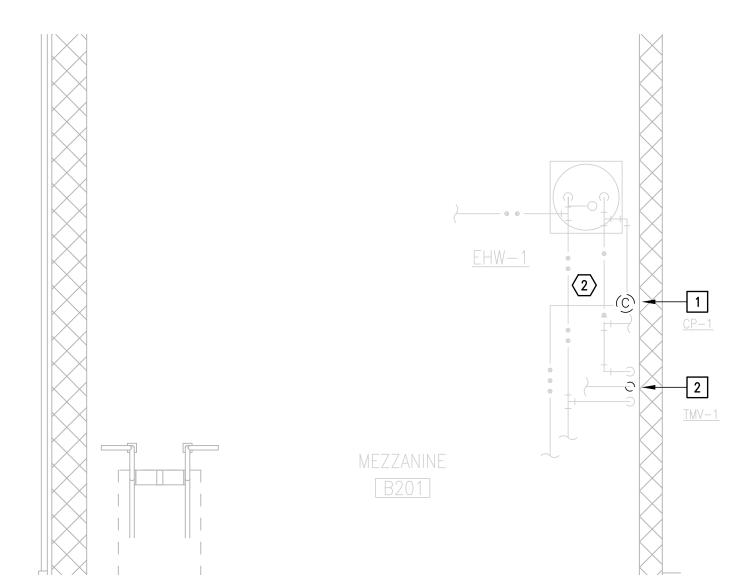

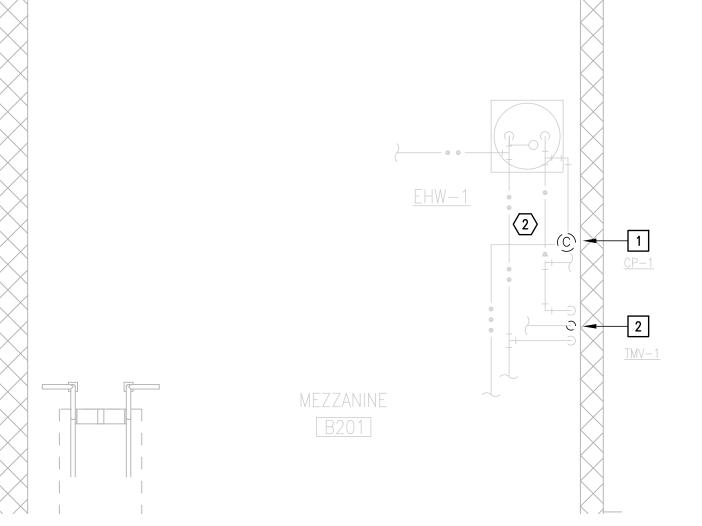

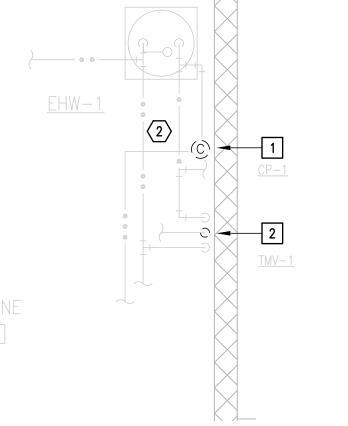







EXISTING THERMOSTATIC


MIXING VALVE TO BE REMOVED AND REPLACE.

EXISTING CIRCULATING

PUMP TO BE REMOVED

AND REPLACED.

NORTH

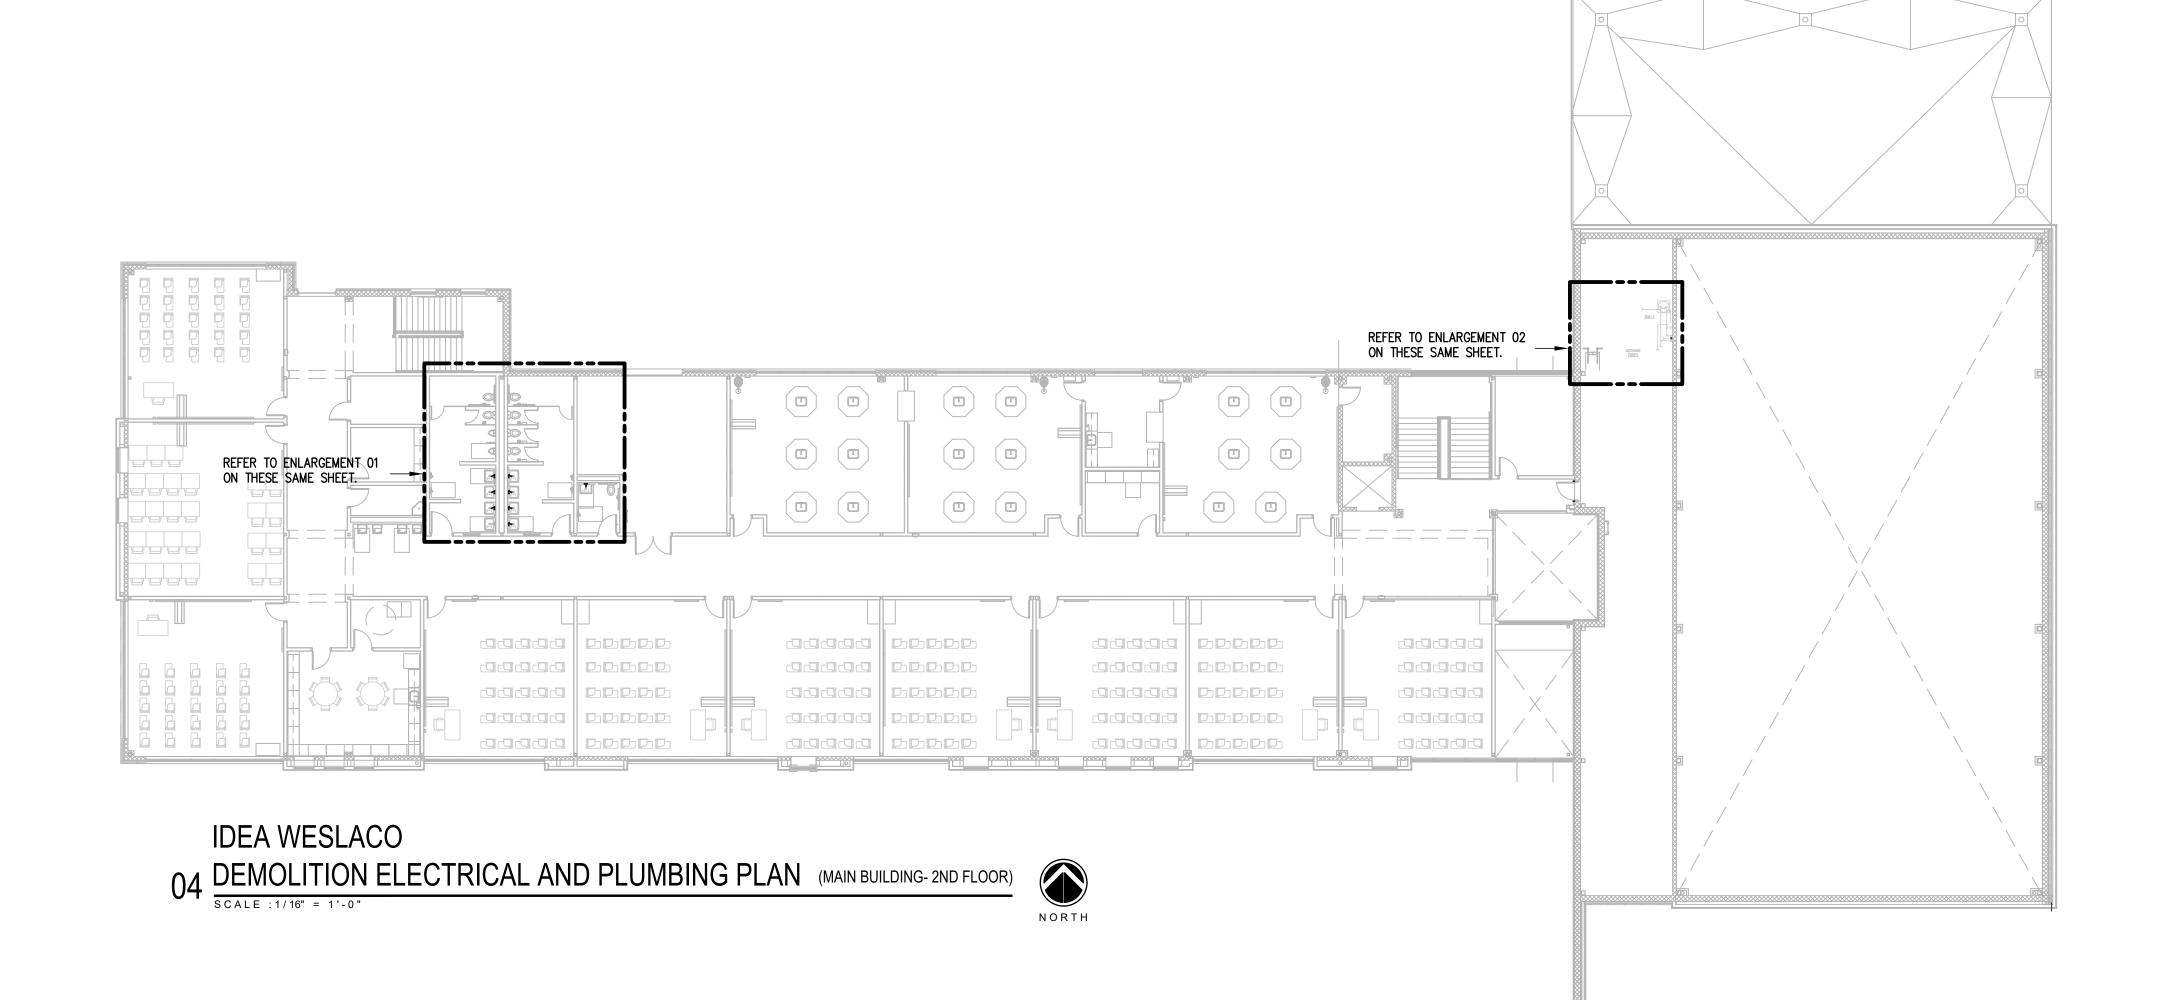

NORTH

NO: REVISION: BY:


SCHOOL UMBING PUB



P7.03



MAIN BUILDING

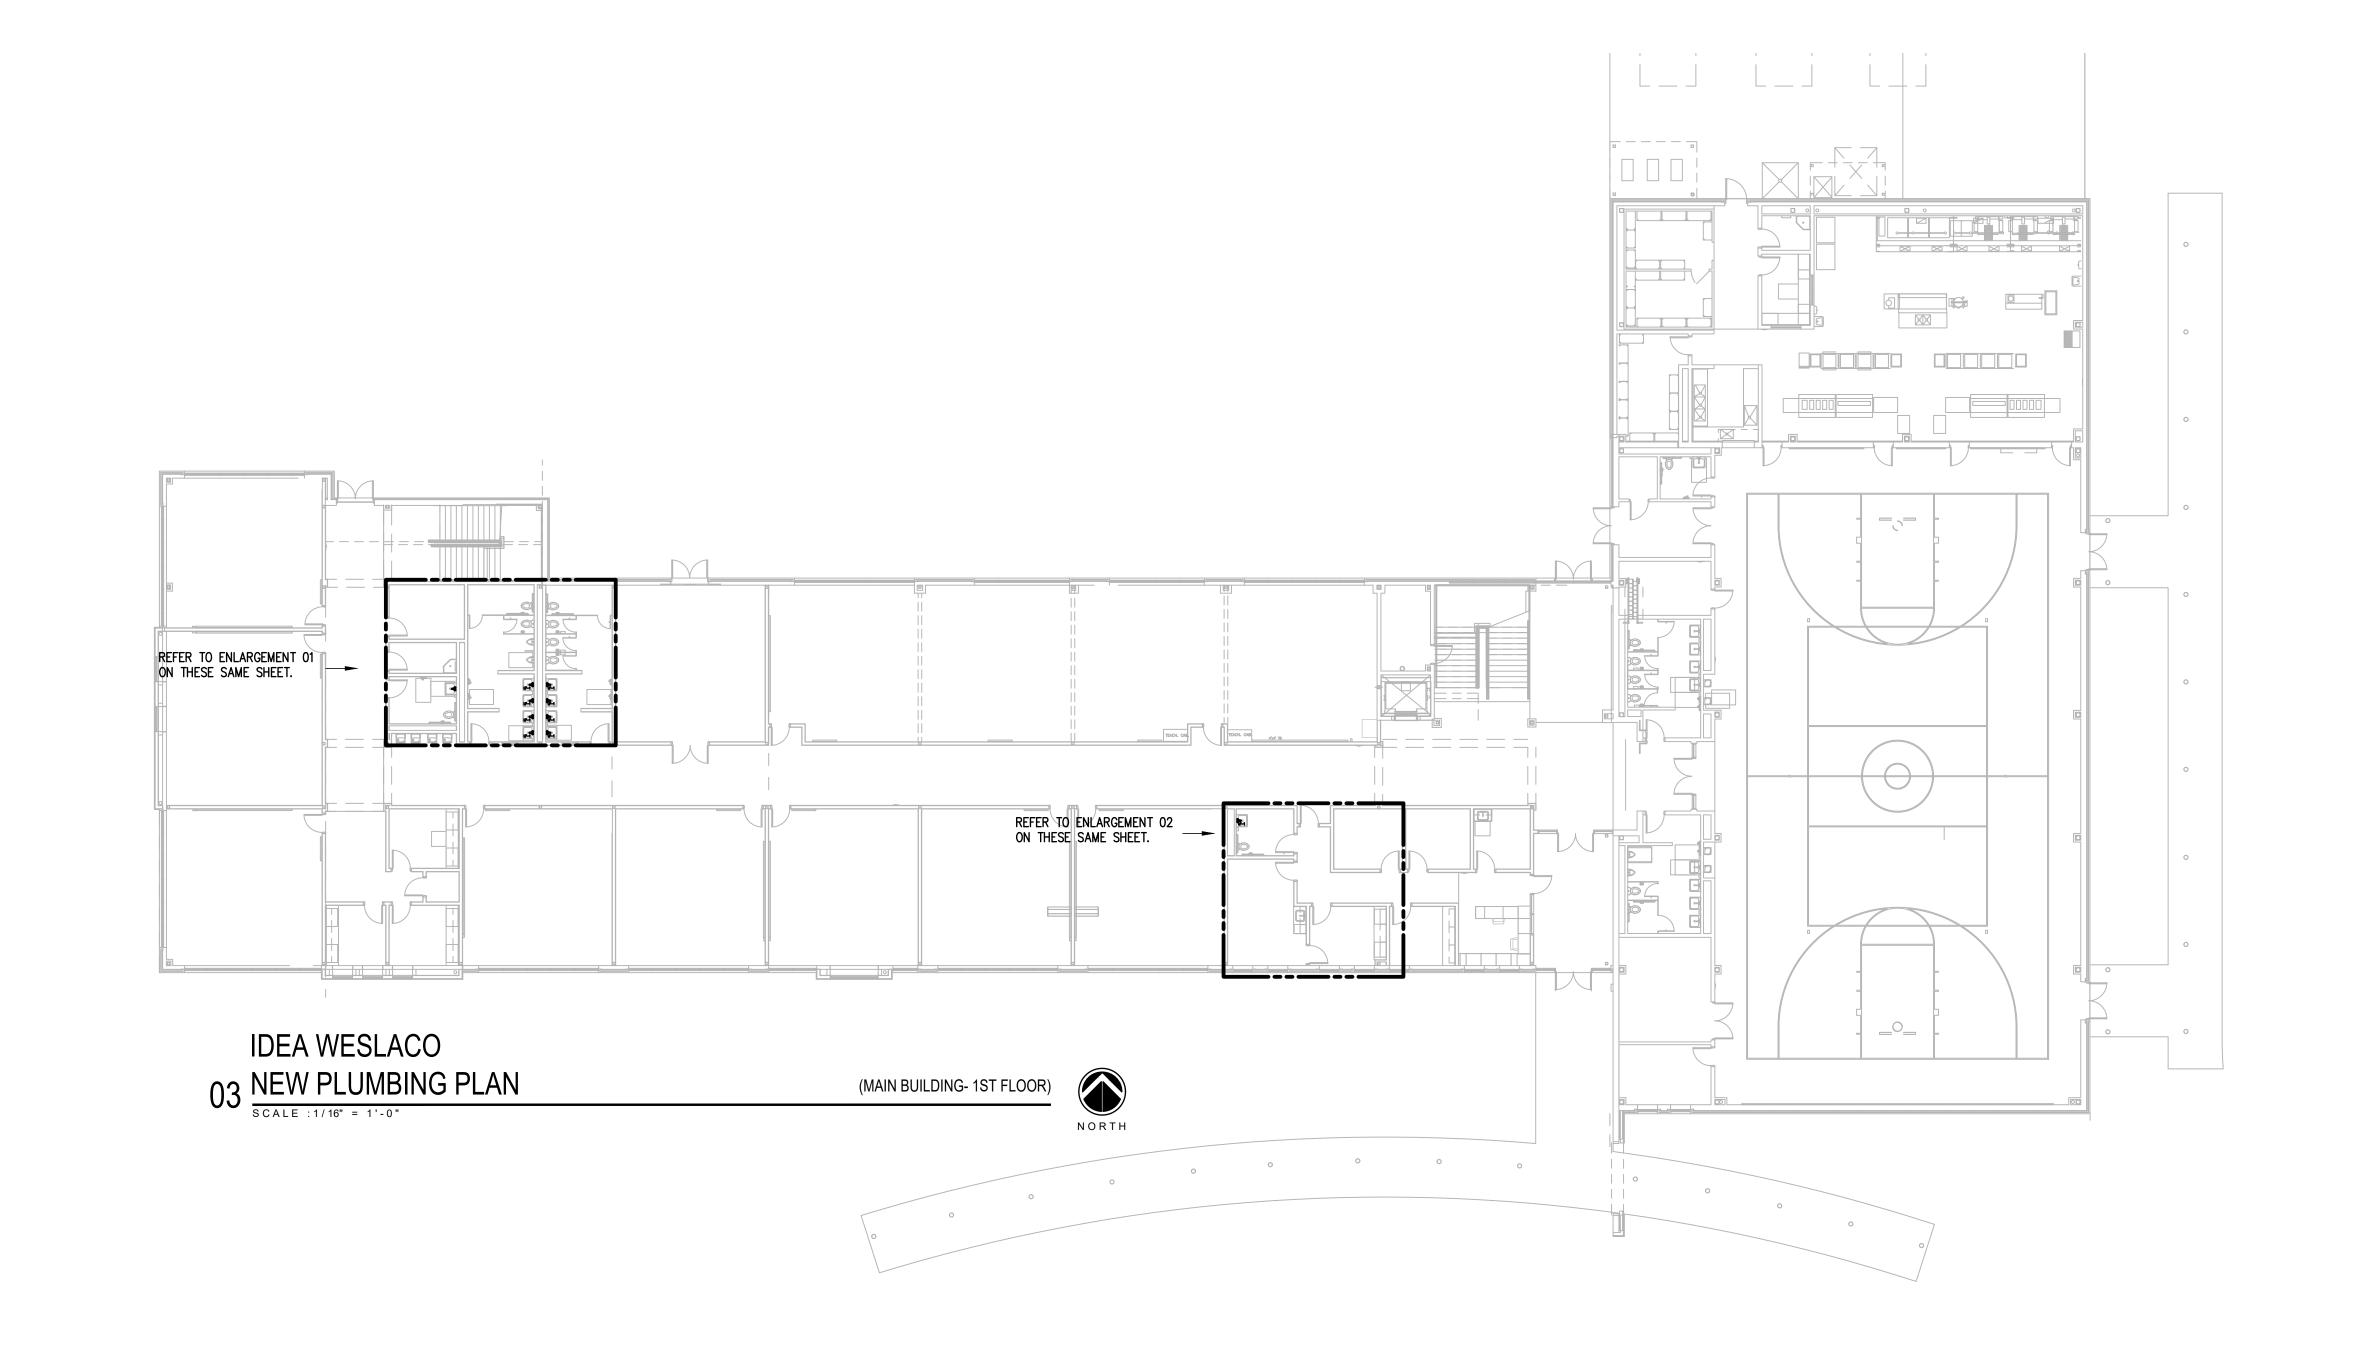

CESAR A. GONZALEZ

NO: REVISION: BY:

COPY NO:

CSP # 27-LRPU-0424

CHECKED BY: DRAWN BY: PROJECT NO.:

P7.04

PLUMBING CONTRACTOR SHALL TURN ON TEMPERED WATER SYSTEM SERVING RESTROOMS AFTER REPLACING THERMOSTATIC MIXING VALVE. CIRCULATING PUMPS AND VALVES. CONTRACTOR SHALL PROVIDE INSULATION TO ALL HOT WATER AND TEMPERED WATER PIPING AS PER SPECIFICATIONS TO THE AREAS WHERE WORK IS BEING PERFORMED.

## PLUMBING KEYED NOTES:

**GENERAL NOTES:** 

- PROVIDE NEW CIRCULATING PUMP (CP-1), AS SCHEDULED OR AN APPROVED EQUAL. SEE ASSOCIATED DETAIL ON SHEET P7.05 ADJUST PLUMBING LINES AND FITTINGS TO THE NEW PLUMBING FIXTURE AS
- PROVIDE THERMOSTATIC MIXING VALVE (TMV-1) NAVIGATOR BRADLEY MODEL: S59-2025 OR APPROVED EQUAL. ADJUST PLUMBING LINES AND FITTINGS TO NEW THERMOSTATIC MIXING VALVE AND SET TEMPERATURE TO 90 F . SEE SCHEDULE ON SHEET P7.05.
- 3 PROVIDE NEW FAUCET WITH NEW ONE INDICATED ON SCHEDULE ON SHEET P7.05. ADJUST PLUMBING LINES AND FITTINGS TO THE NEW PLUMBING FIXTURE AS NECESSARY.
- 4 PROVIDE NEW CHECK 1 1/2" CHECK VALVE AS PER SPECIFICATIONS AND INSTALL AT THIS APPROXIMATE LOCATION.

## **ELECTRICAL NEW KEYED NOTES:**

- 1 APPROXIMATE LOCATION OF EXISTING PANELBOARD AT FIRST FLOOR SERVING ELECTRIC CIRCULATING PUMP.
- 2 CONNECT NEW ELECTRIC WATER HEATER. RETAIN AND REUSE EXISTING BRANCH CIRCUIT. IF EXISTING BRANCH CIRCUIT DOES NOT REACH NEW POINT OF CONNECTION PROVIDE A J-BOX AND EXTEND WIRING AS

EXISTING THERMOSTATIC MIXING VALVE TO BE REMOVED AND REPLACE. <u>TMV-1</u> CHECK TO BE REPLACED EXISTING CIRCULATING PUMP TO BE REMOVED AND REPLACED.



NORTH

(MAIN BUILDING- 2ND FLOOR)


ENLARGEMENT IDEA WESLACO


01 DEMOLITION PLUMBING PLAN

(MAIN BUILDING- 1ST FLOOR)



03 EXISTING CONDITIONS

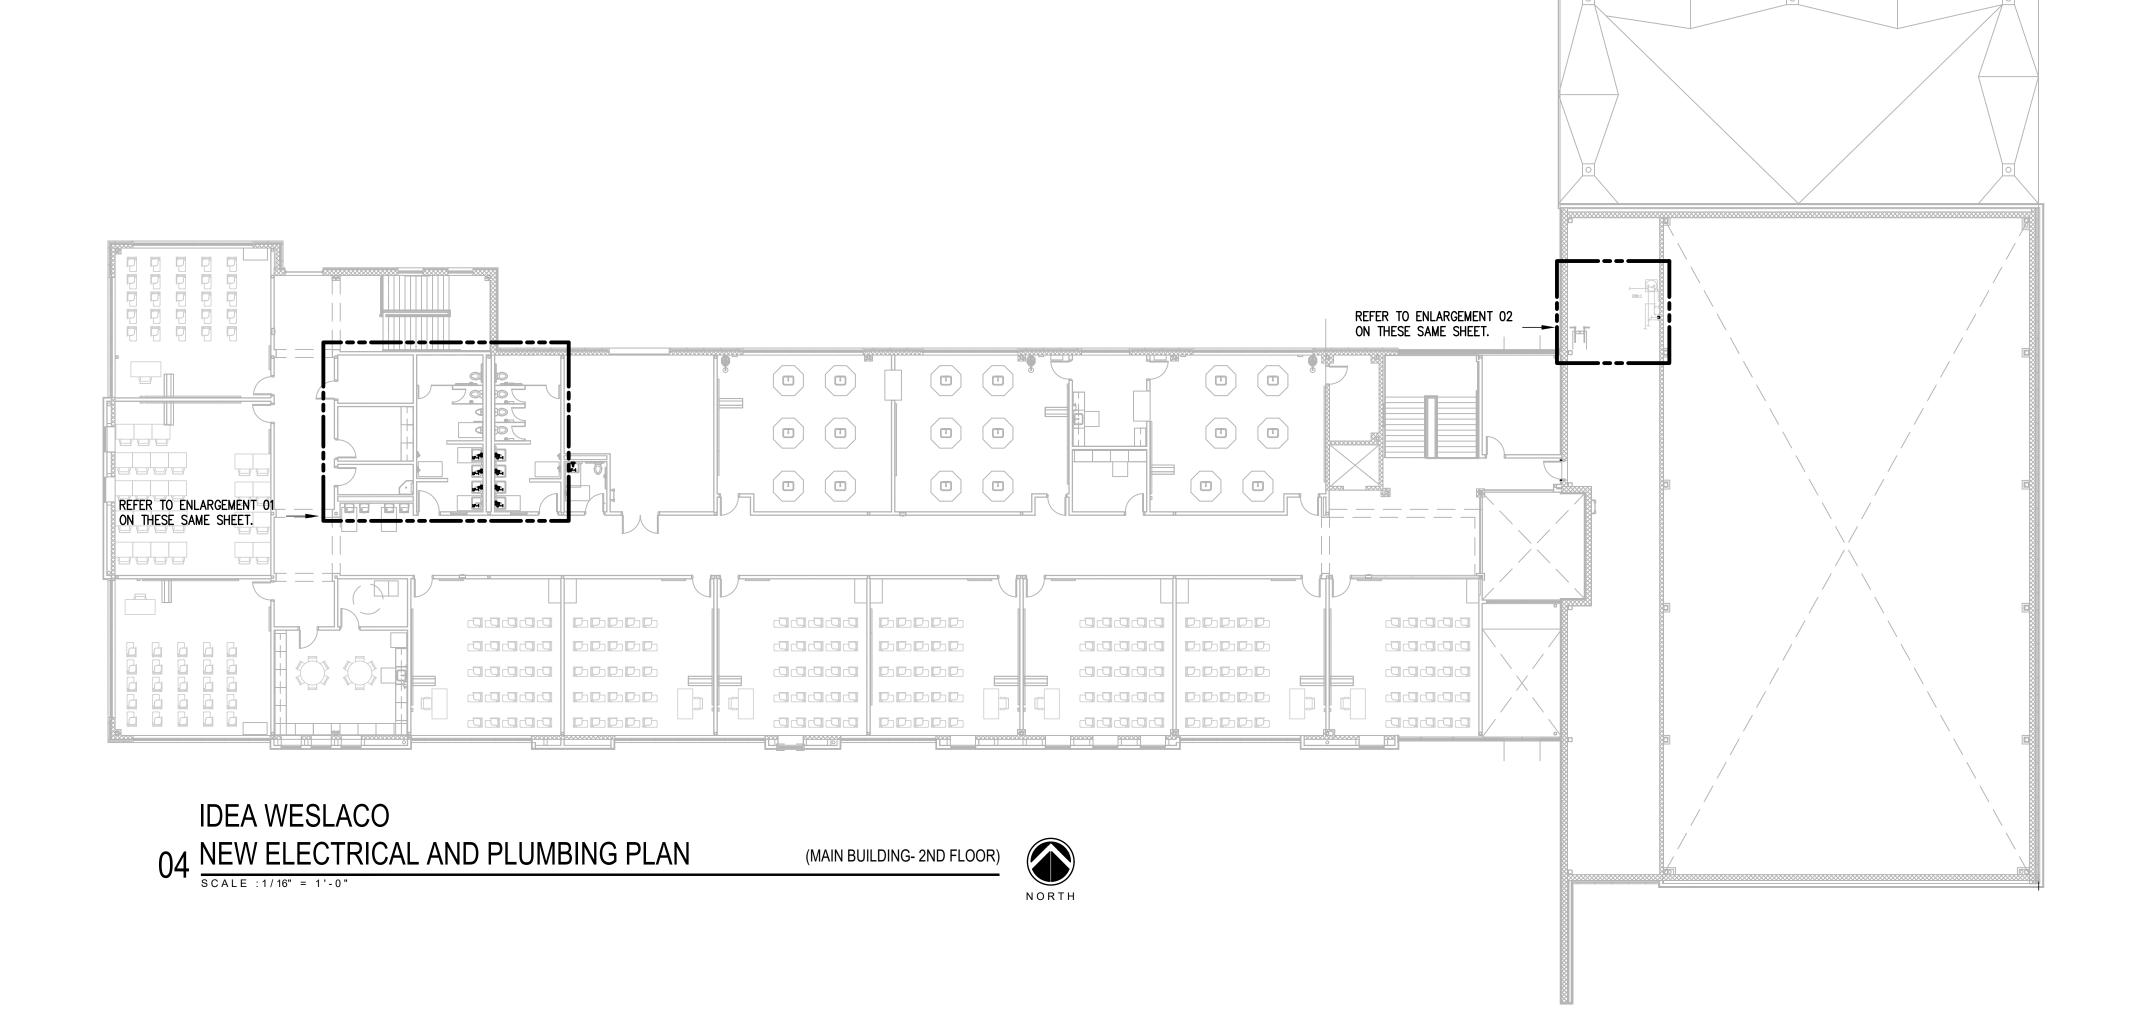

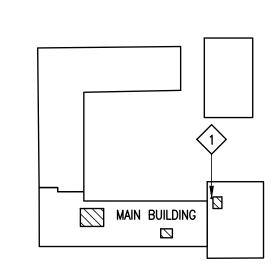

WESLACO IDEA ACADEMY **KEYPLAN** 

CSP # 27-LRPU-0424

P7.05

| PLUN        | IBING FIXTURE SCH   | EDULE   |       |      |      |      |       |         |
|-------------|---|---|-------|------|------|------|-------|---------|
| Project: II | DEA PS PLUMBING UPGRADES AT                               | LOWER RGV CAMPUSES  |       |      |      |      |       |         |
|             | MANUFACTURER &  |   |       |      |      |      |       |         |
| MARK        | MODEL NUMBER  | DESCRIPTION   | WASTE | VENT | CW   | HVV  | NOTES | REMARKS |
| LF-1        | SLOAN OPTIMA<br>#EBF-615-4-BAT-BDM-CP-0.50GPM-<br>MLM-FCT | MOUTING TYPE: SINGLE HOLE, ADA COMPLIANT, WATER USAGE AND BATTERY STRENGTH REPORTING, WIRELESS SETTINGS ADJUSTMENT, COMMERCIAL GRADE FAUCET, POWER SUPPLY BATERRY, FLOW RATE 0.5GPM, SPRAY TIPE MULTILAMINAR, FINISH POLISHED CHROME, MIXER BELOW DECK MANUAL MIXING VALVE.   | -     | -    | 1/2" | 1/2" | -     | -       |
| TMV-1       | BRADLEY<br>S59-2025 (TMV25)                               | LEAD-FREE BRASS DESIGN, RELIABLE LIQUID-FILLED THERMOSTAT, INTEGRAL STRAINER CHECKSTOPS ON INLETS, ADJUSTABLE SET POINT WITHIN TEMPERATURE RANGE, ACCURATE TEMPERATURE CONTROL, POSITIVE SHUTOFF OF HOT SUPPLY WHEN COLD SUPPLY IS LOST, EASY INSTALLATION AND SERVICEABILITY, DIRT AND LIME RESISTANT, FACTORY ASSEMBLED AND TESTED. | -     | -    | 3/4" | 3/4" | -     | -       |

| CIRCULATING PUMP SCHEDULE                                |                     |        |          |     |               |      |         |     |                        |          |                 |       |                          |
|--|---------------------|--------|----------|-----|---------------|------|---------|-----|------------------------|----------|-----------------|-------|--------------------------|
| Project: IDEA PS PLUMBING UPGRADES AT LOWER RGV CAMPUSES |                     |        |          |     |               |      |         |     |                        |          |                 |       |                          |
| MARK   | TYPE                | SERVES | LOCATION | GPM | HEAD<br>FT WG |      | I RPM I |     | IMPELLER<br>DIA. (IN.) |          | WEIGHT<br>(LBS) | NOTES | MANUFACTURE<br>AND MODEL |
| CP-1   | CIRCULATING<br>PUMP | EWH-1  | SEE PLAN | 5   | 20            | 1/12 | 3300    | 1.5 | 3                      | 115-1-60 | 13              | ALL   | BELL & GOSSET<br>PL-30B  |

NOTES:

. PROVIDE BRONZE BOOSTER BODY.

PUMPS SHALL BE OPERATED AND CONTROLLED THRU TIME CLOCK AND THRU AQUASTAT. COORDINATE WITH


3. REFER TO DETAIL SHEET FOR MORE INFORMATION.



)2 TMV-1



03 \_\_\_\_\_

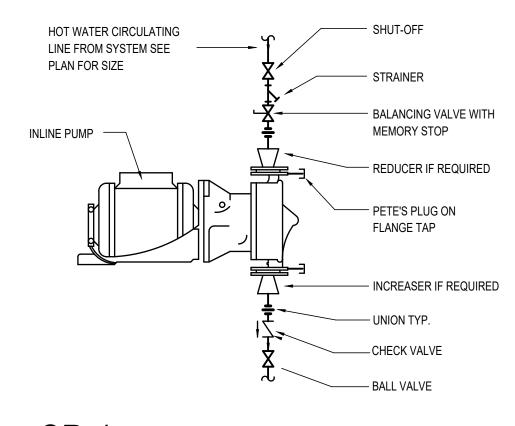

CP-1
CIRCULATING PUMP
SCHEMATIC & DETAIL

SCALE: NOT TO SCALE



14 LF-1